

US Army Corps
of Engineers®

MOBILE DISTRICT
109 SAINT JOSEPH STREET
MOBILE AL 36602

DESIGN BUILD FY-19 FIRE STATION #2

TYNDALL AIR FORCE BASE, FLORIDA
BAY COUNTY, FLORIDA

MATOC TASK ORDER

MOBILE DISTRICT PROJECT CODE : MEF19013

RFP NUMBER : W9127819SFHZ0005

AUGUST 2019

DRAWING ABBREVIATIONS

G	A		CONST	CONSTRUCTION	FUR	FURRING
	A LABEL	A LABEL CLASS DOOR	CONT	CONTINUOUS	FWC	FABRIC WALLCOVERING
	A/C	AIR CONDITIONING UNIT	COORD	COORDINATE	G	
	AB	ANCHOR BOLT	CORR	CORRIDOR	GA	GAUGE
	ABDN	ABANDON	CP	CONCRETE PIPE	GAL	GALLON
	ACC	ACCESSIBLE	CPT	CARPET	GALV	GALVANIZED
	ACI	AMERICAN CONCRETE INSTITUTE	CR	CONTROL ROOM	GB	GRAB BAR
	ACOUST	ACOUSTIC(AL)	CS	CAST STONE	GFCI	GOVERNMENT FURNISHED / CONTRACTOR INSTALLED
	ACP	ACOUSTICAL CEILING PANEL	CSWK	CASEWORK		
	ACS	AUTOMATIC CONTROL SYSTEM	CT	CERAMIC TILE	GFCMU	GROUND FACE CONCRETE MASONRY UNIT
F	ACT	ACOUSTICAL CEILING TILE	CTB	CERAMIC TILE - BASE	GL	GRID LINE
	ACU	AIR CONDITIONING UNIT	CTF	CERAMIC TILE - FLOOR	GLZ	GLAZING
	ADA	AMERICANS WITH DISABILITIES ACT	CTR	CENTER	GR FL	GROUND FLOOR
			CTW	CERAMIC TILE - WALL	GRGTG	GRATING
	ADD	ADDITIONAL	CU FT	CUBIC FEET	GS	GRATING SUPPORT
	ADMIN	ADMINISTRATION	CW	CASEMENT WINDOW	GV	GRAVEL
	AFF	ABOVE FINISH FLOOR	CWT	CERAMIC WALL TILE	GWB	GYPSUM WALL BOARD
	AFG	ABOVE FINISH GRADE	D		GYP	GYPSUM
	AHU	AIR HANDLING UNIT	D	DEPTH	H	
	AIB	AIR INFILTRATION BARRIER	D LABEL	D LABEL CLASS DOOR	H	HORN
E	AISC	AMERICAN INSTITUTE OF STEEL CONSTRUCTION	DBL	DOUBLE	HB	HOSE BIB
			DEMO	DEMOLISH	HC	HOLLOW CORE
	ALT	ALTERNATE	DEPT	DEPARTMENT	HDPE	HIGH DENSITY POLYETHYLENE
	ALUM	ALUMINUM	DET	DETAIL	HDW	HARDWARE
	ANOD	ANODIZE	DF	DRINKING FOUNTAIN	HDWD	HARDWOOD
	APPROX	APPROXIMATE(LY)	DIA	DIAMETER	HEPA	HIGH EFFICIENCY PARTICULATE AIR FILTER
	APVD	APPROVED	DIAG	DIAGONAL	HGT	HEIGHT
	AR	AS REQUIRED	DIM	DIMENSION	HK	HOOK
	ARCH	ARCHITECT(URAL)	DIST	DISTANCE	HM	HOLLOW METAL
	ASC	ABOVE SUSPENDED CEILING	DK	DECK	HORIZ	HORIZONTAL
D	ASSY	ASSEMBLY	DN	DOWN	HT	HEIGHT
	ATFP	ANTI-TERRORISM / FORCE PROTECTION	DOC	DOCUMENT	HVAC	HEATING VENTILATION AND AIR CONDITIONING
	AVG	AVERAGE	DR	DOOR		
	AW	ARCHITECTURAL WOODWORK	DS	DOWNSPOUT	HW, HDWR	HARDWARE
	AWT	ACOUSTICAL WALL TREATMENT	DWG(S)	DRAWING(S)	HYD	HYDRAULIC
	B		E		I	
	B LABEL	B LABEL CLASS DOOR	E	EAST	IBC	INTERNATIONAL BUILDING CODE
	BALC	BALCONY	E LABEL	E LABEL CLASS DOOR	ICF	INSULATED CONCRETE FORM
	BB	BASEBOARD	EA	EACH	IF	INSIDE FACE
	BD	BOARD	EF	EACH FACE	IG	INSULATING GLASS
C	BFF	BELOW FINISH FLOOR	EIFS	EXTERIOR INSULATION AND FINISH SYSTEM	IJ	ISOLATION JOINT
	BHMA	BUILDER'S HARDWARE MANUFACTURER'S ASSOCIATION	EJ	EXPANSION JOINT	ILO	IN LIEU OF
	BL	BASELINE	EL	ELEVATOR	IN	INCH
	BLDG	BUILDING	ELEC	ELECTRIC(AL)	INCAND	INCANDESCENT
	BLKG	BLOCKING	ELEV	ELEVATION	INSUL	INSULATION
	BLT IN	BUILT-IN	ENGR	ENGINEER	IRP	INSULATED ROOF PANEL
	BM	BEAM	ENTR	ENTRY	ITG	INSULATED TEMPERED GLASS
	BN	BULLNOSE	EOG	EDGE OF GUTTER	IWP	INSULATED WALL PANEL
	BOF	BOTTOM OF FOOTING	EP	EXPLOSION PROOF	J	
	BOS	BOTTOM OF STEEL	EPS	EXPANDED POLYSTYRENE BOARD	J	JUNCTION BOX
B	BOT	BOTTOM	EQ	EQUAL	JAN	JANITOR
	BP	BUILDING PAPER	EQUIP	EQUIPMENT	JST	JOIST
	BRG	BEARING	EW	EACH WAY	JT	JOINT
	BRKT	BRACKET	EWC	ELECTRIC WATER COOLER	K	
	BSMT	BASEMENT	EXIST	EXISTING	KIT	KITCHEN
	BTWN	BETWEEN	EXP	EXPOSED	KPD	KEYPAD
	BUR	BUILT UP ROOF	EXP AB	EXPANSION ANCHOR BOLT	KPL	KICKPLATE
	C		EXPN	EXPANSION	L	
	C	CENTER POINT	EXPT	EXTERIOR PAINT	LAM	LAMINATE
	C CONC	CAST CONCRETE	EXT	EXTERIOR	LAV	LAVATORY
A	C LABLE	C LABEL CLASS DOOR	EXT GR	EXTERIOR GRADE	LBR	LUMBER
	C-C	CENTER TO CENTER	F		LBS	POUNDS
	CAB	CABLE	FA	FIRE ALARM	LDG	LANDING
	CATW	CATWALK	FAAP	FIRE ALARM ANNUNCIATOR PANEL	LF	LINEAR FOOT (FEET)
	CAV	CAVITY			LG	LONG
	CB	CEMENTITIOUS (BACKER) BOARD	FAS BD	FASCIA BOARD	LIB	LIBRARY
	CBB	CEMENTITIOUS BACKER BOARD	FC BRK	FACE BRICK	LIN	LINEAR
	CD	CONSTRUCTION DOCUMENT(S)	FCO	FLOOR CLEAN OUT	LKR	LOCKER
	CDW	CHILLED DRINKING WATER	FD	FLOOR DRAIN	LLH	LONG LEG HORIZONTAL
	CEM PLAS	CEMENT PLASTER	FDTN	FOUNDATION	LLV	LONG LEG VERTICAL


N	NORTH
NA	NOT APPLICABLE
ND	NAPKIN DISPOSAL
NDS	NAPKIN DISPENSER
NE	NORTH EAST
NFFA	NATIONAL FIRE PROTECTION ASSOCIATION
NIC	NOT IN CONTRACT
NO	NUMBER
NOM	NOMINAL
NP	NO PAINT
NRC	NOISE REDUCTION COEFFICIENT
NTS	NOT TO SCALE
NW	NORTHWEST
O	
O TO O	OUT TO OUT
OA	OVERALL
OC	ON CENTER
OCC	OCCUPANCY
OD	OUTSIDE DIAMETER
OFCl	OWNER FURNISHED CONTRACTOR INSTALLED
OFD	OVERFLOW DRAIN
OFF	OFFICE
OFOI	OWNER FURNISHED OWNER INSTALLED
OGL	OBSCURE GLASS
OPH	OPPOSITE HAND
OPNG	OPENING
OPP	OPPOSITE
OPQ	OPAQUE
OPR	OPERABLE
ORIG	ORIGINAL
OSB	ORIENTED STRAND BOARD
OTS	OPEN TO STRUCTURE
OWSJ	OPEN WEB STEEL JOINT
OZ	OUNCE
P	
PA	PUBLIC ADDRESS
PAR	PARAPET
PAT	PATTERN
PB	PULL BOX
PBD	PARTICLE BOARD
PCC	PRECAST CONCRETE
PCF	POUND PER CUBIC FOOT
PCT	PERCENT
PEMB	PRE-ENGINEERED METAL BUILDING
PERF	PERFORATED
PERM	PERIMETER
PERP	PERPENDICULAR
PH	PHASE
PIL	PILASTER
PL	PROPERTY LINE
PL GL	PLATE GLASS
PLAM	PLASTIC LAMINATE
PLAS	PLASTIC
PLBG	PLUMBING
PLG	PILING
PLYWD	PLYWOOD
PNL	PANEL
POC	POINT OF CONTACT
POLY	POLYSTYRENE
PP PL	PUSH/PULL PLATE
PR	PAIR
PRCST	PRECAST
PREFAB	PREFABRICATED
PRKG	PARKING
PS CONC	PRESTRESSED CONCRETE
PSF	POUNDS PER SQUARE FOOT
PSI	POUNDS PER SQUARE INCH
PT	PRESSURE TREATED
PTD	PAPER TOWEL DISPENSER
PTDR	PAPER TOWEL DISPENSER AND RECEPTACLE
PTN	PARTITION
PWR	POWER
Q	
QT	QUARRY TILE
QTY	QUANTITY
R	
R	RISER
RB	RUBBER BASE
RCP	REFLECTED CEILING PLAN
RD	ROOF DRAIN
REC	RECESSED
REF	REFERENCE
REFR	REFRIGERATOR
REM	REMOVABLE
REP	REPAIR
REQ	REQUIRE
REQ'D	REQUIRED
RESIL	RESILIENT
REV	REVISION
RF	RESILIENT FLOORING
RH	RIGHT HAND
RHR	RIGHT HAND REVERSE
RL	ROOF LEADER
RLG	RAILING
RM	ROOM
RO	ROUGH OPENING

RR	RESTROOM
RSD	ROLLING STEEL DOOR
RV	ROOF VENT
RVL	REVEAL
S	
S	SOUTH
S2S	SURFACE TWO SIDES
S4S	SURFACE FOUR SIDES
SAPC	SUSPENDED ACOUSTICAL PANEL CEILING
SATC	SUSPENDED ACOUSTICAL TILE CEILING
SB	SPLASH BLOCK
SC	SHOWER CURTAIN
SCHED	SCHEDULE
SCR	SHOWER CURTAIN ROD
SCW	SOLID CORE WOOD
SCWD	SOLID CORE WOOD DOOR
SD	SMOKE DETECTOR
SE	SOUTH EAST
SF	SQUARE FOOT
SF	SQUARE FEET
SFTWD	SOFT WOOD
SGL	SINGLE
SH	SOAP HOLDER
SHR	SHOWER
SHT MTL	SHEET METAL
SHTHG	SHEATHING
SHV	SHELVING
SIM	SIMILAR
SJ	SCORED JOINT
SKLT	SKYLIGHT
SLNT	SEALANT
SLR	SEALER
SM	SQUARE METER
SMHD	SHELF METAL HEAVY DUTY
SMK	SMOKE
SMLS	SEAMLESS
SND	SANITARY NAPKIN AND TAMPON DISPENSER
SP EL	SPOT ELEVATION
SPEC	SPECIFICATIONS
SPF	SPRAY APPLIED POLYURETHANE FOAM INSULATION
SQ	SQUARE
SQ FT	SQUARE FOOT (FEET)
SQ IN	SQUARE INCH
SQ M	SQUARE METER
SQ YD	SQUARE YARD
SS	STAINLESS STEEL
SSMR	STANDING SEAM METAL ROOF
ST	STAIRS
STC	SOUND TRANSMISSION CLASS
STD	STANDARD
STL	STEEL
STL JST	STEEL JOIST
STL RF DK	STEEL ROOF DECK
STOR	STORAGE
STR	STRINGER
STRB/HRN	STROBE / HORN
STRUCT	STRUCTURE(AL)
SUB FL	SUB FLOOR
SUSP	SUSPENDED
SV	SHEET VINYL
SW	SOUTHWEST
SYM	SYMMETRICAL
T	
T	TREAD
T&G	TONGUE AND GROOVE
T/S	TUB / SHOWER
TB	TOWEL BAR
TC	TERRA COTTA
TD	TRAVEL DISTANCE
TEL	TELEPHONE
TEMP	TEMPORARY
TER	TERRAZZO
TFF	TOP OF FINISH FLOOR
THK	THICKNESS
TK BD	TACK BOARD
TLT	TOILET
TMPD GL	TEMPERED GLASS
TN	TRUE NORTH
TOF	TOP OF FOOTING
TOM	TOP OF MASONRY
TOP	TOP OF PARAPET
TOPO	TOPOGRAPHY
TOS	TOP OF SLAB
TRANS	TRANSOM
TRTD	TREATED
TS	TUBE STEEL
TV	TELEVISION
TYP	TYPICAL
U	
UNF	UNFINISHED
UNO	UNLESS NOTED OTHERWISE
UR	URINAL
V	
VB	VAPOR BARRIER
VCT	VINYL COMPOSITION TILE

VERT	VERTICAL
VR	VAPOR RETARDER
VTC	VIDEO TELECONFERENCE
VTR	VENT THROUGH ROOF
W	
W	WEST
W/	WITH
W/O	WITHOUT
WC	WATER CLOSET
WD	WOOD
WG	WIRE GLASS
WOM	WALK OFF MAT
WR	WASTE RECEPTACLE
WRB	WEATHER RESISTANT BARRIER
WRGWB	WATER RESISTANT GYPSUM WALLBOARD
WS	WATER STOP
WTP	WATER TREATMENT PLANT
WWTP	WASTE WATER TREATMENT PLANT

INDEX OF DRAWINGS

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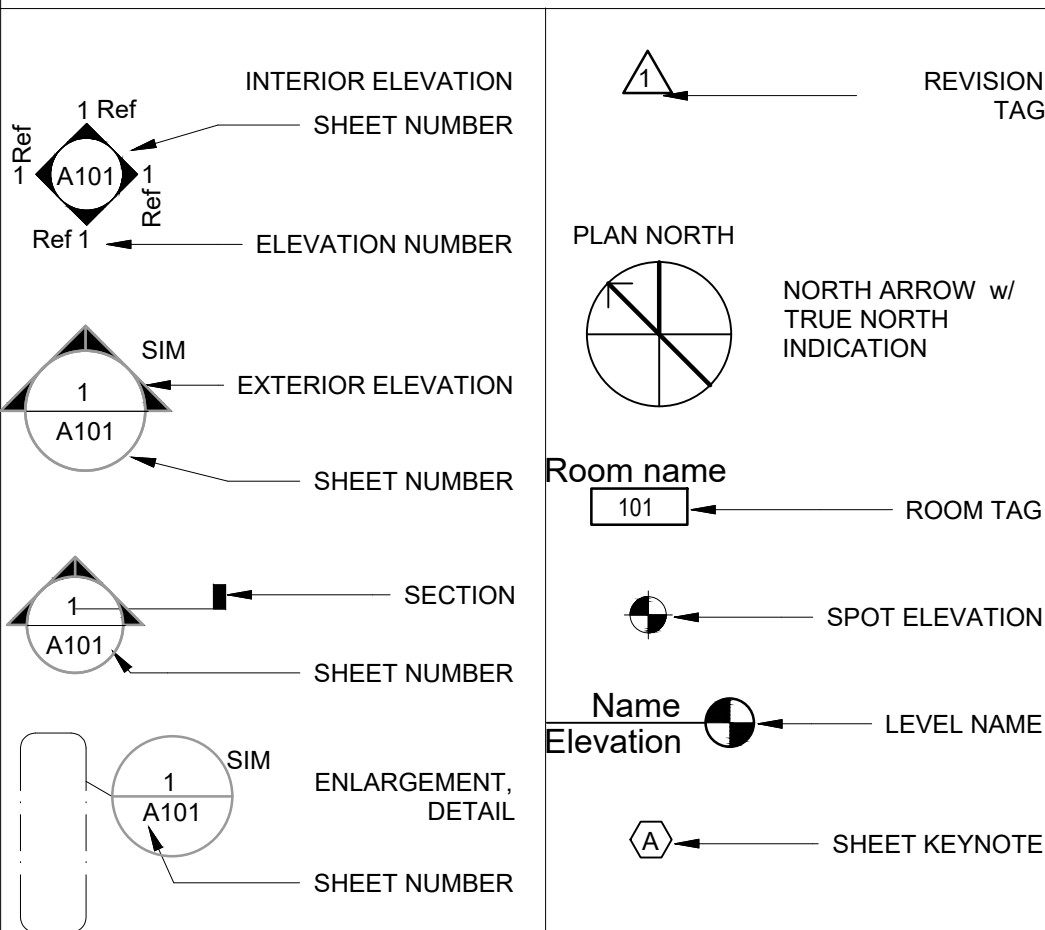


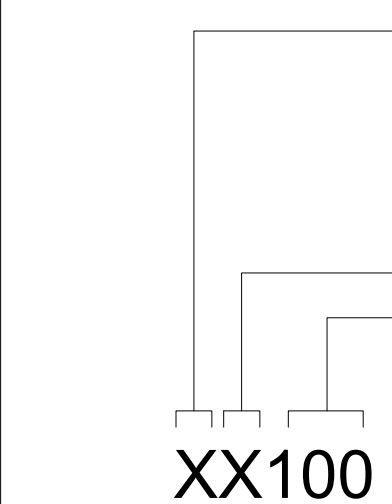DISCIPLINE:
C - CIVIL
L - LANDSCAPE
A - ARCHITECTURE
M - MECHANICAL
E - ELECTRICAL
P - PLUMBING
S - STRUCTURAL
K - FOOD SERVICE

- DISCIPLINE MODIFIER
- SHEET NUMBER WITHIN SERIES

REFER TO AEC CAD
STANDARDS FOR PROPER
SHEET NUMBERING

ANNOTATION CALLOUTS/DRAWING SYMBOLS

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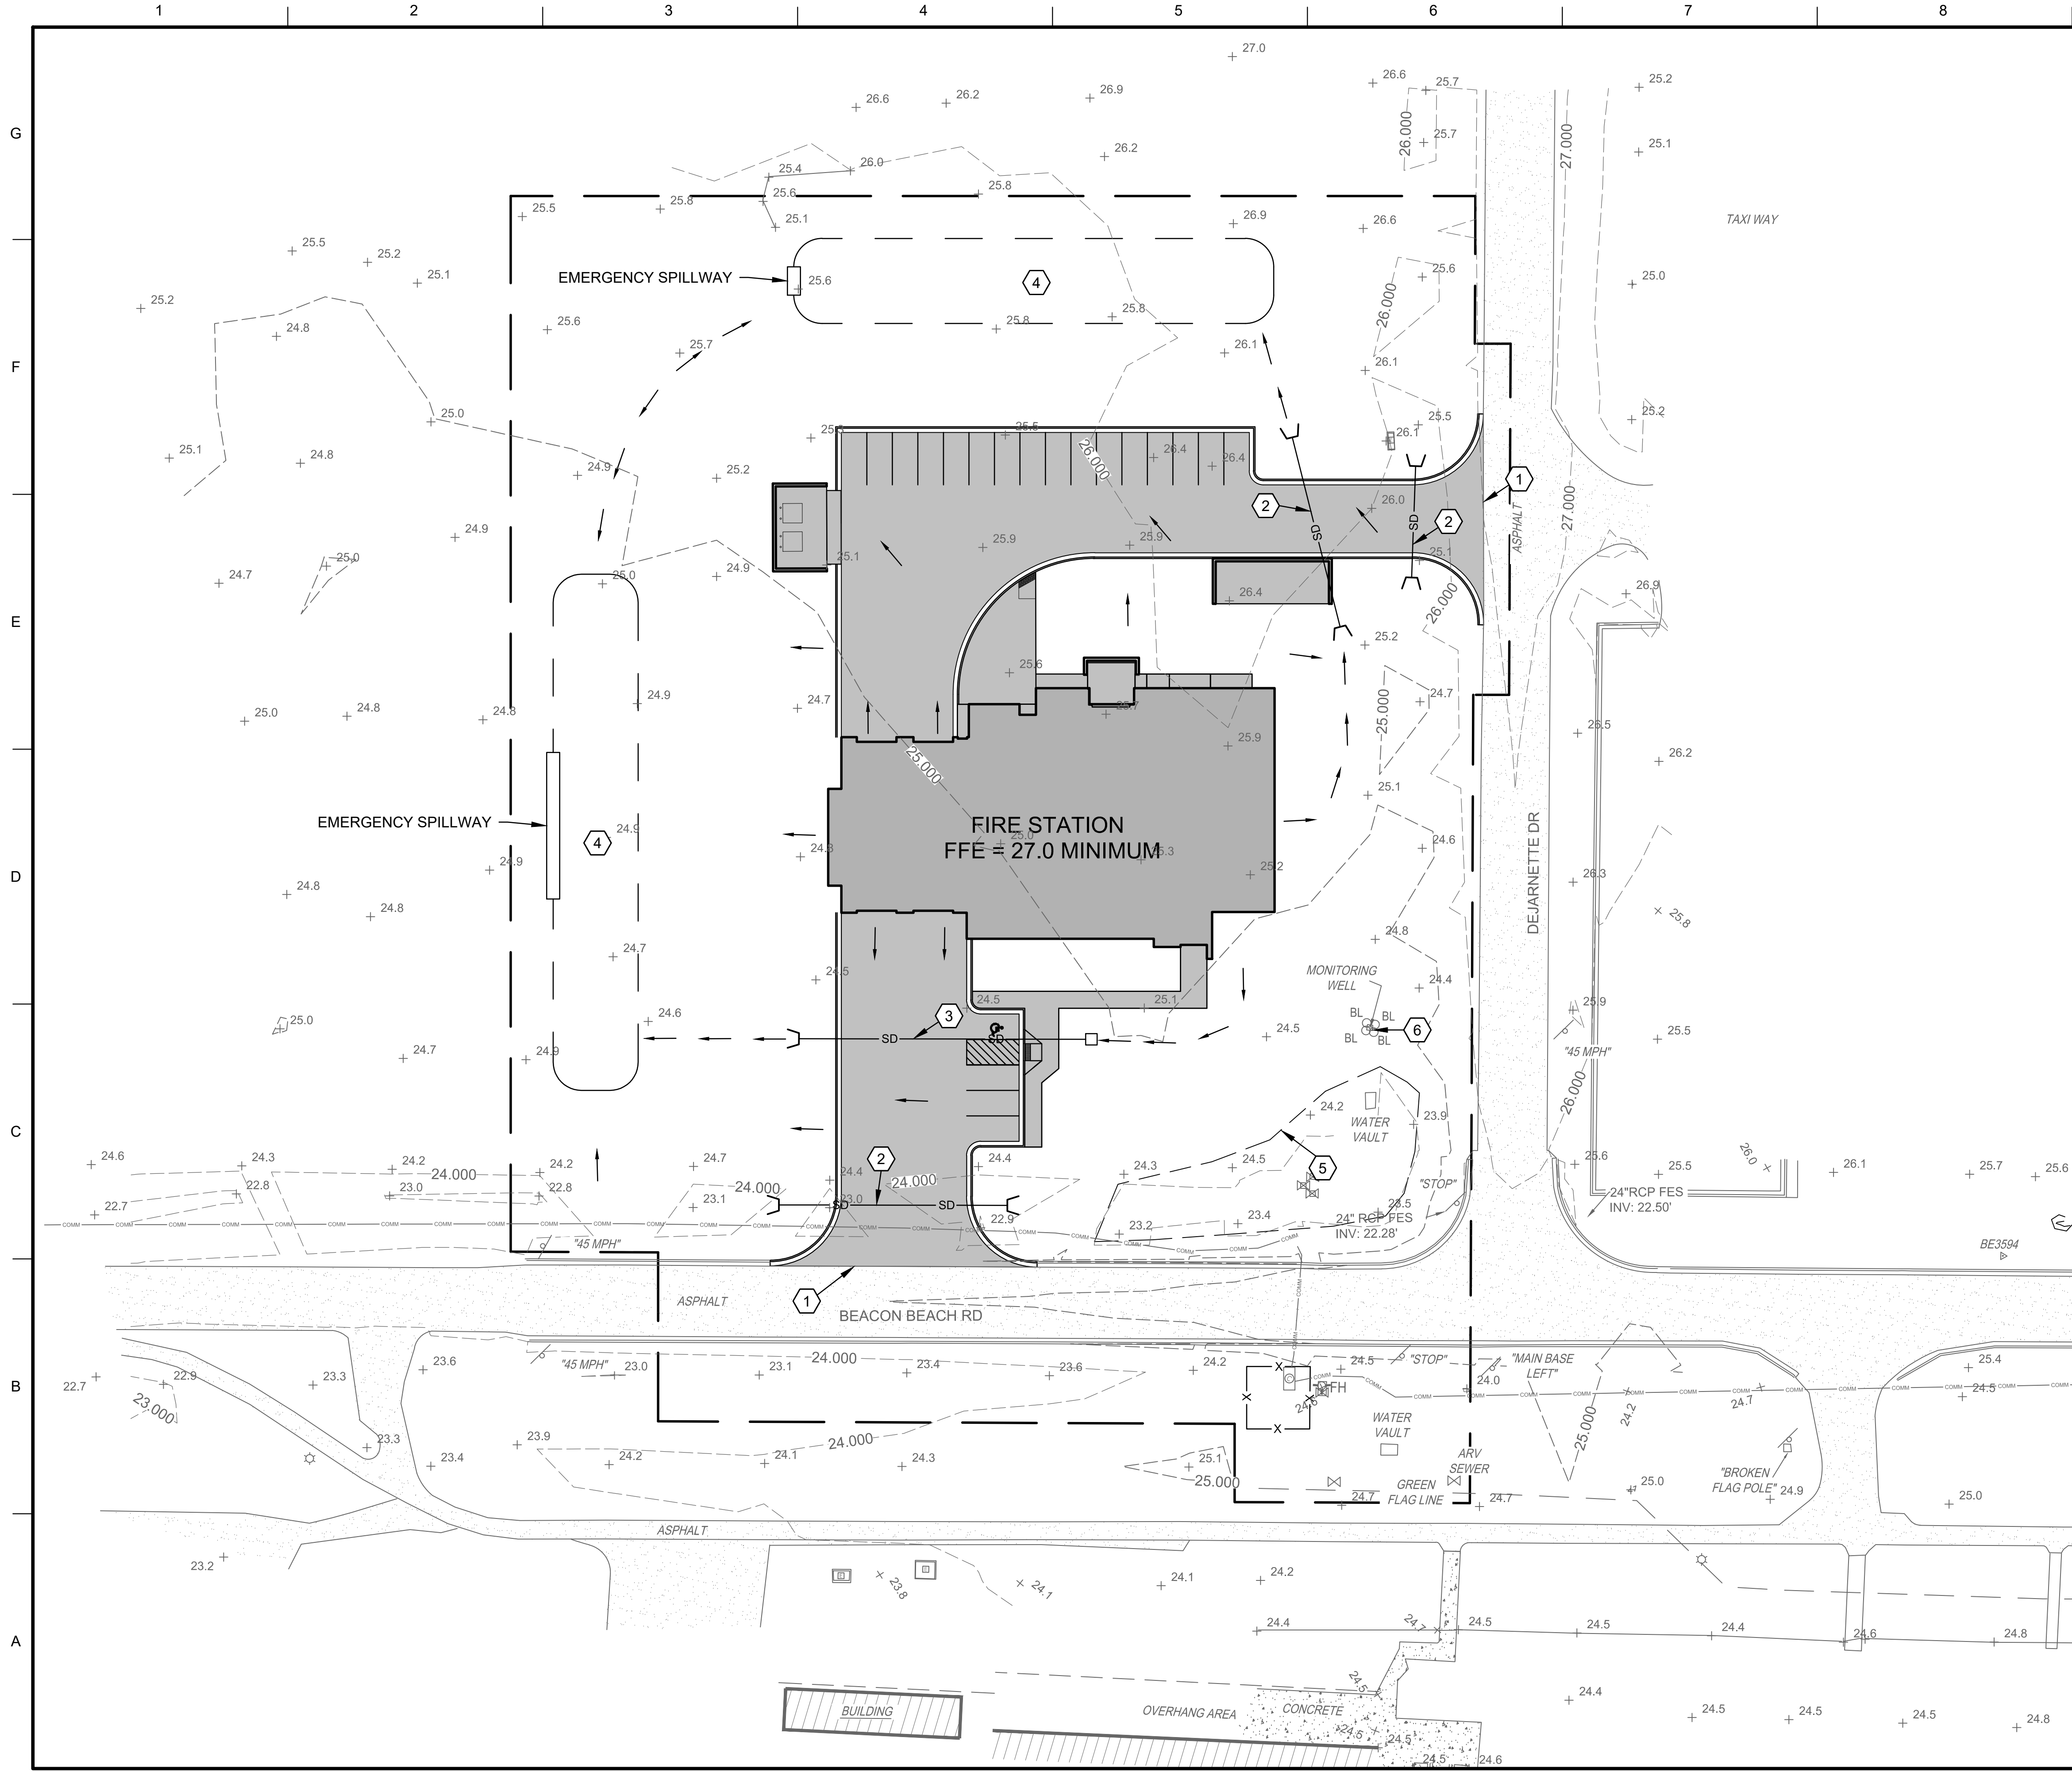
US ARMY CORPS OF ENGINEERS MOBILE DISTRICT 100 SAINT JOSEPH STREET MOBILE, ALABAMA	DESIGN BY: J. HUNSUCKER DATE: AUG 2019 PROJECT NO.: W9221H-16F002008 CONTRACT NO.: T. HOURIGAN C. BIAGI SUBMITTED BY: MASON & HANGER SIZE: A3 CAD CODE: ANSI D	ISSUE DATE: AUG 2019 PROJECT NO.: W9221H-16F002008 CONTRACT NO.: T. HOURIGAN C. BIAGI SUBMITTED BY: MASON & HANGER SIZE: A3 CAD CODE: ANSI D
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TYNDALL AFB, FL
CONSTRUCT FIRE STATION # 2
DESIGN-BUILD RFP
FY 2019, PNXLWU193005

SHEET ID

G-003

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GENERAL NOTES



- IF UXO IS ENCOUNTERED, THE CONTRACTOR SHALL EVACUATE PERSONNEL IN THE SURROUNDING AREA AND DIAL 911. UXO RISK LEVEL IS LOW.
- ROOF DRAINAGE SHALL BE PIPED TO STORM INLETS OR INFILTRATION AREAS.

SHEET NOTES

- MATCH EXISTING ELEVATION.
- PROVIDE STORM SEWER PIPE AND HEADWALLS.
- PROVIDE STORM SEWER PIPE, INLET, AND HEADWALL.
- PROVIDE STORMWATER INFILTRATION AS NEEDED.
- DO NOT DISTURB EXISTING ROADWAY RUNOFF MANAGEMENT FEATURE.
- DO NOT DISTURB EXISTING GROUND WATER MONITORING WELL.

LEGEND

- CONSTRUCTION LIMITS
- DRAINAGE PATTERN FLOW ARROW
- SD STORM SEWER PIPE
- STORMWATER INFILTRATION AREA
- EXISTING ROADWAY RUNOFF FEATURE

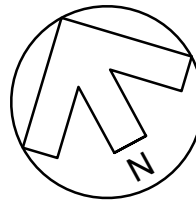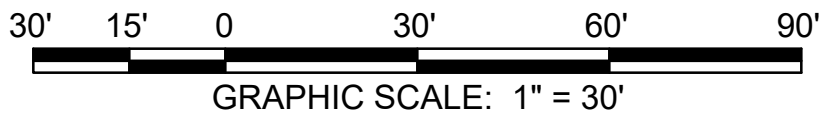

US Army Corps of Engineers

DATE	DESCRIPTION	MARK

DESIGNED BY:	ISSUE DATE:
G. LYNN	AUGUST 2019
DRAWN BY:	SOLICITATION NO.:
CHECKED BY:	181213STPZ005
SUBMITTED BY:	CONTRACT NO.:
MASON & HANGER	PROJECT NUMBER:
FILENAME:	MEF19013
ANSI D:	TYNFS Site.dwg

U.S. ARMY CORPS OF ENGINEERS	Mason & Hanger
MOBILE DISTRICT	181213STPZ005
108 SAINT JOSEPH STREET	MOBILE, ALABAMA


TYNDALL AFB, FL
CONSTRUCT FIRE STATION 2

FY 2019, PN XLWU193005

GRADING PLAN

SHEET ID

CG101

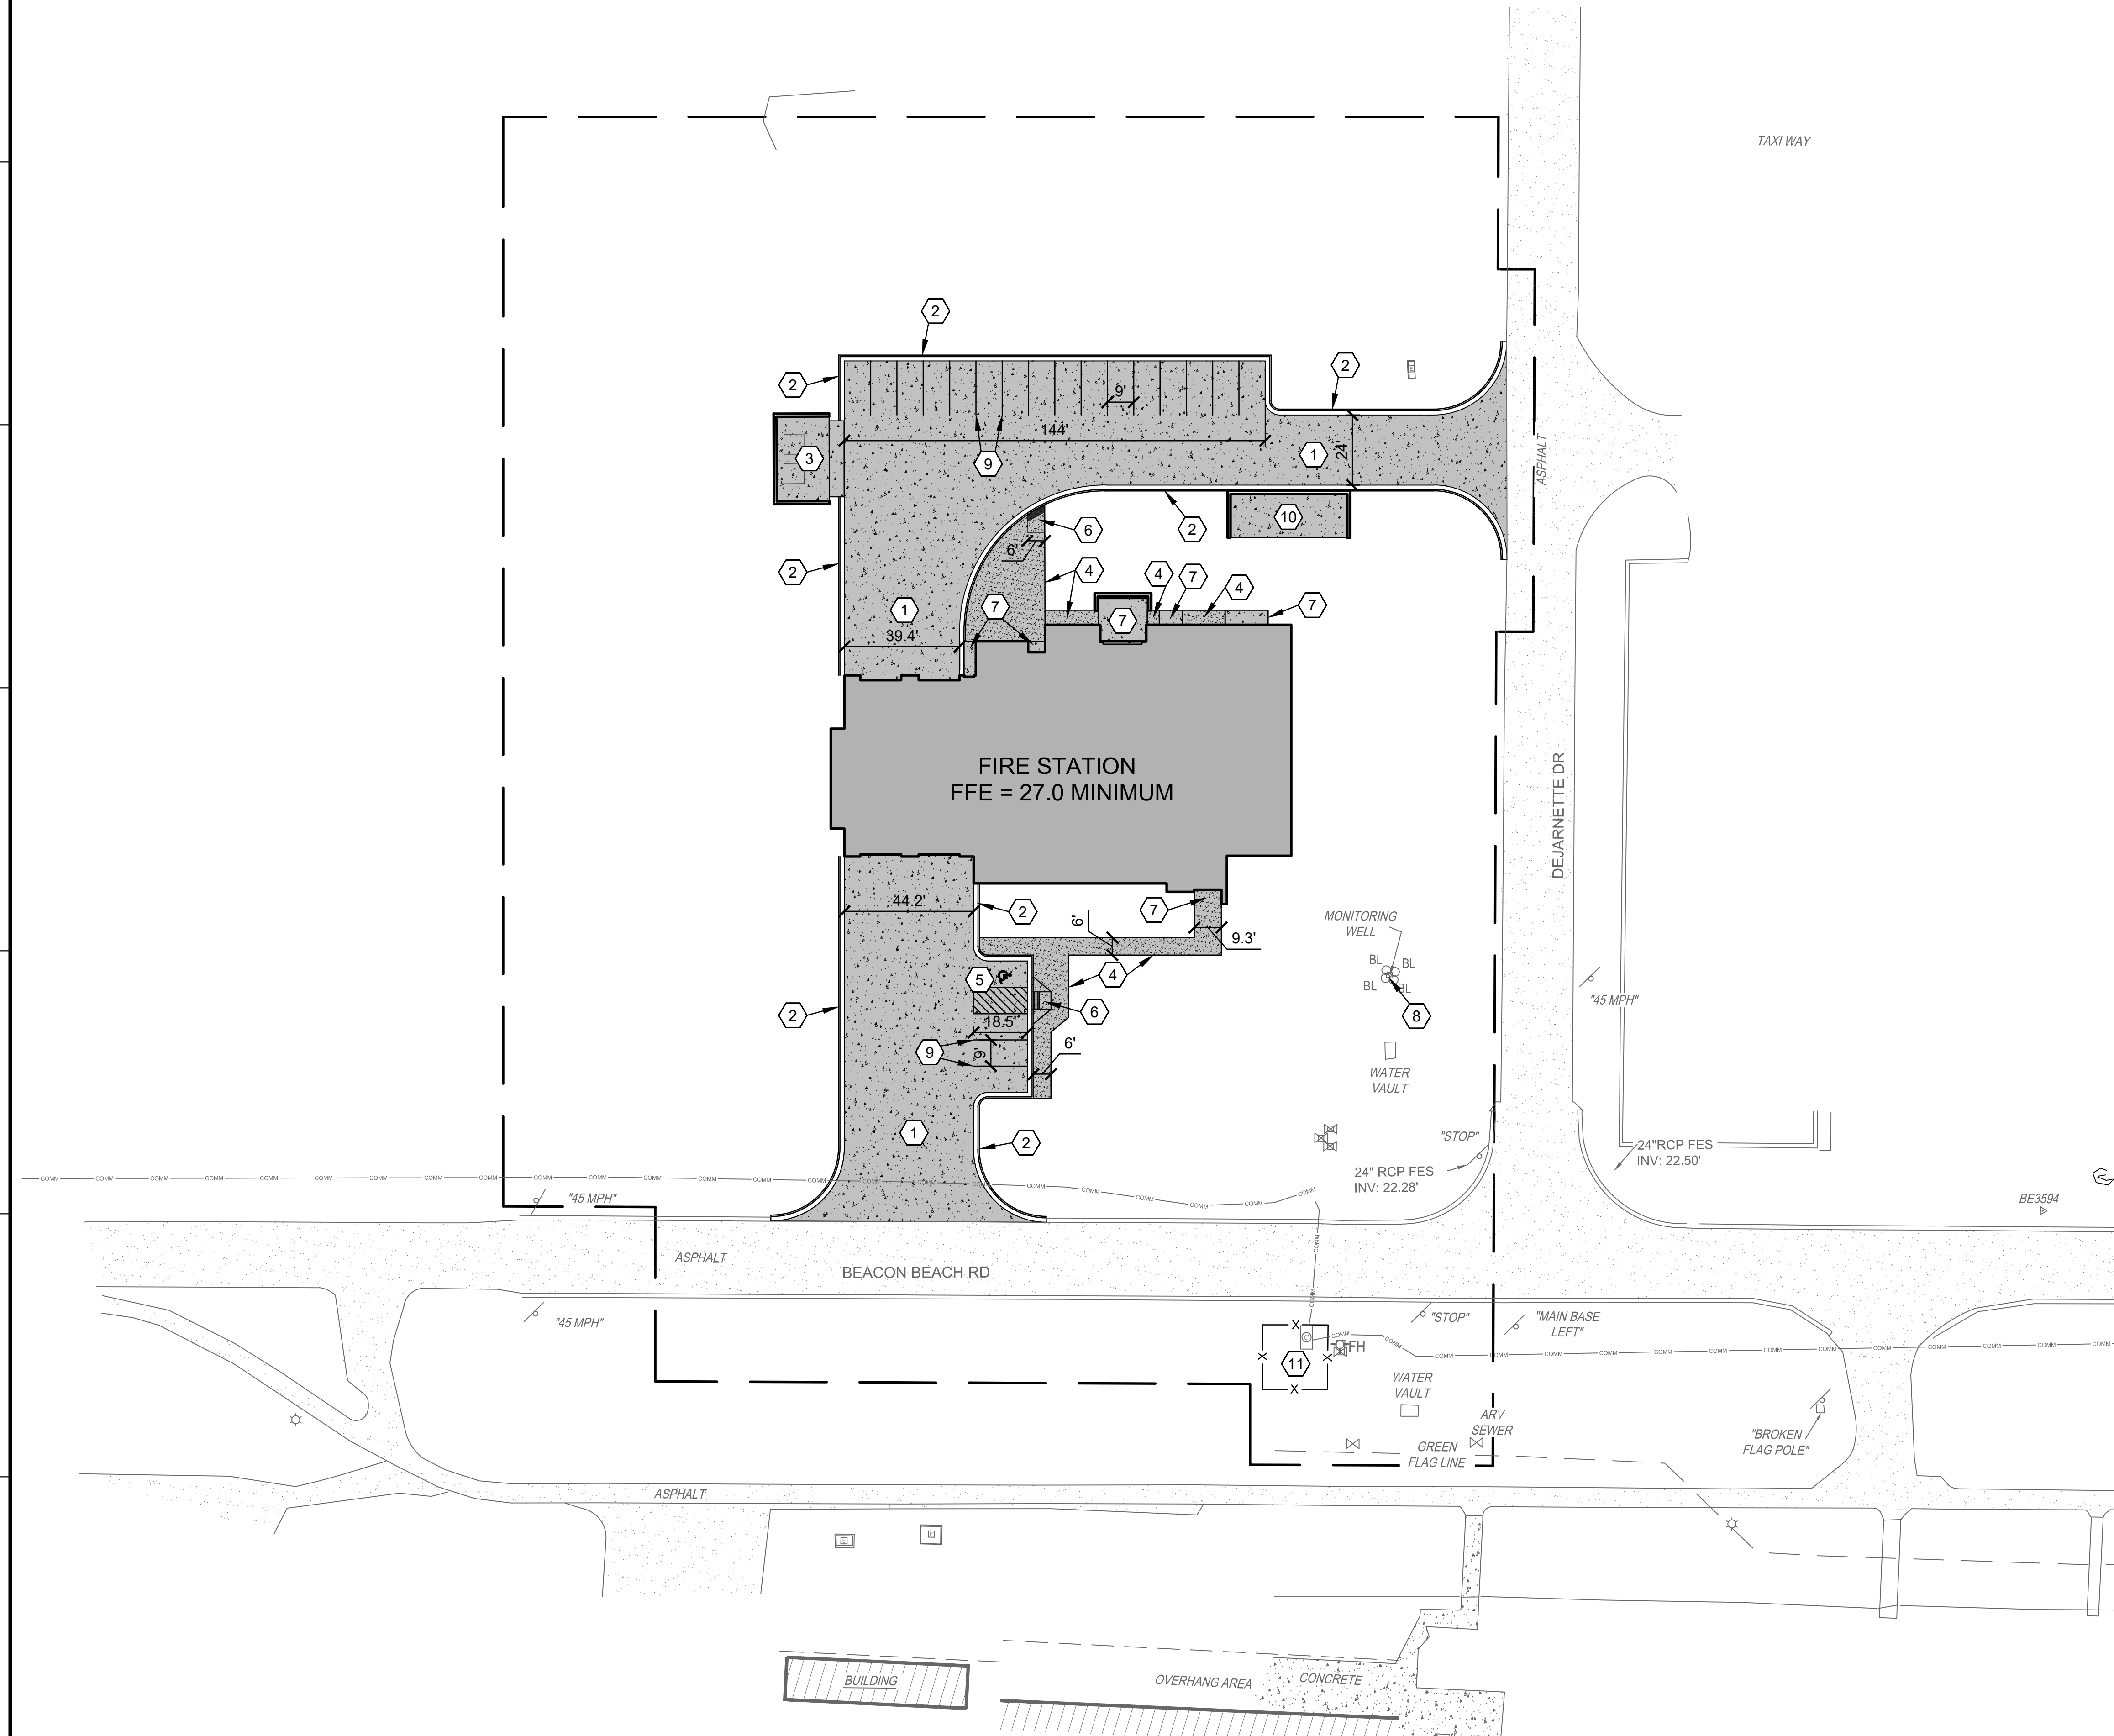

GENERAL NOTES



1. IF UXO IS ENCOUNTERED, THE CONTRACTOR SHALL EVACUATE PERSONNEL IN THE SURROUNDING AREA AND DIAL 911. UXO RISK LEVEL IS LOW.

SHEET NOTES

- 1 PROVIDE 6" MINIMUM CONCRETE PAVEMENT. DESIGN PAVEMENT THICKNESS FOR SOIL CLASSIFICATION AND WHEEL LOADING.
- 2 PROVIDE CONCRETE CURB AND GUTTER.
- 3 PROVIDE DOUBLE DUMPSTER ENCLOSURE WITH CONCRETE PAD, CMU WALLS TO MATCH FIRE STATION.
- 4 PROVIDE CONCRETE SIDEWALK.
- 5 PROVIDE HANDICAP PARKING MARKINGS AND SIGN.
- 6 PROVIDE SIDEWALK RAMP.
- 7 PROVIDE CONCRETE STOOPS AT ALL DOOR EXITS.
- 8 DO NOT DISTURB EXISTING GROUND WATER MONITORING WELL.
- 9 PROVIDE WHITE PAINTED PAVEMENT STRIPING.
- 10 PROVIDE CONCRETE MECHANICAL UTILITY PAD, 6' CMU WALLS TO MATCH FIRE STATION.
- 11 PROVIDE 6' CHAIN LINK FENCE WITH PERSONNEL GATE.


LEGEND

- CONSTRUCTION LIMITS
CONCRETE PAVEMENT

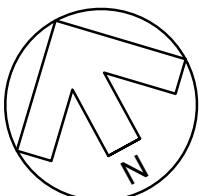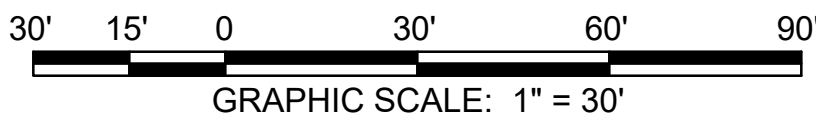

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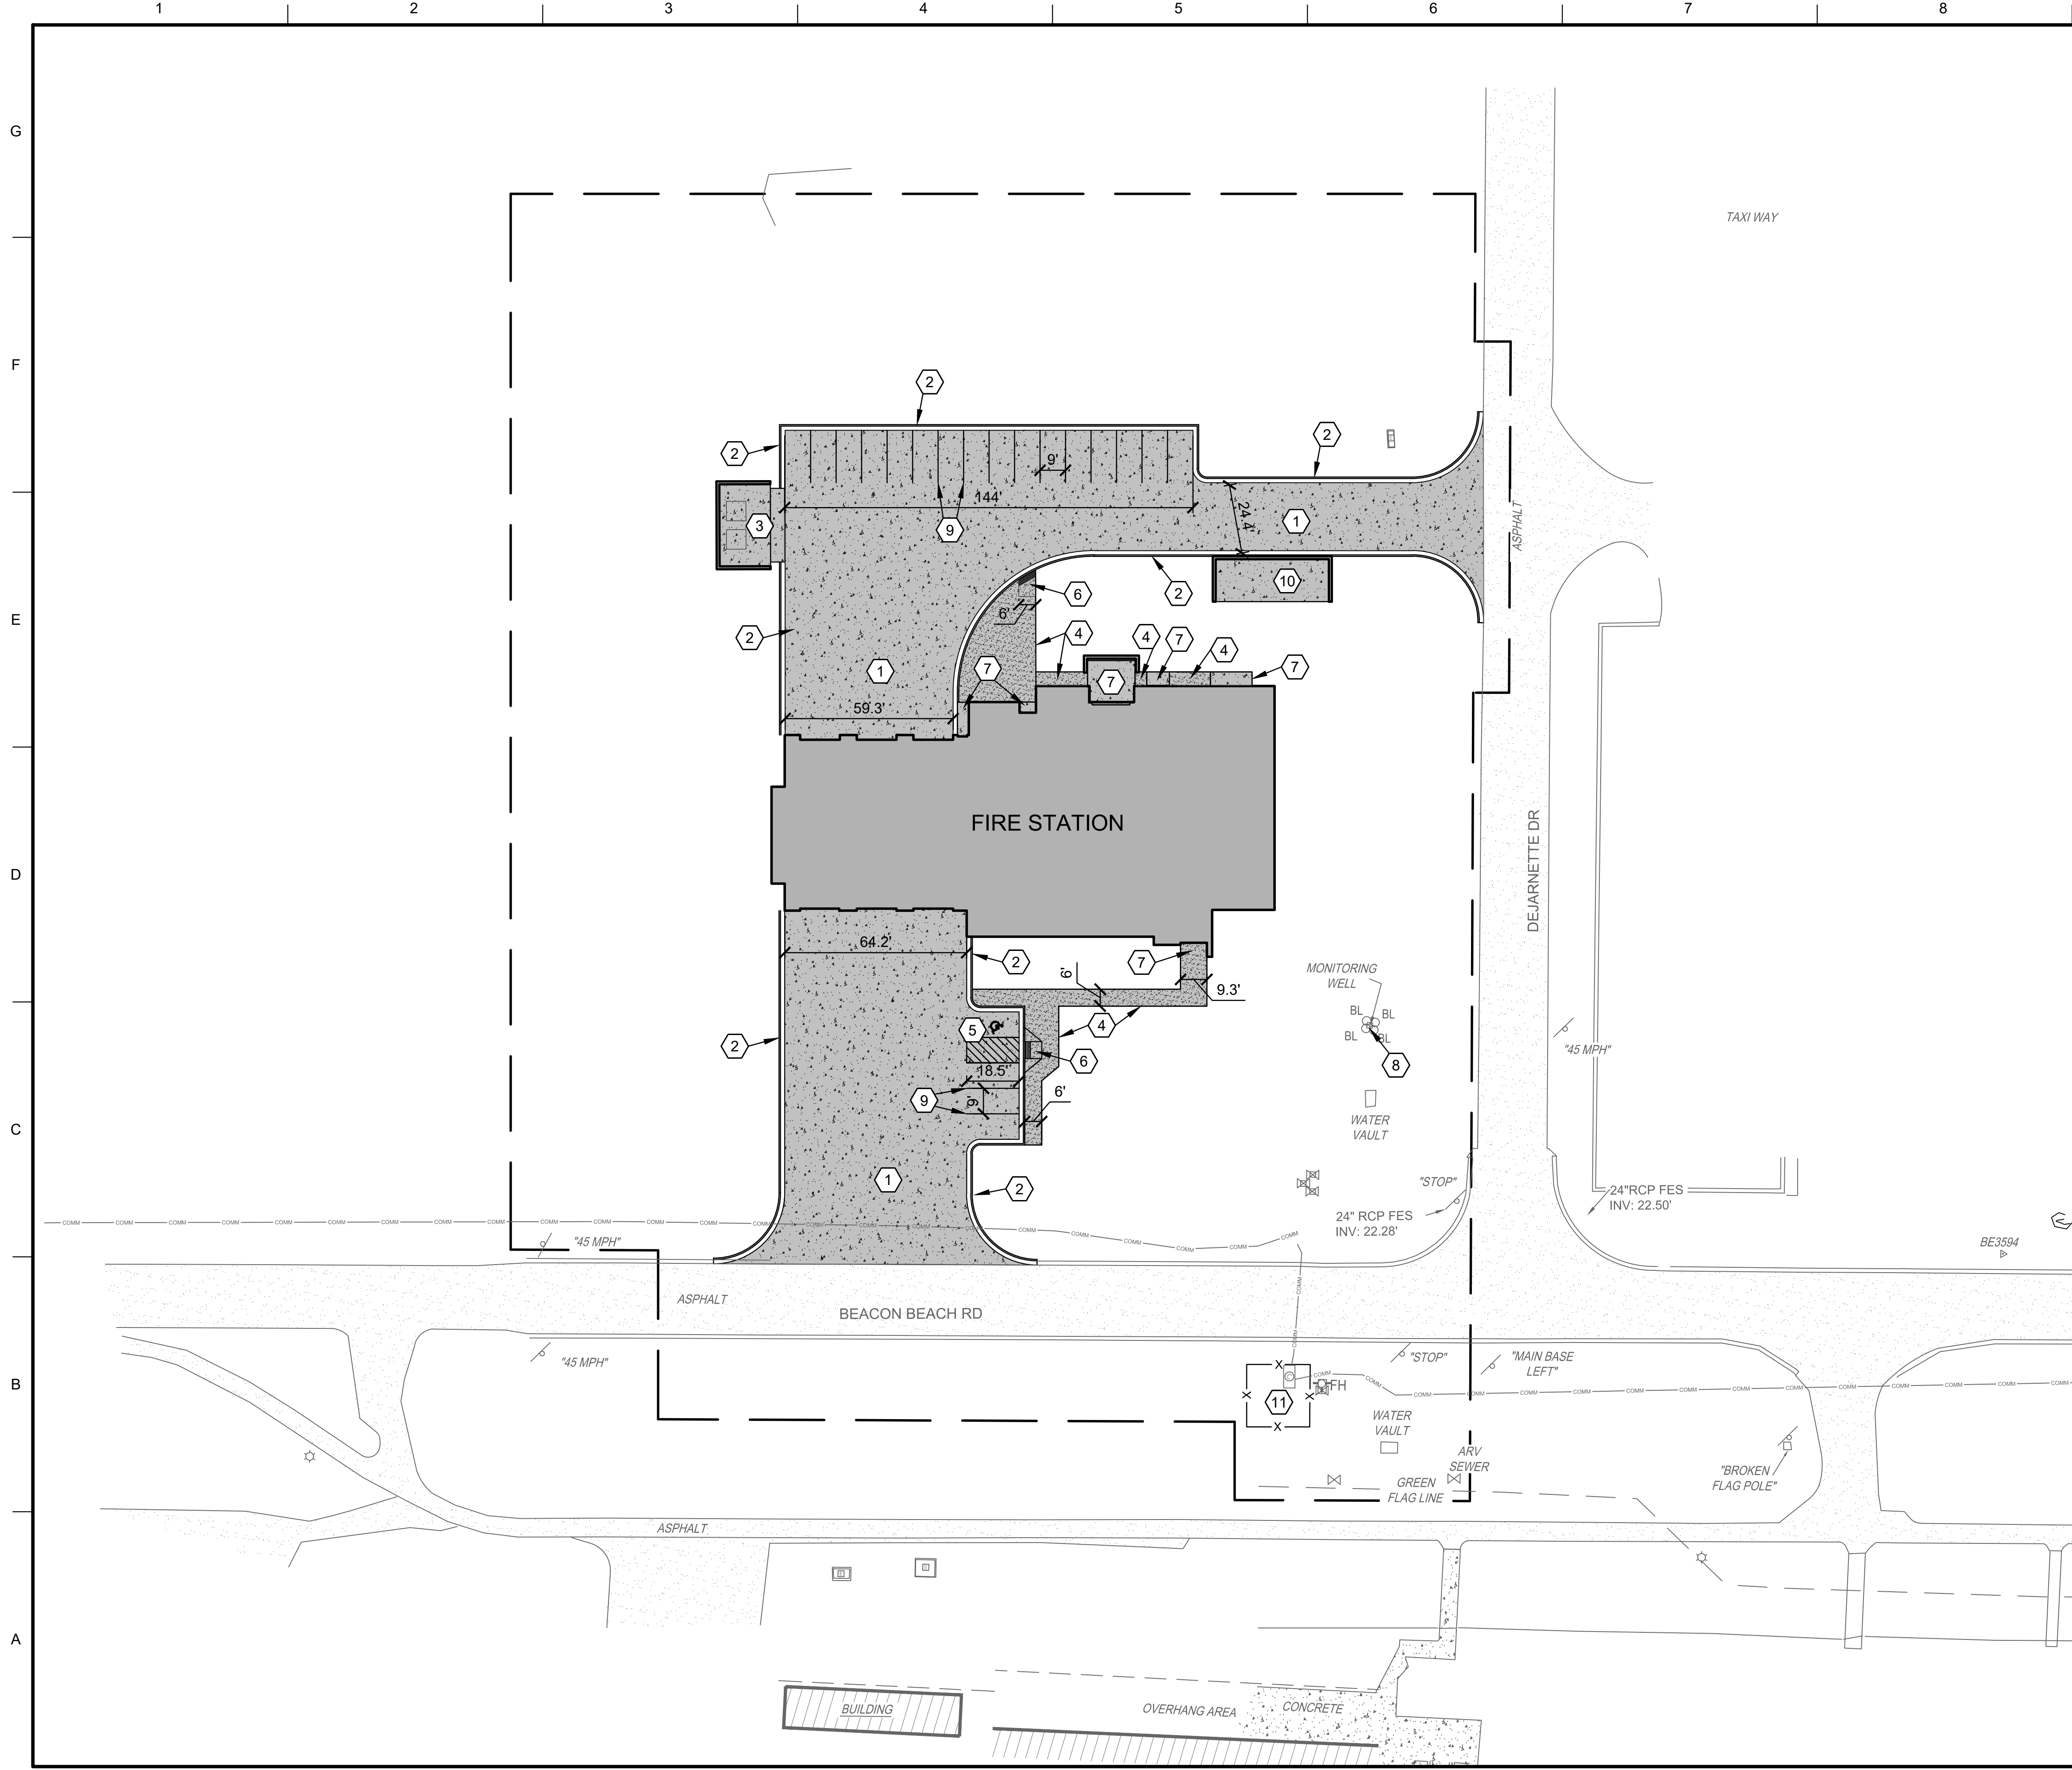
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 Mason & Hanger <i>Architects</i>	DESIGNED BY: G. LYNN MOBILE DISTRICT 109 SAINT JOSEPH STREET MOBILE, ALABAMA		ISSUE DATE: AUGUST 2019 PROJECT NO.: 309-271-1356-CH-0005	
	CHECKED BY: M. MAYER		CONTRACT NO.: 	
	SUBMITTED BY: T. LYNN		PROJECT NUMBER: ME17013	
	SIZE: 11" x 17"		FILE NAME: TYNFS Site.dwt	

TYNDALL AFB, FL
CONSTRUCT FIRE STATION 2
FY 2019, PN XLWU193005
BASE BID SITE PLAN

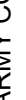SHEET ID
CS101

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GENERAL NOTES




1. IF UXO IS ENCOUNTERED, THE CONTRACTOR SHALL EVACUATE PERSONNEL IN THE SURROUNDING AREA AND DIAL 911. UXO RISK LEVEL IS LOW.

SHEET NOTES

- 1) PROVIDE 6" MINIMUM CONCRETE PAVEMENT. DESIGN PAVEMENT THICKNESS FOR SOIL CLASSIFICATION AND WHEEL LOADING.
- 2) PROVIDE CONCRETE CURB AND GUTTER.
- 3) PROVIDE DOUBLE DUMPSTER ENCLOSURE WITH CONCRETE PAD, CMU WALLS TO MATCH FIRE STATION.
- 4) PROVIDE CONCRETE SIDEWALK.
- 5) PROVIDE HANDICAP PARKING MARKINGS AND SIGN.
- 6) PROVIDE SIDEWALK RAMP.
- 7) PROVIDE CONCRETE STOOPS AT ALL DOOR EXITS.
- 8) DO NOT DISTURB EXISTING GROUND WATER MONITORING WELL.
- 9) PROVIDE WHITE PAINTED PAVEMENT STRIPING.
- 10) PROVIDE CONCRETE MECHANICAL UTILITY PAD, 6' CMU WALLS TO MATCH FIRE STATION.
- 11) PROVIDE 6' CHAIN LINK FENCE WITH PERSONNEL GATE.

LEGEND

- CONSTRUCTION LIMITS
- CONCRETE PAVEMENT

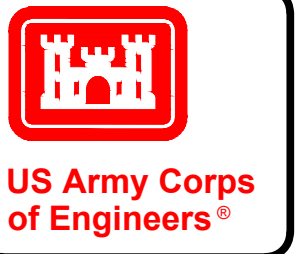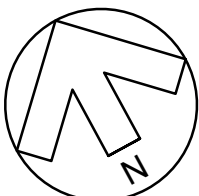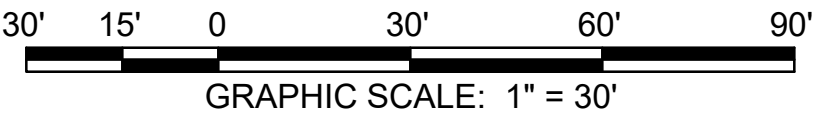


DATE	DESCRIPTION	MARK

DESIGNED BY: G. LYNN	ISSUE DATE: AUGUST 2019
DRAWN BY: M. MAYER	SOLICITATION NO.: W912DSTZ005
CHECKED BY: M. MAYER	CONTRACT NO.:
SUBMITTED BY: MASON & HANGER	PROJECT NUMBER: MEF19013
SIZE: ANSI D	FILENAME: TYNFS_Site.dwg
U.S. ARMY CORPS OF ENGINEERS MOBILE DISTRICT 108 SAINT JOSEPH STREET MOBILE, ALABAMA	

TYNDALL AFB, FL CONSTRUCT FIRE STATION 2
FY 2019, FN XLWU193005
BID SCHEDULE 2 SITE PLAN

SHEET ID CS101A

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Jul 17, 2019
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SHEET NOTES CONT.

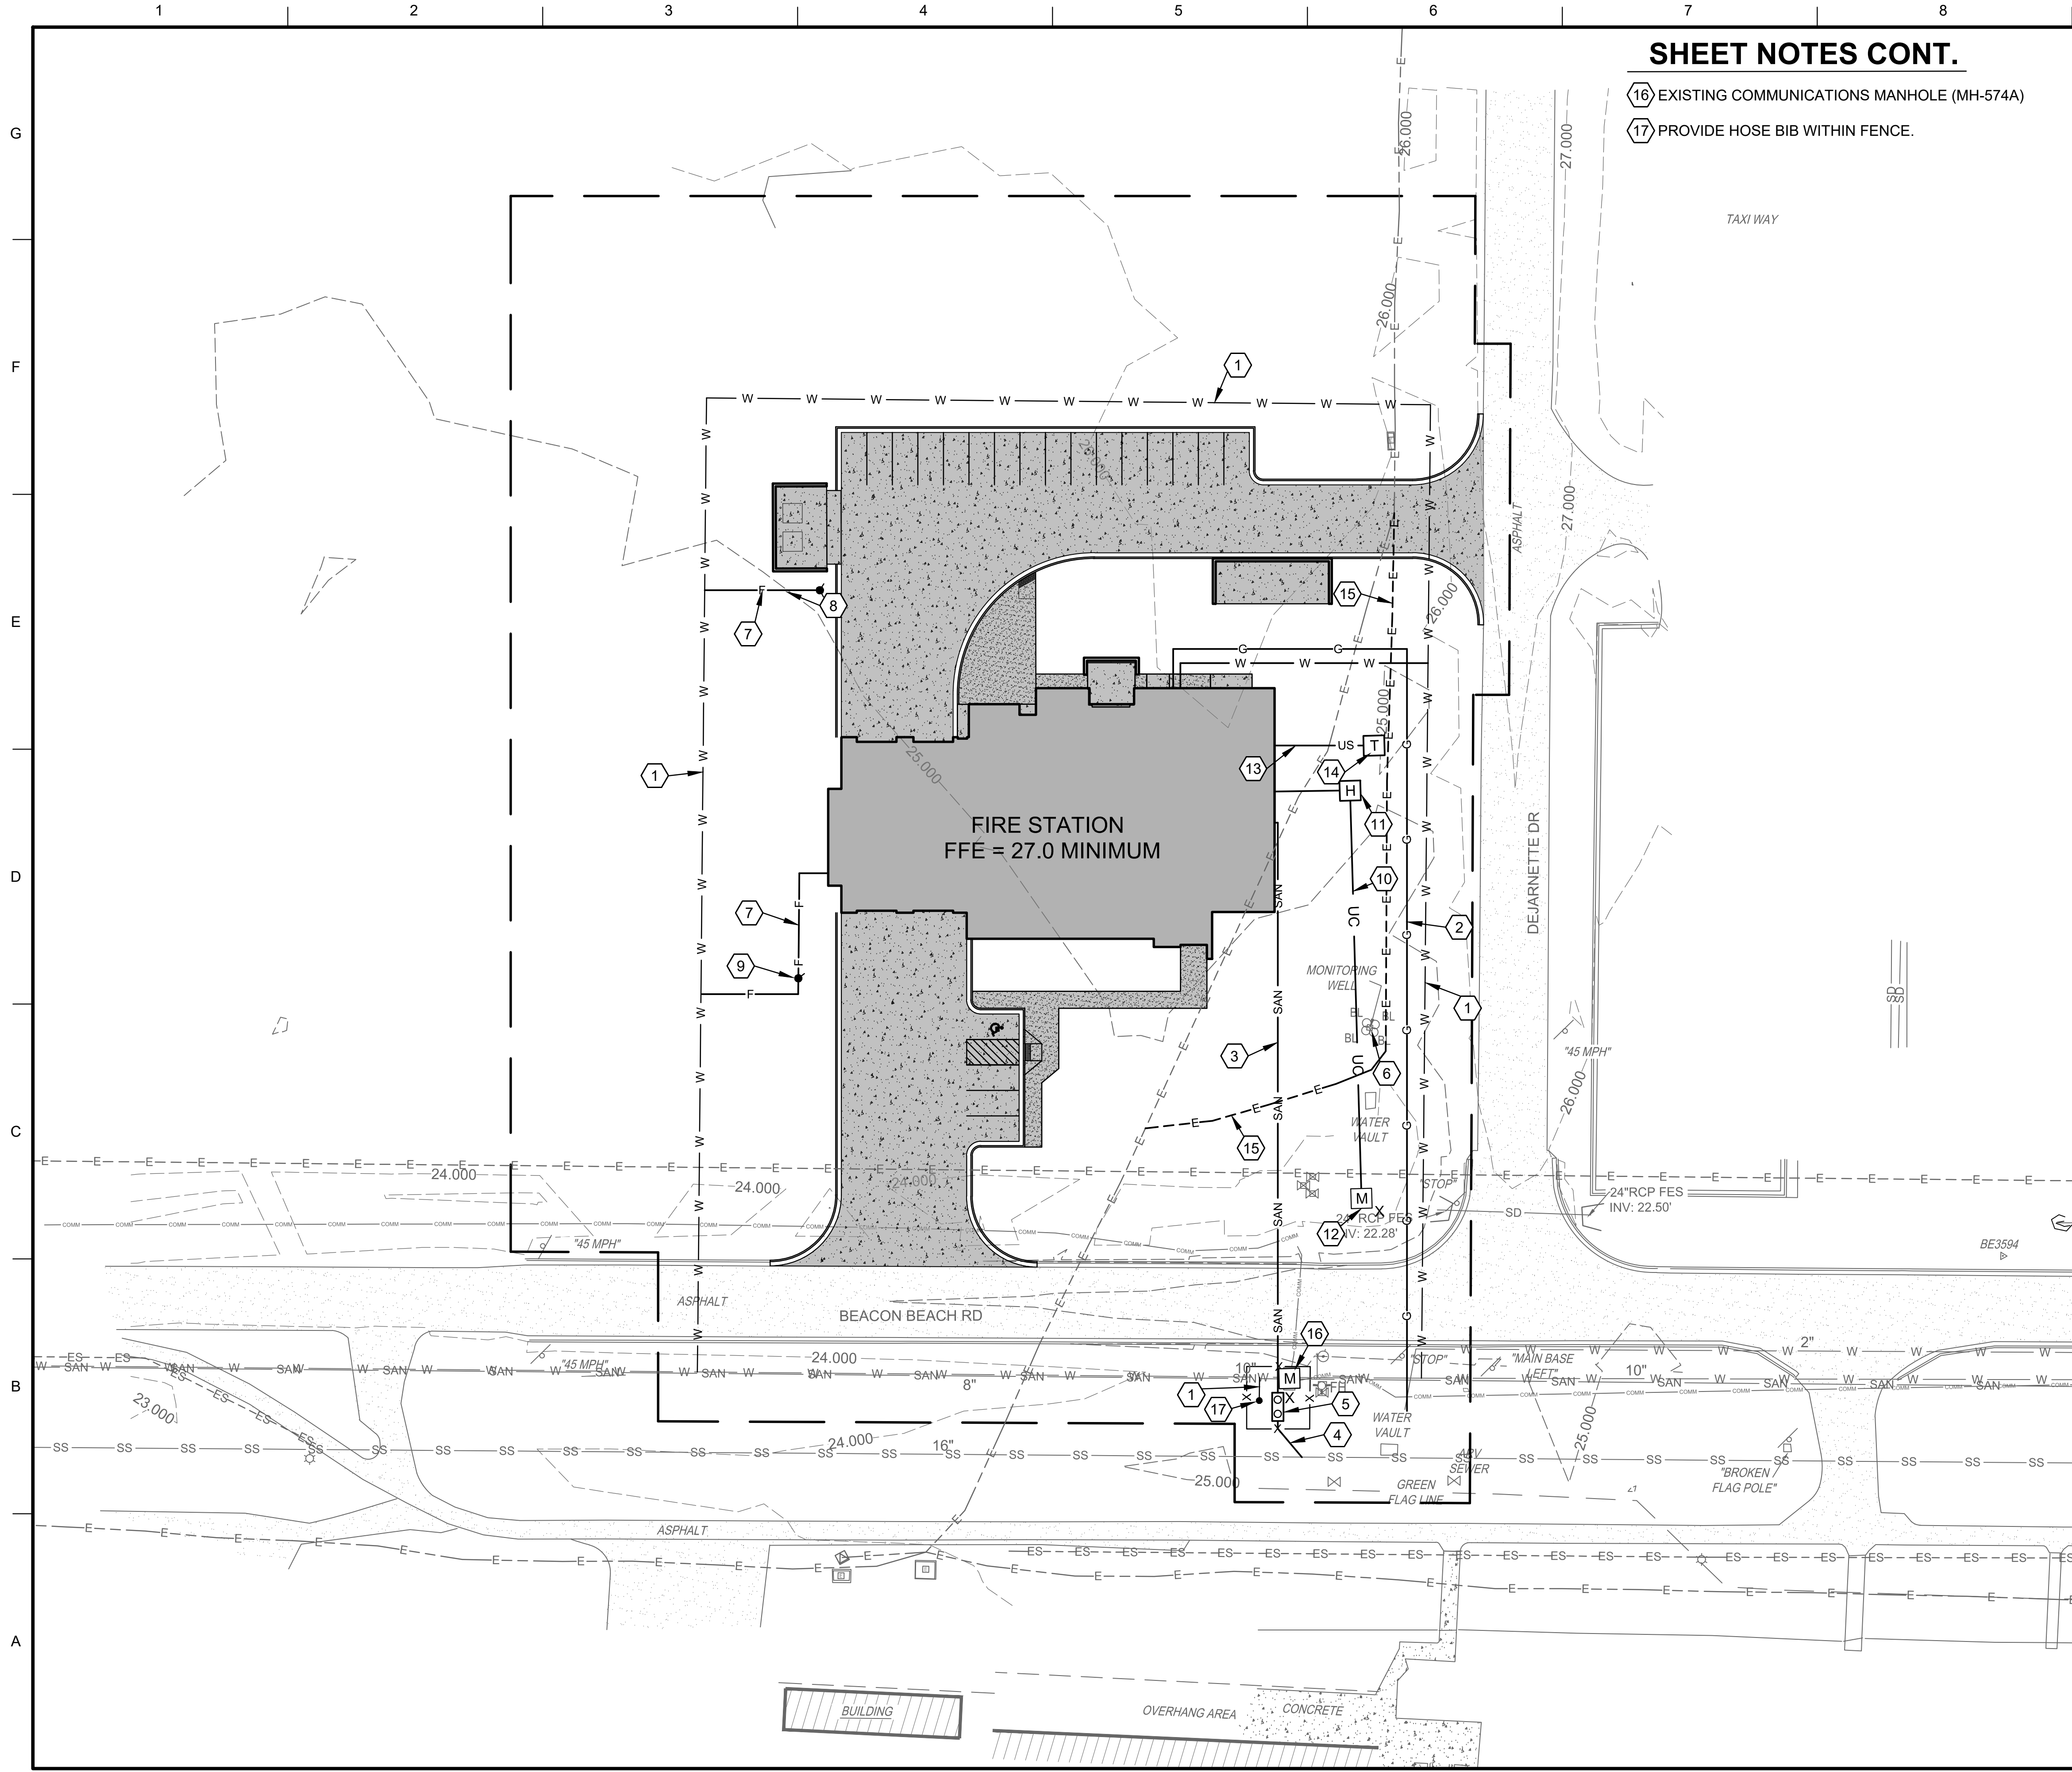- 16 EXISTING COMMUNICATIONS MANHOLE (MH-574A)
- 17 PROVIDE HOSE BIB WITHIN FENCE.

GENERAL NOTES


- IF UXO IS ENCOUNTERED, THE CONTRACTOR SHALL EVACUATE PERSONNEL IN THE SURROUNDING AREA AND DIAL 911. UXO RISK LEVEL IS LOW.
- COORDINATE SITE ELECTRICAL AND PARKING LOT LIGHTING WORK WITH GULF COAST ELECTRICAL COOPERATIVE (GCEC). REFER TO APPENDIX H FOR GCEC PROVIDED PARKING LOT LIGHTING LAYOUT.
- REFER TO SHEET CU102 FOR FURTHER INFORMATION ON SITE COMMUNICATIONS.

SHEET NOTES

- 1 PROVIDE WATER LINE.
- 2 PROVIDE NATURAL GAS LINE.
- 3 PROVIDE SANITARY SEWER GRAVITY LINE.
- 4 PROVIDE SANITARY SEWER FORCE MAIN.
- 5 PROVIDE SANITARY SEWER PUMP STATION.
- 6 DO NOT DISTURB EXISTING GROUND WATER MONITORING WELL.
- 7 PROVIDE FIRE LINE.
- 8 PROVIDE FIRE HYDRANT.
- 9 PROVIDE POST INDICATOR VALVE.
- 10 PROVIDE UNDERGROUND COMMUNICATIONS DUCT BANK.
- 11 PROVIDE COMMUNICATIONS HANDHOLE.
- 12 EXISTING COMMUNICATIONS MANHOLE (MH-574B)
- 13 PROVIDE UNDERGROUND SECONDARY ELECTRICAL LINE.
- 14 PROVIDE PAD MOUNTED TRANSFORMER.
- 15 EXISTING UNDERGROUND ELECTRIC LINE TO BE RELOCATED BY GCEC.

LEGEND

- CONSTRUCTION LIMITS
- W EXISTING WATER MAIN
- SAN EXISTING SANITARY SEWER GRAVITY LINE
- SS EXISTING SANITARY SEWER FORCE MAIN
- E EXISTING ELECTRIC PRIMARY LINE
- ES EXISTING ELECTRIC SECONDARY LINE
- W PROPOSED WATER LINE
- SAN PROPOSED SANITARY SEWER GRAVITY LINE
- SS PROPOSED SANITARY SEWER FORCE MAIN
- G PROPOSED NATURAL GAS LINE
- F PROPOSED FIRE WATER LINE
- PROPOSED SANITARY SEWER PUMP STATION
- PROPOSED POST INDICATOR VALVE
- PROPOSED FIRE HYDRANT
- US PROPOSED UNDERGROUND SECONDARY ELECTRICAL
- T PROPOSED PAD MOUNT TRANSFORMER LOCATION
- H PROPOSED COMMUNICATION HANDHOLE
- M EXISTING COMMUNICATION MANHOLE
- UC PROPOSED UNDERGROUND COMMUNICATIONS DUCT BANK

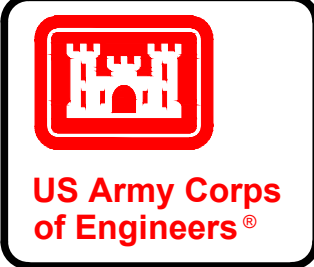

MARK	DESCRIPTION	DATE

DESIGNED BY: G. LYNN	ISSUE DATE: AUGUST 2019
DRAWN BY: J. B. HENDERSON	SOLICITATION NO.: W81ZB5372005
CHECKED BY: M. MAYER	CONTRACT NO.:
SUBMITTED BY: MASON & HANGER	PROJECT NUMBER: MEF19013
SIZE: ANSI D	FILENAME: TYNFS_Site.dwg

U.S. ARMY CORPS OF ENGINEERS
MOBILE DISTRICT
108 SAINT JOSEPH STREET
MOBILE, ALABAMA

Mason & Hanger
A Division of

TYNDALL AFB, FL CONSTRUCT FIRE STATION 2	UTILITY PLAN
FY 2019, PN XLWU193005	

SHEET ID
CU101

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Jul 17, 2019
11:03am



GENERAL NOTES


1. IF UXO IS ENCOUNTERED, THE CONTRACTOR SHALL EVACUATE PERSONNEL IN THE SURROUNDING AREA AND DIAL 911. UXO RISK LEVEL IS LOW.

SHEET NOTES

- 1 EXISTING COMMUNICATIONS MANHOLE MH-574B
- 2 EXISTING COMMUNICATIONS MANHOLE MH-574A
- 3 BUILDING 1210

LEGEND

- CONSTRUCTION LIMITS
- EXISTING COMMUNICATION MANHOLE

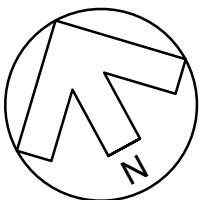

US Army Corps
of Engineers®

MARK	DESCRIPTION	DATE

DESIGNED BY: R. MAYS	ISSUE DATE: AUGUST 2019
DRAWN BY: M. MAYER	SOLICITATION NO.: W9125J212005
CHECKED BY: M. MAYER	CONTRACT NO.:
SUBMITTED BY: MASON & HANGER	PROJECT NUMBER: MEF19013
SIZE: ANSI D	FILENAME: TYNFS_Site.dwg

U.S. ARMY CORPS OF ENGINEERS
MOBILE DISTRICT
105 SAINT JOSEPH STREET
MOBILE, ALABAMA









TYNDALL AFB, FL
CONSTRUCT FIRE STATION 2
FY 2019, PN XLWU193005

OVERALL COMMUNICATION
CONNECTION POINTS


SHEET ID

CU102

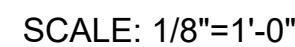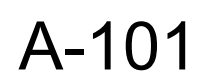

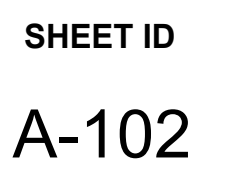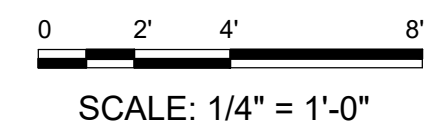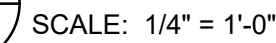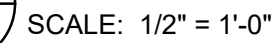

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US ARMY CORPS OF ENGINEERS MOBILE DISTRICT 108 SAINT JOSEPH STREET MOBILE, ALABAMA	 Mason & Hanger <i>A Drexel Zimmermann Company</i>	DESIGN BY: J. HUNSBUCKER DRAWN BY: J. HUNSBUCKER CHECKED BY: Q. BAGG SUBMITTED BY: MASON & HANGER SIZE: ANSI/D	ISSUE DATE: AUG 2019 SOLICITATION NO.: W91278-19SF-F2C005 CONTRACT NO.: PROJECT NUMBER: MEF19013 CAD CODE:
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TYNDALL AFB, FL
CONSTRUCT FIRE STATION # 2
DESIGN-BUILD RFP
FY 2019, PNXLWU193005

SHEET ID

A-103

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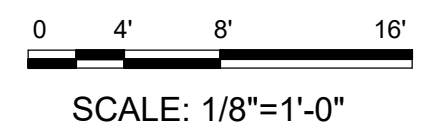
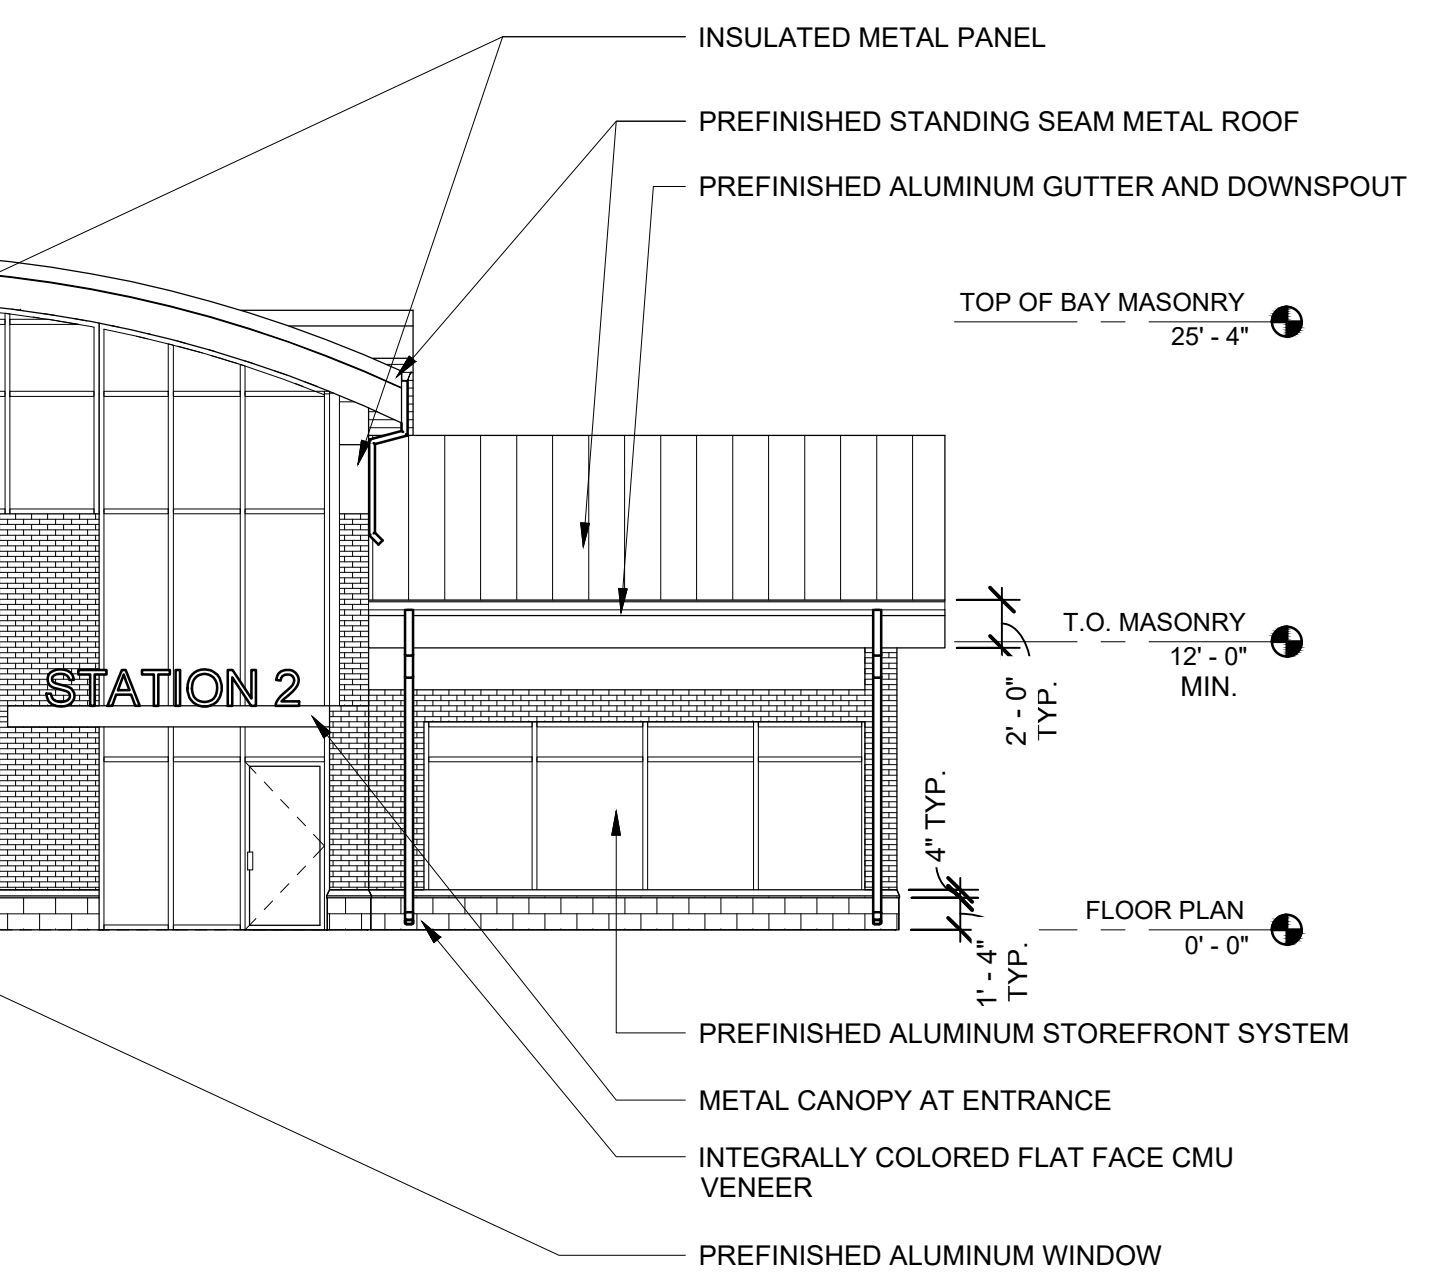
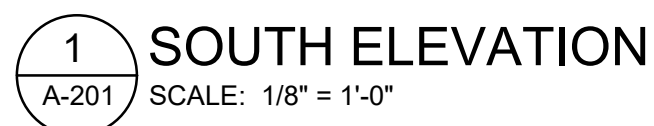
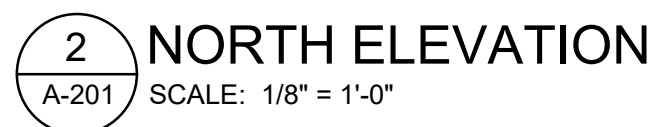
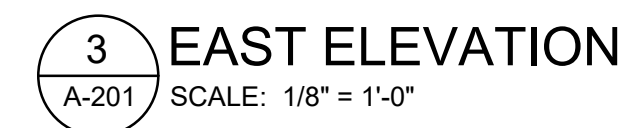
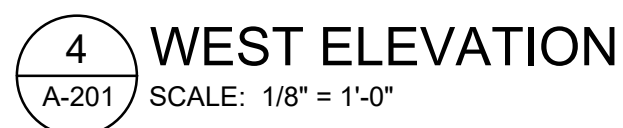
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J. HUNSUCKER	AUG 2019
DRAWN BY:	SOLICITATION NO.:
T. HOURIGAN	W9127819SFHZ0005
CHECKED BY:	CONTRACT NO.:
Q. BIAGI	
SUBMITTED BY:	PROJECT NUMBER:
MASON & HANGAR	MEF19013
SIZE:	CAD CODE:
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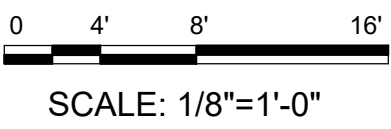
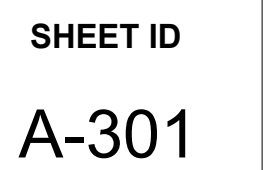
US ARMY CORPS OF ENGINEERS
MOBILE DISTRICT
109 SAINT JOSEPH STREET
MOBILE, ALABAMA

 **Mason & Hanger**
A Day & Zimmermann Company

TYNDALL AFB, FL
CONSTRUCT FIRE STATION # 2
DESIGN-BUILD REP
FY 2019, PNXLWU193005

SHEET ID
A-201








SCALE: 1/2" = 1'-0"

1. FURNITURE PLANS ARE FOR REFERENCE ONLY
2. IF BID OPTION NO. 1 IS ACCEPTED - ALL FF&E TO BE CONTRACTOR FURNISHED AND CONTRACTOR INSTALLED; IF BID OPTION NO. 1 IS NOT ACCEPTED - ALL FF&E TO BE GOVERNMENT FURNISHED AND CONTRACTOR INSTALLED
3. CONTRACTOR IS RESPONSIBLE FOR MAINTAINING ACCEPTABLE CLEARANCES BETWEEN FURNITURE AND WALLS TO ALLOW FOR POWER TO BE SUPPLIED TO FURNITURE
4. FURNITURE SPECIFIED IS A BASIS OF DESIGN ONLY; FURNITURE BEING BID SHOULD REFERENCE SALIENT FEATURES THROUGHOUT CID PACKAGE TO BASE FURNITURE SELECTIONS PER MANUFACTURER

[illegible]



Mason & Hanger

A Dayco Zimmerman Company

108 SAINT JOSEPH STREET
MOBILE, ALABAMA

DRAWN BY: M.ARMISTEAD
CHECKED BY:
B.NIEPORT

SOLICITATION NO.: V91278195F-HZ0005
CONTRACT NO.:
PROJECT NUMBER: MEF-19013

SUBMITTED BY: MASON & HANGER



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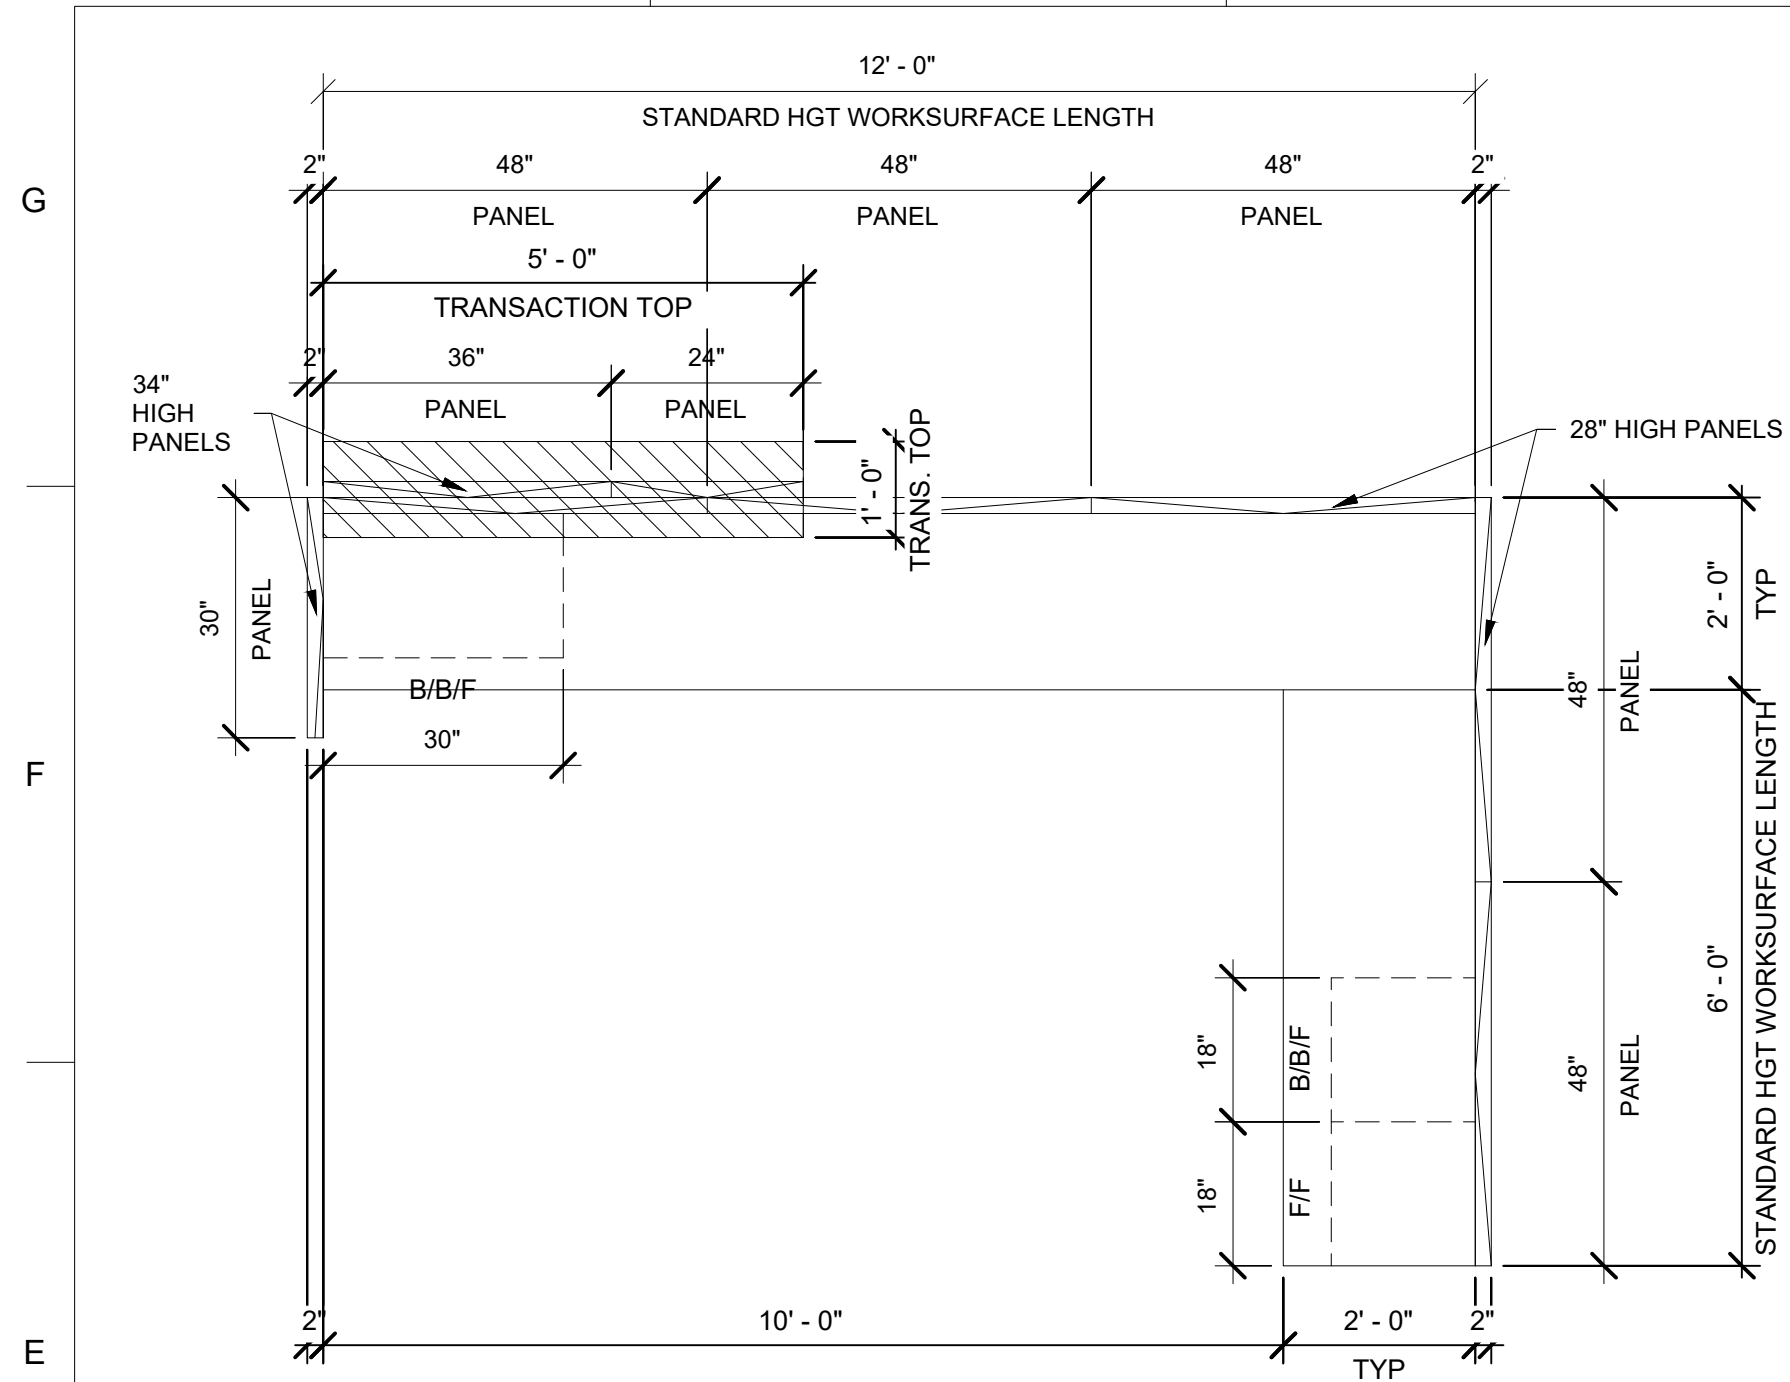
CAD CODE:

FY 2019, PNXLWU193005

SHEET ID

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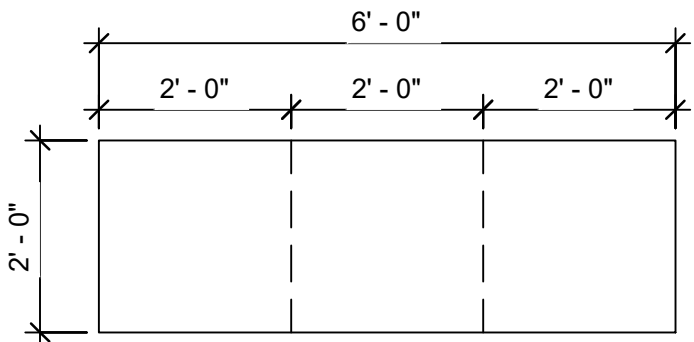


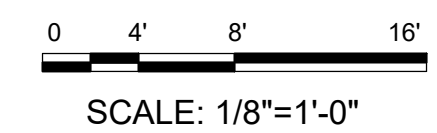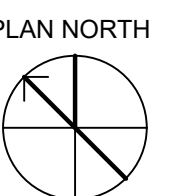

STANDARD COMPONENTS PER CUBICLE:

- L-SHAPED WORKSURFACE
- POWERED PANELS AS SHOWN
 - (2) DUPLEX RECEPTACLES (6 plug in points)
 - (1) VOICE & DAA QUAD PORT PER CUBICLE
- ALL TFL LAMINATE SURFACES, METAL CONNECTORS
- WORKSURFACES AS SHOWN - TFL LAMINATE WITH MATCHING EDGE
- PVC WIRE MANAGEMENT SYSTEM AT WALL SIDE
- (ALLOWS WIRE TO PASS STRAIGHT DOWN AND RUN IN A CHANNEL IF NECESSARY)
- PANEL TILES - TFL LAMINATE FINISH
- STORAGE:
 - (2) B/B/F (2 SMALL DRAWER + 1 LARGE DRAWER) WITH LOCKS, PENCIL TRAY, AND RAILS
 - (1) F/F (2 Large drawers), WITH LOCKS AND RAILS
- SEATING NOT INCLUDED


11 WS-1 RECEPTION WORKSTATION
1/2" = 1'-0"



DESCRIPTION:

72X24X36 FREESTANDING MEDIA CREDENZA
THREE DRAWERS AND DOORS WITH ADJUSTABLE SHELVING STORAGE
WOOD VENEER OR HIGH PRESSURE LAMINATE WOOD GRAIN FINISH
SOLID WOOD DRAWERS, DOOR, AND SIDE PANELS


12 CR-1 CREDENZA
1/2" = 1'-0"

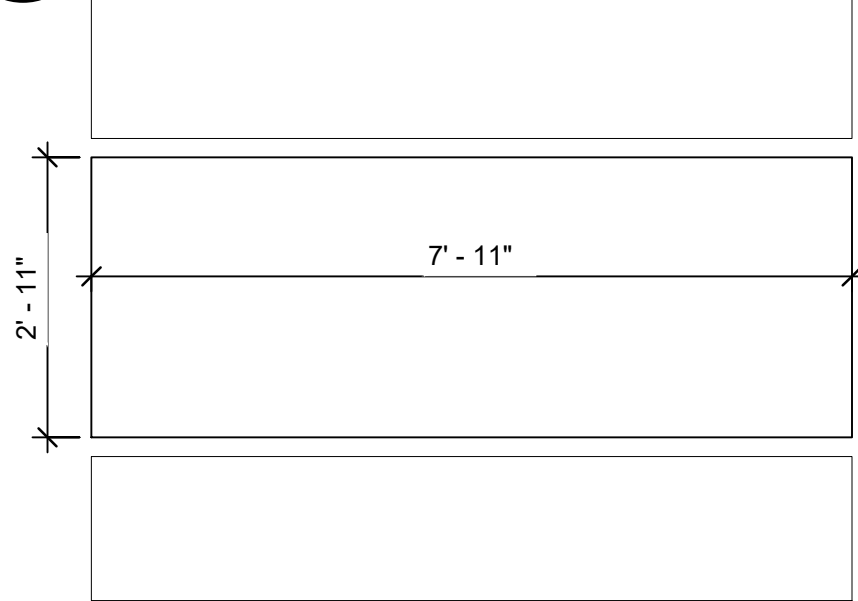

DESCRIPTION:

35X95X29 OUTDOOR PICNIC TABLE
ANODIZED ALUMINUM FRAMING
WOOD SLATE TABLE AND SEAT SURFACE


10 B-1 OUTDOOR TABLE
1/2" = 1'-0"

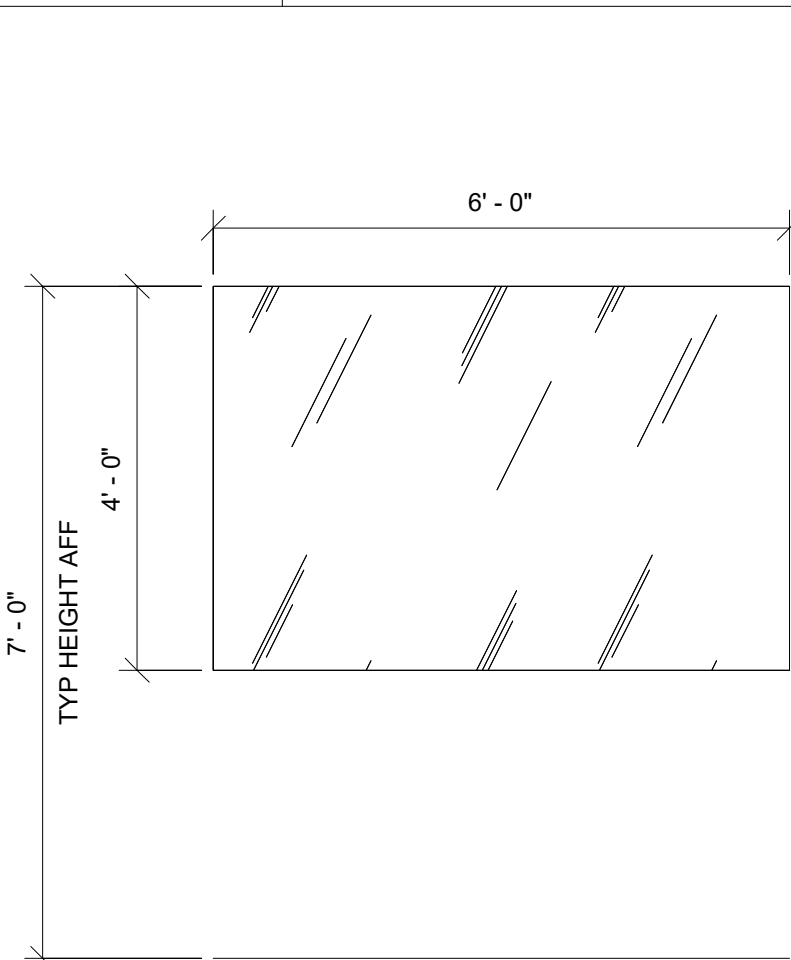

DESCRIPTION:

48"x72" CLARUS FLOAT MAGNETIC GLASS BOARD
COLOR: C100 PURE WHITE


9 MB-1 GLASS BOARD
1/2" = 1'-0"

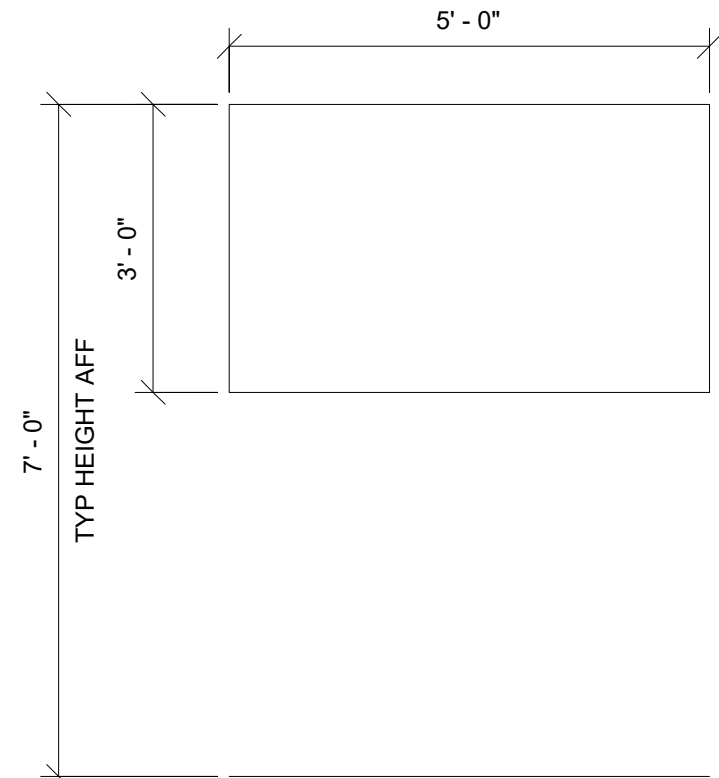

DESCRIPTION:

36"x60" ALUMINUM FRAMED CORK MATERIAL
TACK BOARD

8 TB-1 TACK BOARD
1/2" = 1'-0"

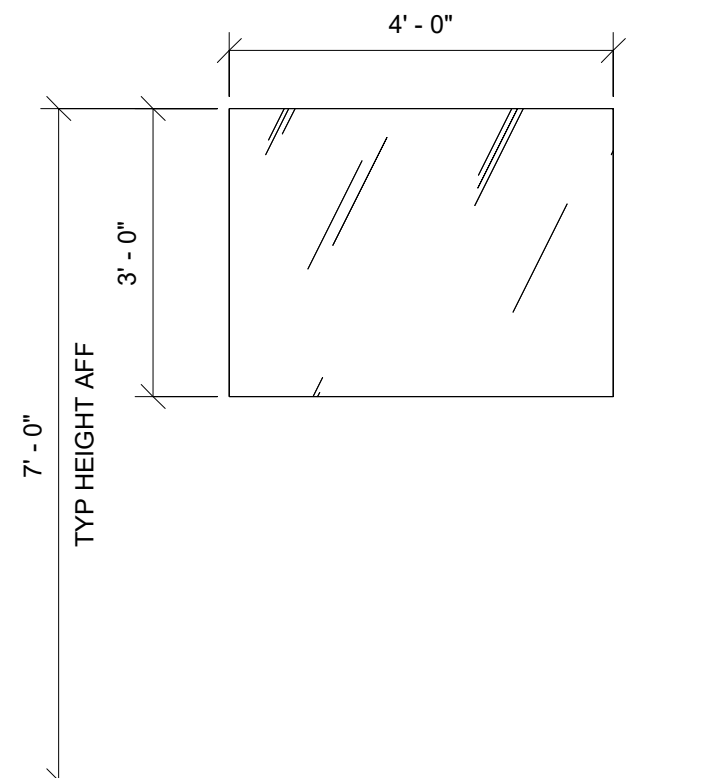


DESCRIPTION:

36"x48" CLARUS FLOAT MAGNETIC GLASS BOARD
COLOR: C100 PURE WHITE

7 MB-2 GLASS BOARD
1/2" = 1'-0"

PLAN SYMBOL							
ITEM CODE	SWD-1	RF-1	R-1	DW-1	MW-1	IM-1	GD-1
ITEM NAME	STACKABLE WASHER/DRYER UNIT	FULL REFRIGERATOR	GAS RANGE	BUILT IN DISHWASHER	MICROWAVE HOOD	ICE MAKER	FOOD WASTER DISPOSER
DESCRIPTION	VENTED, ELECTRICAL TOP LOAD WASHER AND DRYER; 3.9 CU.FT. WASHER, 5.5 CU.FT. DRYER	10 CU.FT. APARTMENT SIZE REFRIGERATOR; (2) CRISPER DRAWERS, ADJUSTABLE SHELVES, FULL WIDTH FREEZER	5 CU.FT. FREESTANDING GAS RANGE, 4 COIL BURNERS, SELF CLEAN ACTION, STORE MORE STORAGE DRAWER	60dB, 4 CYCLE BUILT IN DISHWASHER; STANDARD PVC RACK SYSTEM	1.5 CU.FT. OVER THE RANGE MICROWAVE; 14" DIA. TURNABLE, (4) AUTO COOK SETTINGS, (1) INTERIOR LIGHT AND (1) EXHAUST FAN SETTINGS	50 LB STORAGE CAPACITY, UNDERCOUNTER ICE MACHINE; FLIP UP DOOR, ICE SCOOP INCLUDED	1/2 HP LIGHT CAPACITY FOOD DISPOSER; FITS 3-4" SINK HOLES, STAINLESS STEEL CONSTRUCTION, WALL SWITCH OPERATED; MOUNTING HARDWARE INCLUDED


KITCHEN EQUIPMENT LEGEND
SCALE: 1/2" = 1'-0"

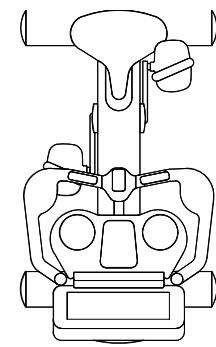

DESCRIPTION:

43.5"L X 21"W X 59.5"H UPRIGHT BICYCLE
ERGONOMIC DESIGN RACING HANDLEBARS
SELF LEVELING, NON-SLIP PEDALS
BLUETOOTH AND WIRELESS CAPABILITIES
21 WORKOUT OPTIONS; CONFORT CURVE SADDLE SEAT
EASILY MOVEABLE
X CONSOLE
NAVIGATION CAPABILITIES

6 WOE-9 WORKOUT EQUIPMENT
1/2" = 1'-0"

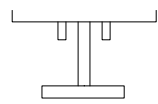


DESCRIPTION:

MEDICINE BALL RACK
STATIONARY 11-GUAGE STEEL FRAME
BENCH ON RUBBER FEET
POWDER COATED FINISH
SPACE EFFICIENT FOR UNRESTRICTED MOVEMENTS
DESIGN INCLUDES: STORAGE CAPACITY FOR (5) BALLS

**SEE ORDER DATA SHEETS FOR PLATE WEIGHT SPECIFICATIONS*

5 WOE-8 WORKOUT EQUIPMENT
1/2" = 1'-0"

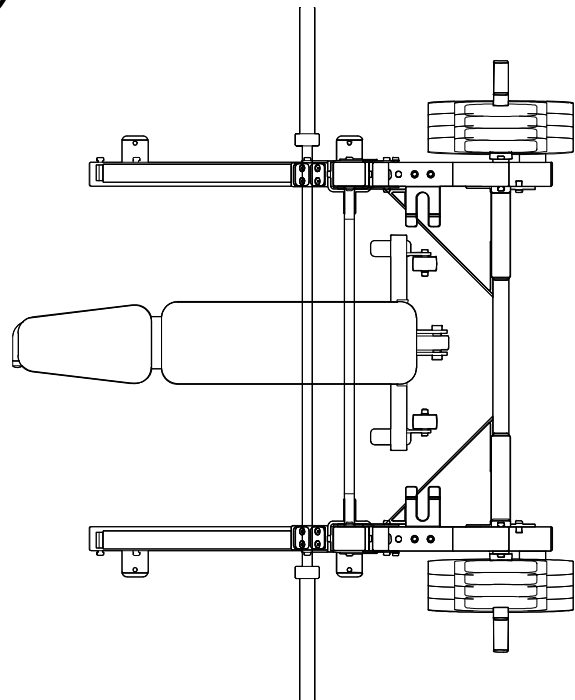


DESCRIPTION:

57"L X 67"W X 96"H HALF RACK
STATIONARY 11-GUAGE STEEL FRAME BENCH ON RUBBER FEET
POWDER COATED FINISH
SPACE EFFICIENT FOR UNRESTRICTED MOVEMENTS
DESIGN INCLUDES: ANVIL BRACING, SPIDER GUSSET, AND HAMMERLOCKS

53"L X 32"W X 18"H ADJUSTABLE BENCH
STATIONARY 11-GA STEEL FRAME
FULLY ADJUSTABLE ON RUBBER FEET
POWDER COATED FINISH

4 WOE-6 & WOE-7 WORKOUT EQUIPMENT
1/2" = 1'-0"

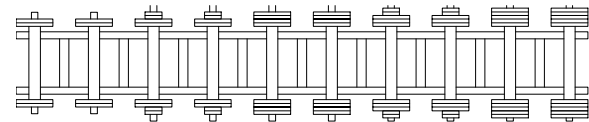


DESCRIPTION:

90"L X 25"W X 33"H THREE TIER DUMBBELL RACK
STATIONARY 11-GA. STEEL FRAME
HOLDS (1) FULL SET OF 5-50 LBS WEIGHTS

**SEE ORDER DATA SHEETS FOR DUMBBELL WEIGHT SPECIFICATIONS*


3 WOE-4 WORKOUT EQUIPMENT
1/2" = 1'-0"

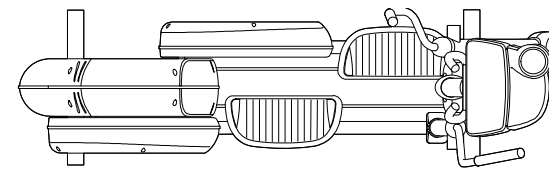

DESCRIPTION:

88"L X 31"W X 65"H ELLIPTICAL
ERGONOMIC DESIGN RACING HANDLEBARS
SELF LEVELING, NON-SLIP PEDALS
BLUETOOTH AND WIRELESS CAPABILITIES
21 WORKOUT OPTIONS
CONFORT CURVE SADDLE SEAT
EASILY MOVEABLE
X CONSOLE
NAVIGATION CAPABILITIES


2 WOE-2 WORKOUT EQUIPMENT
1/2" = 1'-0"

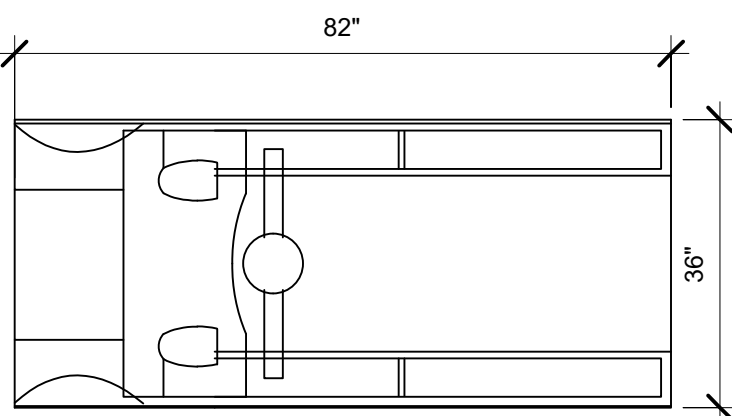


DESCRIPTION:

80"L X 37"W X 62.25"H TREADMILL
24" HANDRAILS
CAST ALUMINUM SIDE RAILS AND END CAPS
STAINLESS STEEL VENT DETAIL
BLUETOOTH AND WIRELESS CAPABILITIES
21 WORKOUT OPTIONS; EASILY MOVEABLE
X CONSOLE
NAVIGATION CAPABILITIES

1 WOE-1 WORKOUT EQUIPMENT
1/2" = 1'-0"

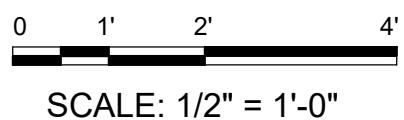

SCALE: 1/2" = 1'-0"

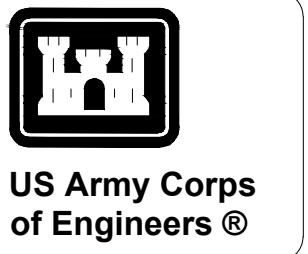

DATE	
DESCRIPTION	
MARK	

ISSUE DATE:	AUG 2019
SOLUTION NO.:	100
CONTRACT NO.:	MEF19013
PROJECT NUMBER:	MEF19013
CAD CODE:	ANSI D

US ARMY CORPS OF ENGINEERS MOBILE DISTRICT 108 SAINT JOSEPH STREET MOBILE, ALABAMA	Mason & Hanger <i>A Design & Construction Company</i>
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TYNDALL AFB, FLORIDA CONSTRUCT FIRE STATION #2 FY 2019, PNXLWU193005	FURNITURE TYPICALS
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SHEET ID	I-103
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1		2		3		4		5		6	
INTERIOR FINISH LEGEND											
MATERIAL	CODE	MANUFACTURER	SPECIFICATIONS				NOTES				
ACOUSTICAL CEILING	ACT-1	ARMSTRONG	STYLE: "DUNE" ITEM#1774, 2'X2' X 5/8" THICK, ANGLED REGULAR, 15/16" GRID				TYP. ACT				
CORNER GUARDS	CG	ACROVYN	2" WIDE CORNER GUARDS, COLOR: W262 DRIFTWOOD				ALL OUTSIDE CORNERS				
CARPET TILE	CPT-1	MOHAWK GROUP	SHIRT II GT 173: 695 SHARKSKIN				TRAINING AREAS; BRICK ASHLAR INSTALLATION METHOD				
CARPET TILE	CPT-2	MOHAWK GROUP	DENIM HEM GT 178: 937 HIPSTER				DORM ROOMS & OFFICE AREAS; MONOLITHIC INSTALLATION METHOD				
EPOXY FLOORING	EPX-1	DUR-A-FLEX	DUR-A-CHIP 5 COAT SYSTEM WITH MACRO CHIPS, COLOR: COBALT; ARMOR TOP COAT WITH GRIT				APPARATUS BAY FLOORING				
TILE GROUT	G-1	CUSTOM BUILDING PRODUCTS	#19 PEWTER				ALL TILE IN ALL AREAS				
INTERLOCKING MAT FLOORING	MAT-1	AMERICAN FLOOR MATS	INTERLOCKING MEGA LOCK RUBBER GYM TILES: BLACK, 1/2" THICK				FITNESS AREA				
PLASTIC LAMINATE	PL-1	WILSONART	7947K-18 ASAIN NIGHT				RESTROOM VANITY SKIRT				
PLASTIC LAMINATE	PL-2	WILSONART	7957K-78 ZANZIBAR				KITCHEN/LAUNDRY/ TRAINING CASEWORK AND WATCH DESK COUNTERTOP				
PAINT	PNT-1	SHERWIN WILLIAMS	SW 7016 MINDFUL GRAY				FIELD PAINT				
PAINT	PNT-2	SHERWIN WILLIAMS	SW 6524 COMMADORE				ACCENT PAINT				
PAINT	PNT-3	SHERWIN WILLIAMS	SW 7018 DOVETAIL				ACCENT PAINT				
PAINT	PNT-4	SHERWIN WILLIAMS	SAFETY YELLOW				BOLLARDS & SAFETY STRIPPING IN APPARATUS BAY				
PAINT	PNT-5	SHERWIN WILLIAMS	HIGH REFLECTIVE WHITE				CEILINGS AND SOFFITS				
PAINT	PNT-6	SHERWIN WILLIAMS	SW 7016 MINDFUL GRAY				EPOXY PAINT				
PAINT	PNT-7	SHERWIN WILLIAMS	SW 7019 GAUNTLET GRAY				ALL STEEL DOOR FRAMES				
QUARTZ	QZ-1	CAMBRIA	COLOR: DARON; DOUBLE TREELINE EDGE, 2CM THICK				RECEPTION DESK TRANSACTION TOP				
RUBBER BASE	RB-1	ARMSTRONG	71 MID GRAY				WALL BASE ALL AREAS				
SIGNAGE	S-1	APPENX	(SG) SLATE GREY; XSITE CURVED SUFACE SIGN STYLE, FUTURA BOOK TEXT STYLE				SIGN MESSAGE COLOR; ALL SIGNS THROUGHOUT				
SEALED CONCRETE	SC-1						CONCRETE TO BE FINISHED WITH CLEAR EPOXY COATING				
SOLID SURFACE	SS-1	LIVINGSTONE	L715 ECLIPSE				KITCHEN COUNTERTOP				
SOLID SURFACE	SS-2	CORIAN	DEEP CLOUD				WINDOW SILLS				
SOLID SURFACE	SS-3	LIVINGSTONE	L712 THUNDERCLOUD				DORM RESTROOM COUNTERTOP				
SOLID SURFACE	SS-4	LIVINGSTONE	SOFT WHITE				INTEGRAL SINK COLOR FOR KITCHEN AND RESTROOMS; KITCHEN - DOUBLE BOWL SINK, RESTROOM - OVAL SINK				
DOOR STAIN	ST-1	ARCHITECTURAL MASONITE	WHITE MAPLE; ESPRESSO 42-95				ALL INTERIOR DOORS THROUGHOUT				
STAINED CONCRETE	STC-1	PROSOCO	CONSOLIDECK GEMTONE STAIN, COLOR: WELSH SLATE; FINISHED WITH PROSOCO DURASHEEN PROTECTIVE COAT				HIGH TRAFFIC AREAS				
PORCELAIN TILE	T-1	DALTILE	AMBASSADOR AM34 JET SETTER DUSK; 12X48 TILE				RESTROOM FLOOR TILE				
PORCELAIN TILE	T-2	DALTILE	AMBASSADOR AM34 JET SETTER DUSK; 3X6 TILE				RESTROOM WALL TILE				
MOSAIC TILE	T-3	DALTILE	COASTAL KEYSTONES TROPICAL THUNDER CK88; 2X1 BRICK JOINT MOSAIC				KITCHEN BACKSPLASH				
PORCELAIN TILE BASE	TB-1	DALTILE	AMBASSADOR AM34 JET SETTER DUSK S-43F9; 3X24 BULLNOSE				RESTROOM FLOOR TILE BASE				
TOILET PARTITIONS	TP-1	BRADLEY CORP	2125 DOVE GRAY								
WALK OFF CARPET TILE	WC-1	MOHAWK GROUP	FIRST STEP II GT315; 955 COBALT				VESTIBULE WALKOFFCARPET; MONOLITHIC INSTALLATION METHOD				
WALL COVERING	WC-1	MDC STUDIO	FLEXIBLE SUBSTRATES SMOOTH FINISH; COMMERCIAL GRADE TYPE II FABRIC BACKED WALLCOVERING				CUSTOM IMAGE GRAPHIC				
WALL COVERING	WC-2	MDC STUDIO	FLEXIBLE SUBSTRATES SMOOTH FINISH; COMMERCIAL GRADE TYPE II FABRIC BACKED WALLCOVERING				CUSTOM IMAGE GRAPHIC				
WALL COVERING	WC-3	MDC STUDIO	FLEXIBLE SUBSTRATES SMOOTH FINISH; COMMERCIAL GRADE TYPE II FABRIC BACKED WALLCOVERING				CUSTOM IMAGE GRAPHIC				

ROOM FINISH SCHEDULE									
ROOM NO.	ROOM NAME	FLOOR FINISH		WALL FINISH				CEILING	NOTES
		FLOORING	BASE	NORTH	EAST	SOUTH	WEST		
100	DORM	CPT-2	RB-1	PNT-1	PNT-1	PNT-1	PNT-1	GYP/PNT-5	SEE TYPICAL RESTROOM WALL ELEVATION; SHEET I-603
101	RESTROOM	STC-1	TB-1	PNT-6/T-1	PNT-6/T-1	PNT-6/T-1	PNT-6/T-1	GYP/PNT-5	
102	DORM	CPT-2	RB-1	PNT-1	PNT-1	PNT-1	PNT-1	GYP/PNT-5	
103	DORM	CPT-2	RB-1	PNT-1	PNT-1	PNT-1	PNT-1	GYP/PNT-5	SEE TYPICAL RESTROOM WALL ELEVATION; SHEET I-603
104	RESTROOM	STC-1	TB-1	PNT-6/T-1	PNT-6/T-1	PNT-6/T-1	PNT-6/T-1	GYP/PNT-5	
105	DORM	CPT-2	RB-1	PNT-1	PNT-1	PNT-1	PNT-1	GYP/PNT-5	
106	DORM	CPT-2	RB-1	PNT-1	PNT-1	PNT-1	PNT-1	GYP/PNT-5	SEE TYPICAL RESTROOM WALL ELEVATION; SHEET I-603
107	RESTROOM	STC-1	TB-1	PNT-6/T-1	PNT-6/T-1	PNT-6/T-1	PNT-6/T-1	GYP/PNT-5	
108	DORM	CPT-2	RB-1	PNT-3	PNT-1	PNT-1	PNT-1	GYP/PNT-5	
109	DORM	CPT-2	RB-1	PNT-3	PNT-1	PNT-1	PNT-1	GYP/PNT-5	SEE TYPICAL RESTROOM WALL ELEVATION; SHEET I-603
110	RESTROOM	STC-1	TB-1	PNT-6/T-1	PNT-6/T-1	PNT-6/T-1	PNT-6/T-1	GYP/PNT-5	
111	DORM	CPT-2	RB-1	PNT-3	PNT-1	PNT-1	PNT-1	GYP/PNT-5	
112	CORRIDOR	CPT-2	RB-1	PNT-1	PNT-1	PNT-1	PNT-1	ACT-1	SEE INTERIOR ELEVATIONS FOR WALL GRAPHIC IMAGE AND SIZE; SHEET I-603 T-3 BACKSPLASH TILE AT ISLAND BEHIND KITCHEN; PNT-2 APPLIED TO BAR WALL ON SEAT SIDE
113	DAYROOM	STC-1	RB-1	PNT-1	PNT-1	PNT-1	WC-2/PNT-3	ACT-1	
114	KITCHEN	STC-1	RB-1	PNT-1	PNT-1	PNT-3/T-3	PNT-1	ACT-1	
115	PANTRY	STC-1	RB-1	PNT-1	PNT-1	PNT-1	PNT-1	ACT-1	
116	PATIO	SC-1						NONE	
117	CORRIDOR	STC-1	RB-1	PNT-3/WC-3	PNT-1	PNT-1	PNT-2	NONE	EXPOSED STRUCTURE; PAINT PNT-6
118	APPARATUS BAY	EPX-1	RB-1	PNT-6	PNT-6	PNT-6	PNT-6	NONE	EXPOSED STRUCTURE; PAINT PNT-6
119	HOSE RACK	EPX-1	RB-1	PNT-6	PNT-6	PNT-6	PNT-6	NONE	EXPOSED STRUCTURE; PAINT PNT-6
120	AGENT STORAGE	EPX-1	RB-1	PNT-6	PNT-6	PNT-6	PNT-6	NONE	EXPOSED STRUCTURE; PAINT PNT-6
121	FIRE RISER	EPX-1	RB-1	PNT-6	PNT-6	PNT-6	PNT-6	NONE	EXPOSED STRUCTURE; PAINT PNT-6
122	EQUIP WASH	EPX-1	RB-1	PNT-6	PNT-6	PNT-6	PNT-6	NONE	EXPOSED STRUCTURE; PAINT PNT-6
123	INFECTIOUS CONTROL	EPX-1	RB-1	PNT-6	PNT-6	PNT-6	PNT-6	NONE	EXPOSED STRUCTURE; PAINT PNT-6

EXTERIOR MATERIAL LEGEND		
MATERIAL	MANUFACTURER	SPECIFICATIONS
ALUMINUM COPING	CENTRIA	SLATE GRAY #181
ALUMINUM GUTTERS & DOWNSPOUTS	KAWNEER COMPANY	DARK BRONZE
ALUMINUM WINDOW FRAME	KAWNEER COMPANY	CLEAR ANODIZED ALUMINUM
BRICK VENEER	ACME BRICK	DOVE GRAY
CMU	LEE BUILDING PRODUCTS	H720 DOVER CHOCOLATE DK
EXTERIOR PASSAGE DOOR	SHERWIN WILLIAMS	SW 7019 GAUNTLET GREY
GLAZING	PPG ARCHITECTURAL GLASS	SOLARGRAY
INSULATED OVERHEAD DOOR	THERMACORE DOOR	MODEL 596 - SLATE GRAY
MORTAR	BRIXMENT CO.	C-57 TWILIGHT GRAY
PRE-CAST CONCRETE CAP	BARRASSO & SONS	WAP-1
ROOF SYSTEM	FIRESTONE	DARK BRONZE

GENERAL NOTES - FINISH PLANS

SCALE: 1/2" = 1'-0"

1. REFER TO FINISH SCHEDULE, PLANS, DETAILS, AND SPECIFICATIONS FOR MORE INFORMATION
2. FINISHES SPECIFIED IS A BASIS OF DESIGN ONLY; ALL STRUCTURAL INTERIOR DESIGN FINISHES TO BE SIMILAR OR EQUAL TO FINISH AND MANUFACTURER'S PROVIDED IN FINISH LEGEND; ALL FINISH SELECTIONS TO BE PROVIDED WITH HARD SAMPLES SUBMITTALS SHOWING COLOR AND TEXTURE.
3. CENTER ALL TRANSITION STRIPS UNDER DOOR UNLESS NOTED OTHERWISE
4. TRANSITIONS BETWEEN FLOORING MATERIALS SHALL BE ACCOMPLISHED WITH THE USE OF ALUMINUM SCHLUTER TRANSITION STRIPS; CONTRACTOR IS RESPONSIBLE FOR DETERMINING REDUCER HEIGHT BETWEEN MATERIALS
5. PAINT ALL MISC. ITEMS TO MATCH WALL OR CEILING IN WHICH ITEM OCCURS
6. IN ALL RESTROOMS, WALLS TO BE A MOISTURE RESISTANT GYPSUM WALL BOARD W/ AN PNT-6 FINISH & PORCELAIN TILE WAINSCOT.
7. ALL CORNERS WHERE TILE MEETS TILE SHALL BE A MITERED JOINT
8. AT ALL OUTSIDE EDGES AND CORNERS WHERE TILE STOPS PROVIDE A T-2 BULLNOSE TILE TO PROVIDE A CLEAN STOPPING POINT
9. ALL EXTERIOR WINDOWS TO RECEIVE WHITE HORIZONTAL MINI BLINDS. BASIS OF DESIGN: HUNTER DOUGLAS 1" MODERN PRECIOUS METAL ALUMINUM BLINDS. BLINDS SHOULD NOT BE PLACED ON TRANSLUCENT PANELS
10. ALL CUSTOM WALL GRAPHICS TO BE COMMERCIAL GRADE TYPE II VINYL. FLEXIBLE SUBSTRATES, FINISH: SMOOTH, BASIS OF DESIGN: MDC STUDIO, 20 OZ/LYD. FABRIC BACKED WALLCOVERING, 54" WIDE PRINT WITH MINIMUM 6" IMAGE OVERHANG FOR TRIMMING AND FINISHING. FINAL IMAGE RESOLUTION TO BE 100-200 DPI. HANGING SURFACES TO BE CLEAN, SMOOTH, DRY, UNDAMAGED, FREE OF MOLD, MILDEW, GREASE AND STAINS, AND STRUCTURALLY INTACT, FINISHED TO A MINIMUM LEVEL OF 4 PRIOR TO INSTALLATION. DIGITAL IMAGE FILE AT APPROPRIATE RESOLUTION OF GRAPHIC TO BE PROVIDED TO CONTRACTOR UPON AWARD; REFER TO FINISH PLAN SHEET I-602 FOR LOCATIONS AND SHEET I-603 FOR IMAGE AND SIZES

ROOM FINISH SCHEDULE										
ROOM NO.	ROOM NAME	FLOOR FINISH		WALL FINISH				CEILING	NOTES	
		FLOORING	BASE	NORTH	EAST	SOUTH	WEST			
124	EMS STORAGE	EPX-1	RB-1	PNT-6	PNT-6	PNT-6	PNT-6	NONE	EXPOSED STRUCTURE; PAINT PNT-6	
125	WORK ROOM	EPX-1	RB-1	PNT-6	PNT-6	PNT-6	PNT-6	NONE	EXPOSED STRUCTURE; PAINT PNT-6	
126	PPE STORAGE	EPX-1	RB-1	PNT-6	PNT-6	PNT-6	PNT-6	NONE	EXPOSED STRUCTURE; PAINT PNT-6	
127	LAUNDRY	STC-1	RB-1	PNT-1	PNT-1	PNT-1	PNT-1	GYP/PNT-5	EXPOSED STRUCTURE; PAINT PNT-6	
128	STORAGE	STC-1	RB-1	PNT-1	PNT-1	PNT-1	PNT-1	GYP/PNT-5		
129	FITNESS	MAT-1	RB-1	PNT-3	PNT-1	PNT-1	PNT-1	NONE		
130	CHIEF OFFICE	CPT-2	RB-1	PNT-1	PNT-1	PNT-1	PNT-1	GYP/PNT-5	EXPOSED STRUCTURE; PAINT PNT-6	
130A	CHIEF CLOSET	CPT-2	RB-1	PNT-1	PNT-1	PNT-1	PNT-1	GYP/PNT-5		
131	CHIEF DORM	CPT-2	RB-1	PNT-3	PNT-1	PNT-1	PNT-1	GYP/PNT-5		
132	CHIEF/SUPERVISOR BATH	STC-1	TB-1	PNT-6/T-1	PNT-6/T-1	PNT-6/T-1	PNT-6/T-1	GYP/PNT-5	SEE TYPICAL RESTROOM WALL ELEVATION; SHEET I-603	
133	SHIFT SUPERVISOR DORM	CPT-2	RB-1	PNT-3	PNT-1	PNT-1	PNT-1	GYP/PNT-5	EXPOSED STRUCTURE; PAINT PNT-6; SEE INTERIOR ELEVATIONS FOR WALL GRAPHIC IMAGE AND SIZE; SHEET I-603	
134	SHIFT SUPERVISOR OFFICE	CPT-2	RB-1	PNT-1	PNT-1	PNT-1	PNT-1	GYP/PNT-5		
135	PUBLIC RESTROOM	STC-1	TB-1	PNT-6/T-1	PNT-6/T-1	PNT-6/T-1	PNT-6/T-1	GYP/PNT-5		
136	LOBBY	STC-1	RB-1	PNT-3/WC-1	PNT-1	PNT-1	PNT-2	NONE	EXPOSED STRUCTURE; PAINT PNT-6; SEE INTERIOR ELEVATIONS FOR WALL GRAPHIC IMAGE AND SIZE; SHEET I-603	
137	VESTIBULE	WC-1	RB-1	PNT-1	PNT-1	PNT-1	PNT-1	GYP/PNT-5		
138	DEPARTMENT TRAINING	CPT-1	RB-1	PNT-3	PNT-3	PNT-1	PNT-2	ACT-1		
139	COMPUTER TRAINING/TESTING	CPT-1	RB-1	PNT-3	PNT-1	PNT-1	PNT-2	ACT-1	EXPOSED STRUCTURE; PAINT PNT-6	
140	TRAINING STORAGE/LIBRARY	CPT-1	RB-1	PNT-1	PNT-1	PNT-1	PNT-1	ACT-1		
141	CORRIDOR	STC-1	RB-1	PNT-3	PNT-1	PNT-1	PNT-1	NONE		
142	MECHANICAL	SC-1	RB-1	PNT-6	PNT-6	PNT-6	PNT-6	NONE	EXPOSED STRUCTURE; PAINT PNT-6	
143	ELECTRICAL	SC-1	RB-1	PNT-6	PNT-6	PNT-6	PNT-6	NONE	EXPOSED STRUCTURE; PAINT PNT-6	
144	BASE IT/COMM	SC-1	RB-1	PNT-1	PNT-1	PNT-1	PNT-1	NONE	EXPOSED STRUCTURE; PAINT PNT-6	
145	JAN	SC-1	RB-1	PNT-6	PNT-6	PNT-6	PNT-6/T-1	GYP/PNT-5	SEE TYPICAL RESTROOM WALL ELEVATION; SHEET I-603	



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		SUBMITTED BY:	MEF19013
		MASON & HANGAR	
SIZE:	CAD CODE:		
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MOBILE DISTRICT
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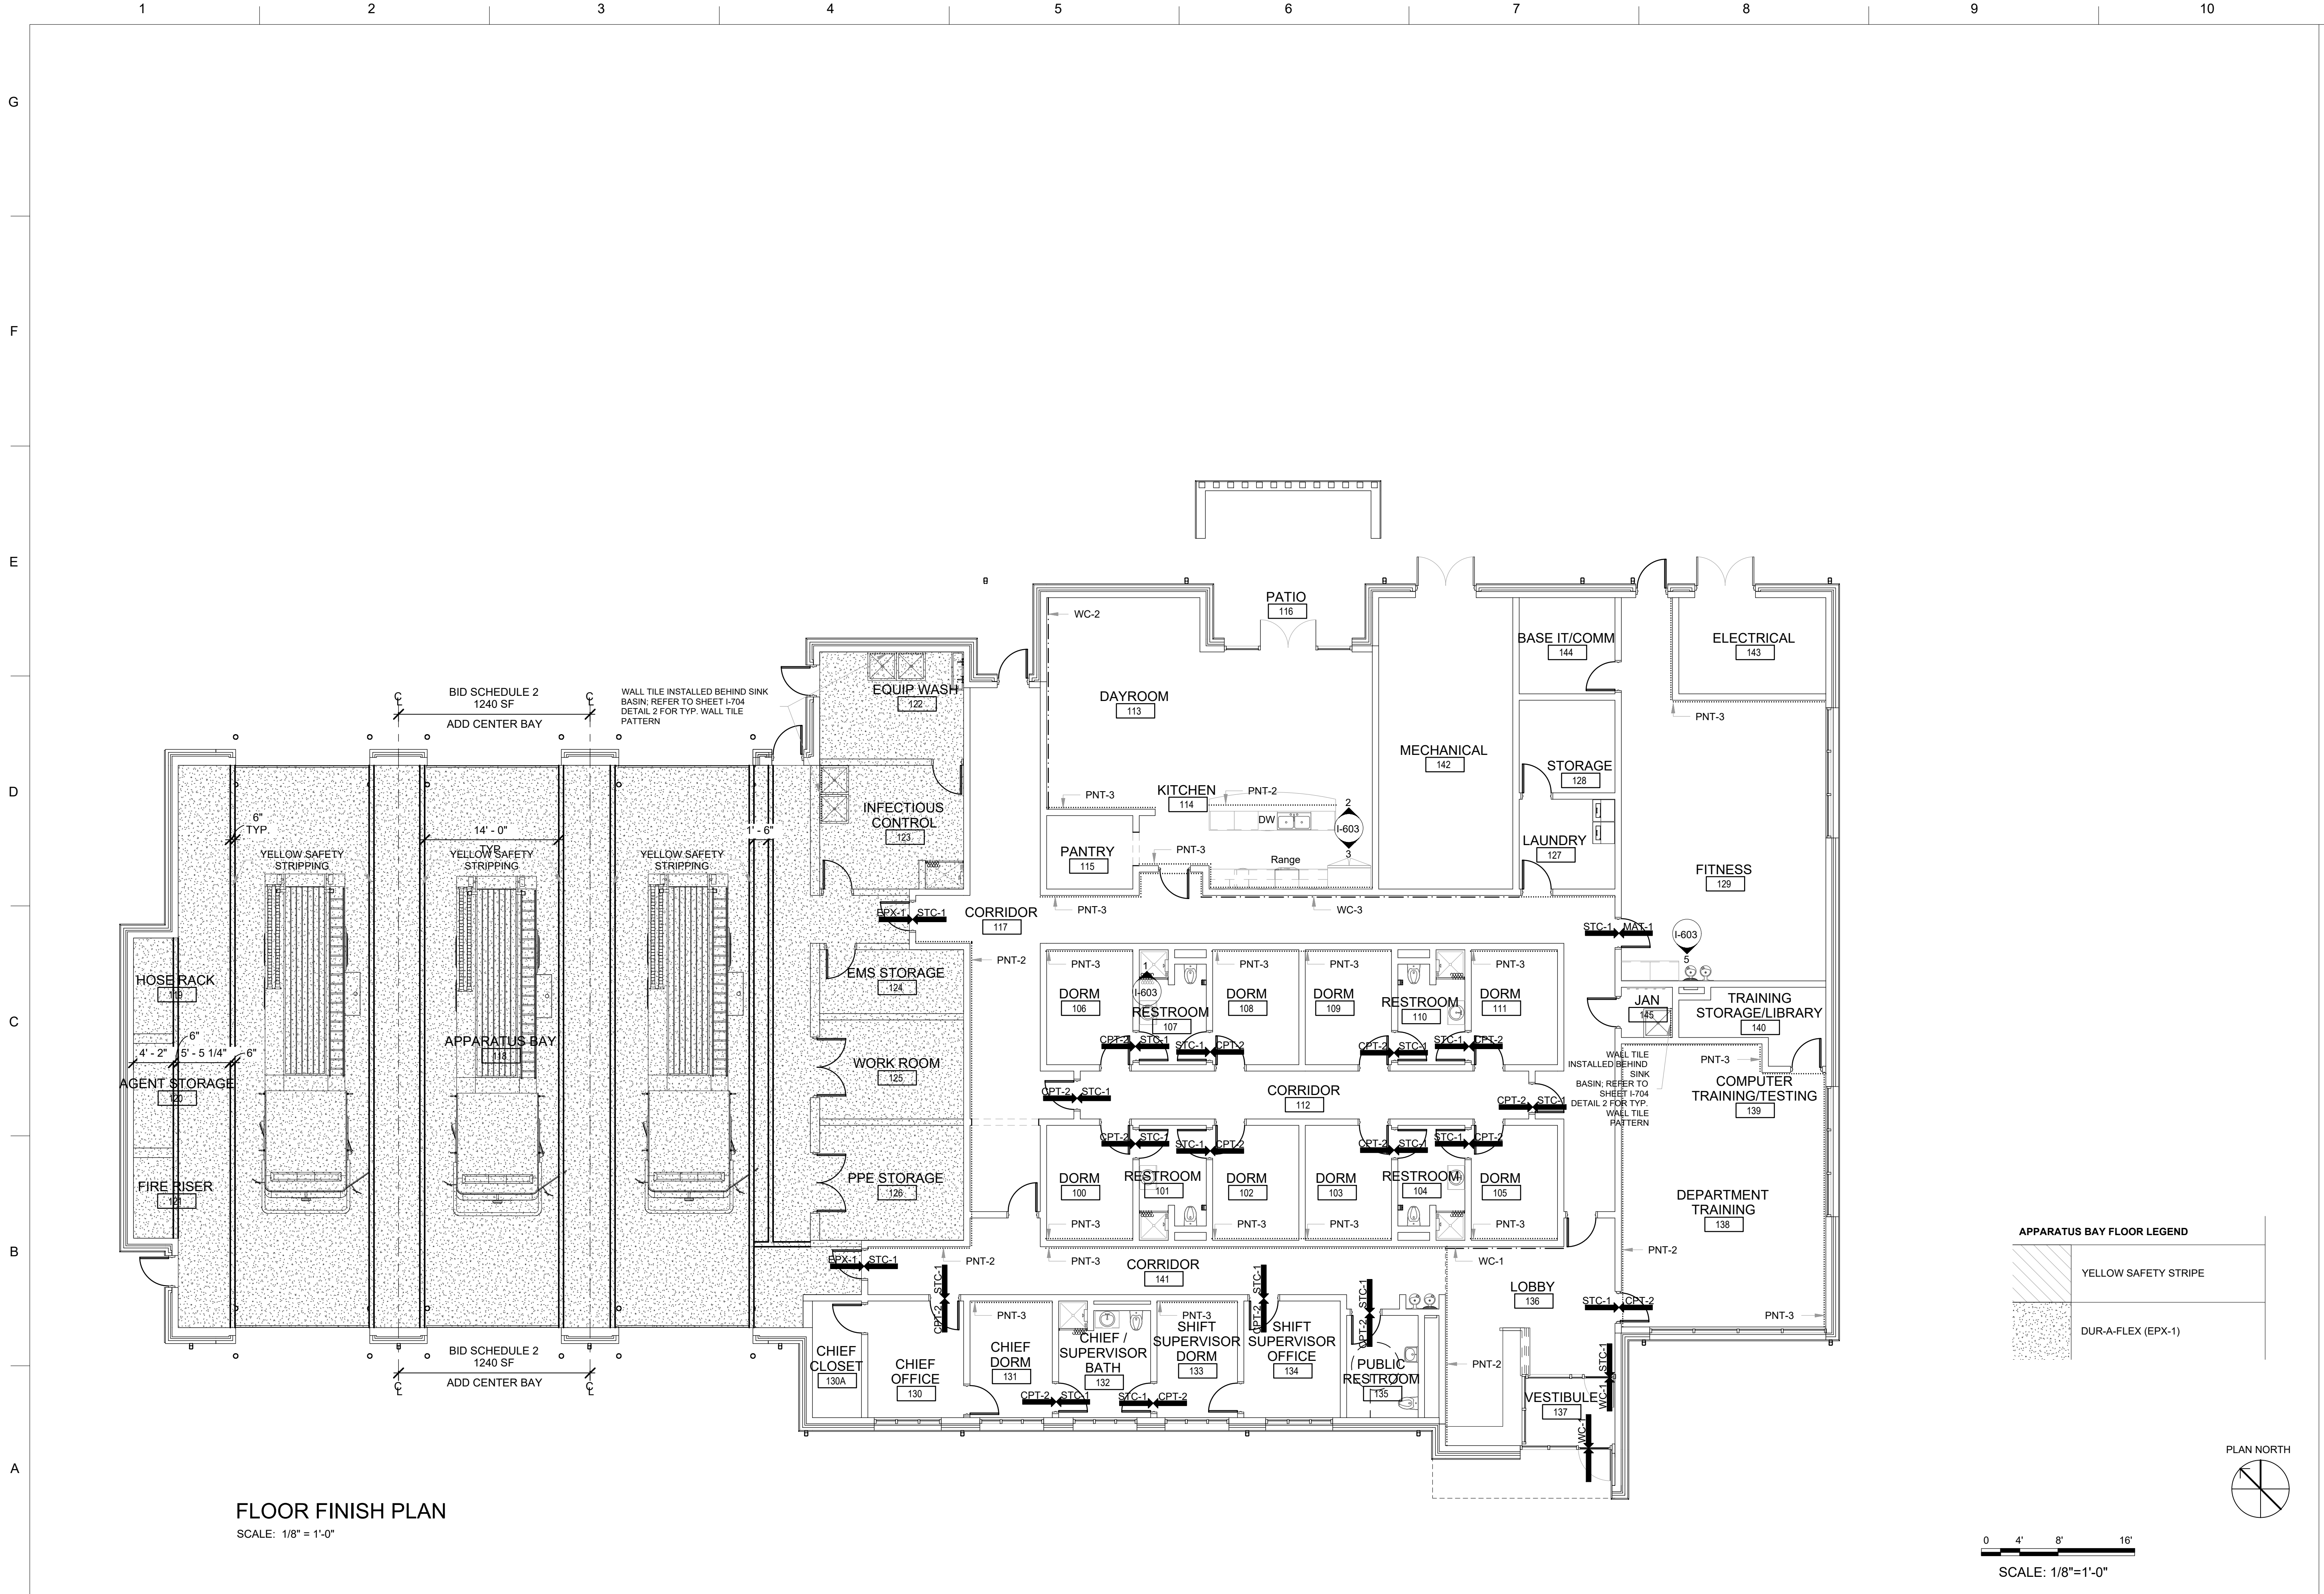
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CONSTRUCT FIRE STATION #2
FY 2019, PNXLWU193005

FINISH LEGENDS & SCHEDULES

SHEET ID

I-601



FLOOR FINISH PLAN
SCALE: 1/8" = 1'-0"

APPARATUS BAY FLOOR LEGEND	
	YELLOW SAFETY STRIPE
	DUR-A-FLEX (EPX-1)

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SOLUTION NO.:	SOLUTION NO.:	SOLUTION NO.:	SOLUTION NO.:
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DESCRIPTION	DESCRIPTION	DESCRIPTION	DESCRIPTION
DATE	DATE	DATE	DATE

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FINISH PLANS

SHEET ID
I-602

