

RAY E. WILLIAMS 4239

624 South McDonough Street

Montgomery, AL 36104

www.bdwarchitects.com

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Barganier

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Associated


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Drawn By: Date: AS NOTED Scale: Drawing Title:

> ANNOTATED FLOOR PLAN

Sheet No:

CONSTRUCTION DOCUMENTS

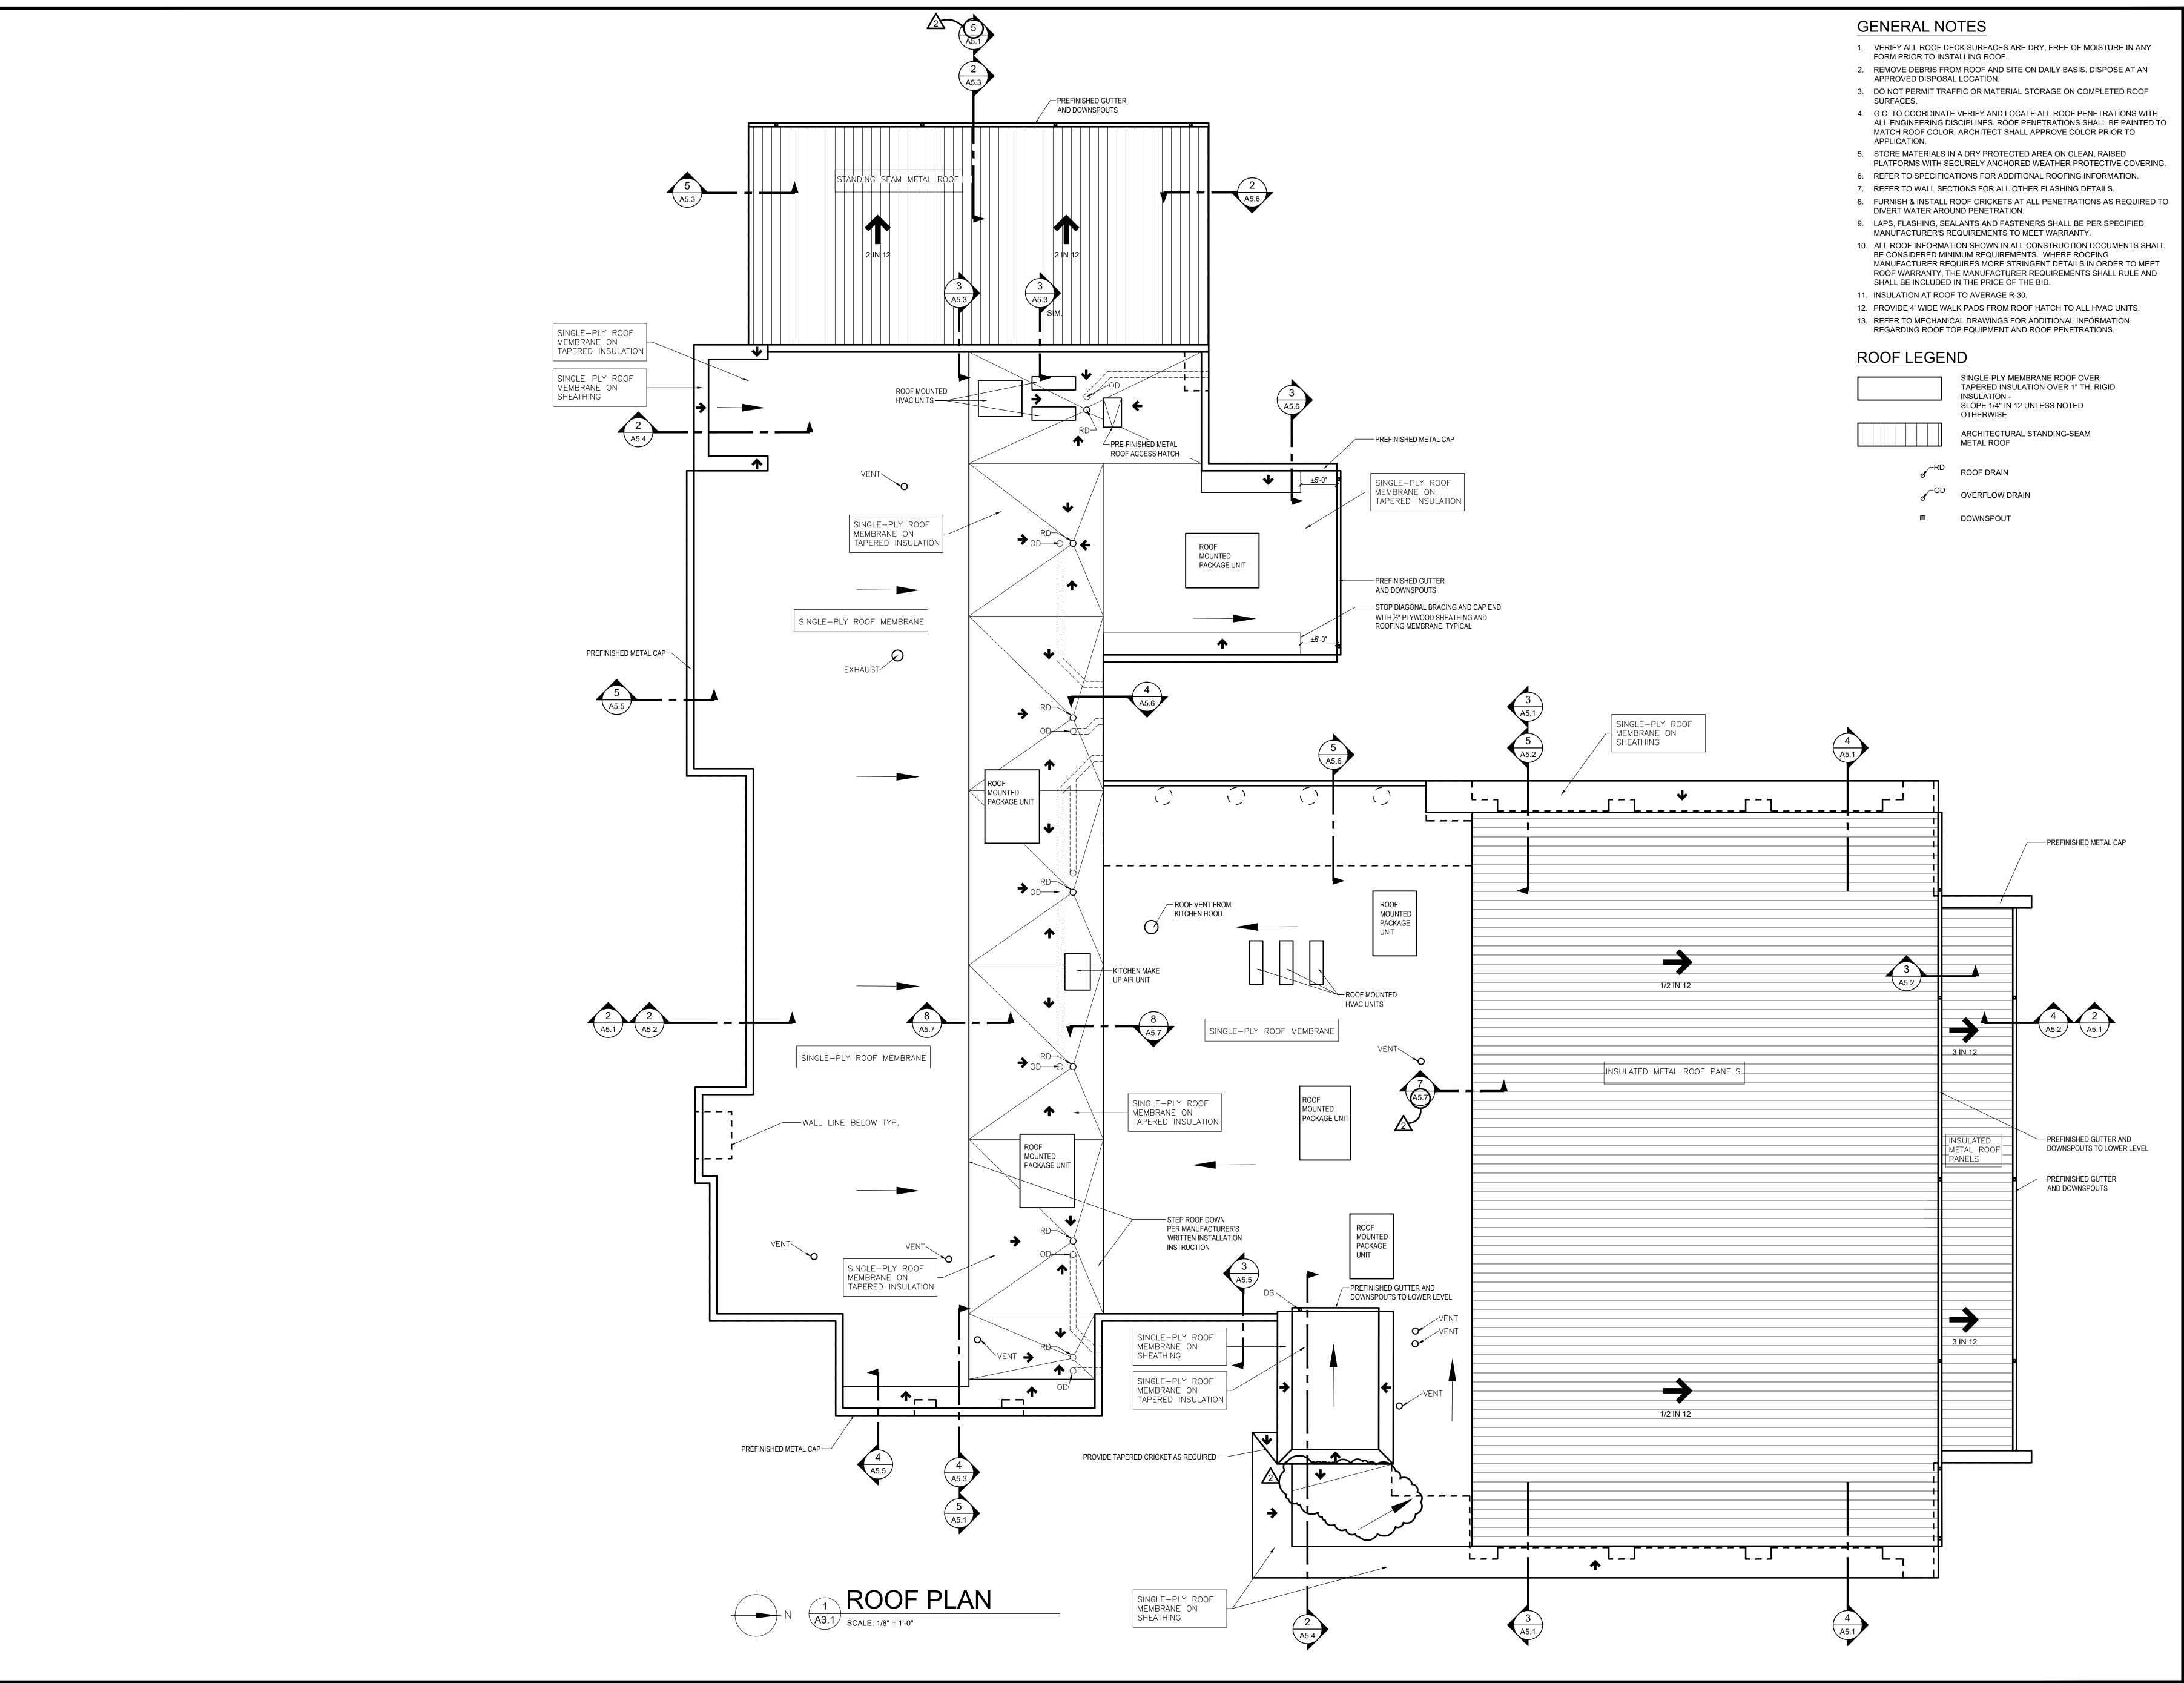

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JOHNNY B. RAINES, III
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THE CITY OF MONTGOMERY ALABAMA 36104

REVISIONS
No. Description Date
A ISSUED FOR REVIEW 11/08/22
B ISSUED FOR REVIEW 11/15/22
0 ISSUED FOR REVIEW 01/16/23
1 ISSUED FOR BID 02/03/23
2 ADDENDUM NO. 2 02/13/23

MGM Project No. SP-5-21
BDW Project No. 2021-118
Drawn By: BDW
Date:
Scale: AS NOTED

ROOF PLAN


Sheet No:

Drawing Title:


A3.1

CONSTRUCTION DOCUMENTS

BUILDING SECTION SCALE: 1/8" = 1'-0"

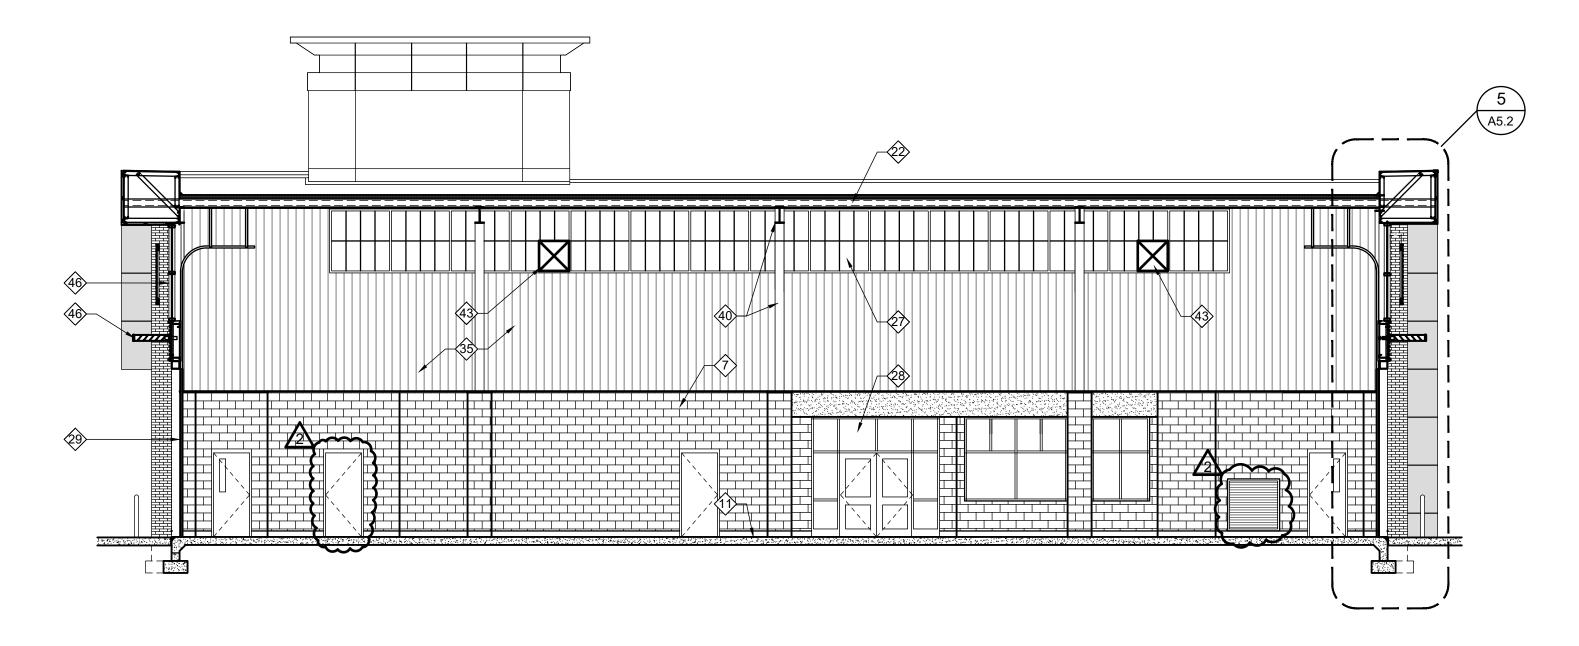




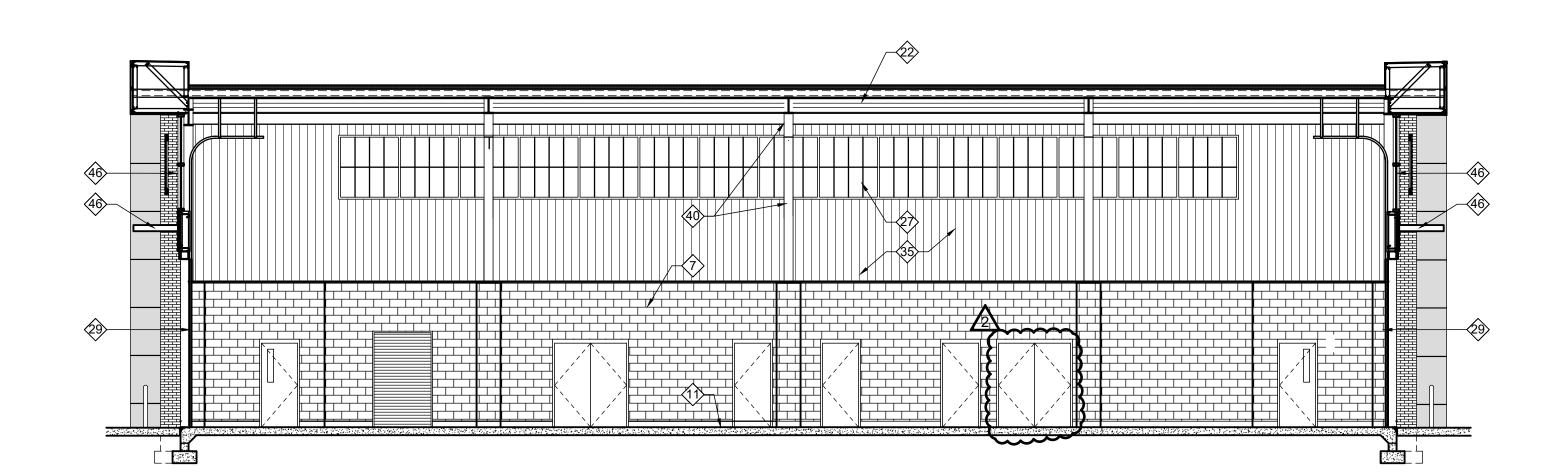

4 BUILDING SECTION A5.1 SCALE: 1/8" = 1'-0"

BUILDING SECTION

A5.1 SCALE: 1/8" = 1'-0"

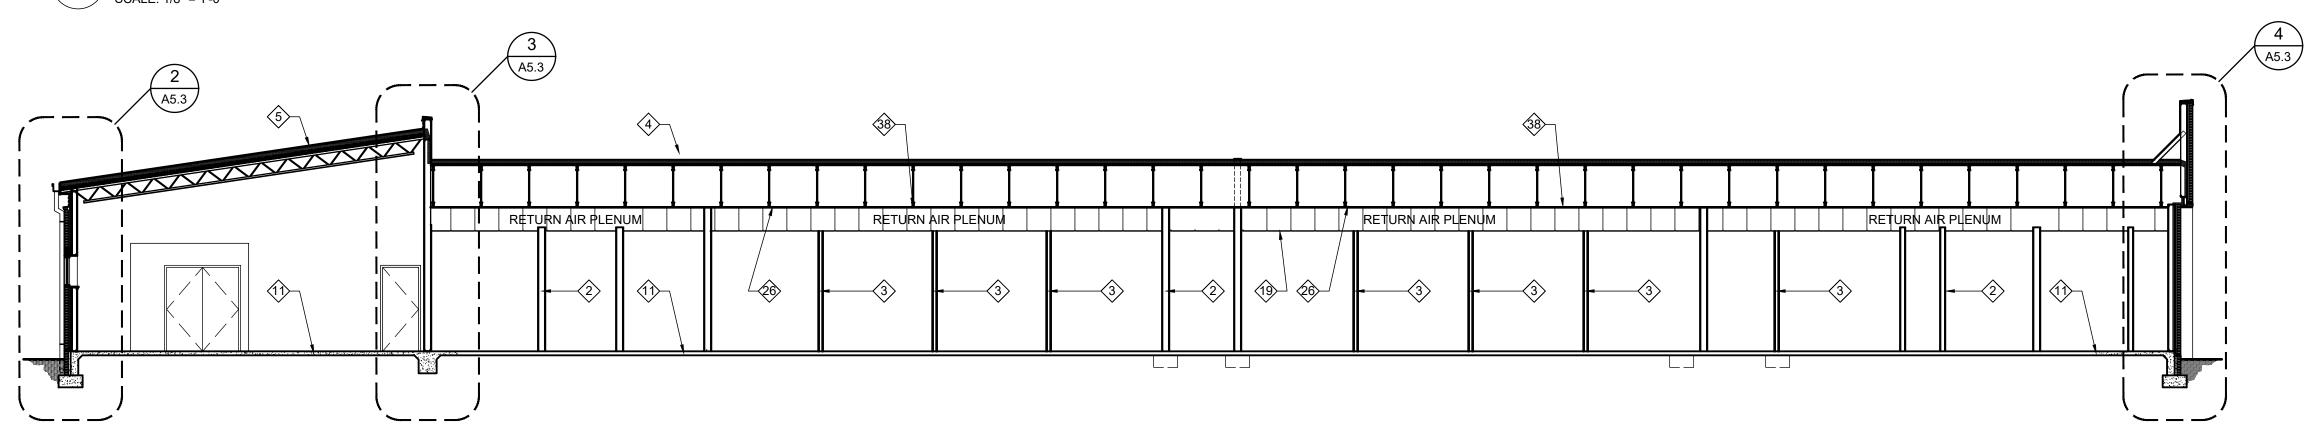

GENERAL NOTES

- CONTRACTOR TO VERIFY EXISTING CONDITIONS PRIOR TO ANY FABRICATION OR
- CONSTRUCTION.

 2. CONTRACTOR TO NOTIFY ARCHITECT OF ANY DISCREPANCIES AND OBTAIN OWNER

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- APPROVAL FOR ANY CHANGES.

 3. ALL WOOD DECKING, FRAMING OR BLOCKING SHALL BE PRESSURE TREATED.
- REFER TO STRUCTURAL DRAWINGS FOR FRAMING MEMBER SIZING, CONCRETE REINFORCING AND ADDITIONAL INFORMATION.
- 5. COORDINATE FOOTING ELEVATIONS AND FINAL GRADES WITH CIVIL ENGINEERING DRAWINGS

KEYNOTES

ALL KEYNOTES ON THIS LIST ARE NOT PRESENT ON EACH DRAWING

- 1. BRICK VENEER. REFER TO SPECIFICATIONS
- 2. 5/8" GYPSUM BOARD ON METAL WALL STUD FRAMING AT 16" O.C. WITH 1/2" EXTERIOR FIRE TREATED PLYWOOD SHEATHING. REFER TO FLOOR PLANS FOR FRAMING SIZING
- 3. %" GYPSUM BOARD SHEATHING EACH SIDE OF 3%" METAL WALL STUD FRAMING AT 16" O.C. TO UNDERSIDE OF SUSPENDED CEILING
- 4. TPO MEMBRANE ROOFING ON $\frac{1}{2}$ " DECK BOARD OVER ±4" (R-30) RIGID INSULATION BOARD ON METAL ROOF DECKING, WHERE SHOWN. REFER TO SPECIFICATIONS

5. STANDING SEAM METAL ROOFING ON ½" DECK BOARD OVER ±4" (R-30) RIGID

- INSULATION BOARD ON METAL ROOF DECKING
- 6. PROVIDE MINIMUM R-19 CLOSED CELL SPAY FOAM INSULATION. REFER TO SPECIFICATIONS
- 7. CONCRETE BLOCK WALL. PROVIDE INSULATION IN BLOCK CORE AT EXTERIOR
- LOCATIONS
 8. LIQUID APPLIED VAPOR & MOISTURE BARRIER
- 9. 1½" RIGID INSULATION BOARD
- 10. EXTEND ROOFING MEMBRANE OVER ½" EXTERIOR GRADE FIRE TREATED PLYWOOD SHEATHING
- CONCRETE FLOOR SLAB ON COMPACTED GRANULAR FILL. REFER TO STRUCTURAL DRAWINGS. EXTERIOR SLABS SHALL SLOPE AWAY FROM BUILDING FOR DRAINAGE
 PVC TRIM, PAINTED
- 13. STEEL BEAM / COLUMN. REFER TO STRUCTURAL DRAWINGS
- 14. CLOSE OFF OPENINGS OR FILL VOIDS WITH CLOSED CELL SPRAY FOAM INSULATION
- 15. PRE-FINISHED SHEET METAL GUTTER & DOWNSPOUT16. GROUT VOIDS SOLID
- 17. PROVIDE CONTINUOUS PRE-FINISHED METAL FLASHING
- 18. PROVIDE CONTINUOUS PRE-FINISHED METAL COPING OVER PRESSURE-TREATED WOOD BLOCKING. PROVIDE FLASHING
- 19. SUSPENDED ACOUSTIC TILE CEILING IN PRE-FINISHED METAL GRID20. CONTINUOUS BASE FLASHING WITH WEEP HOLES AT 24" O.C. PROVIDE 24" HIGH
- MORTAR NET AT BOTTOM OF AIR SPACE. BASE FLASHING TO BE TWO BRICK COURSES BELOW FINISH FLOOR

 21. METAL GIRT WALL SYSTEM WITH EXTERIOR PRE-FINISHED METAL PANEL OVER ½"
- FIRE TREATED PLYWOOD SHEATHING, R-19 MIN. SPRAY FOAM INSULATION AND INTERIOR PRE-FINISHED METAL LINER PANEL


 22. CONCEALED FASTENER PRE-FINISHED INSULATED METAL PANEL ROOF SYSTEM,
- R-30, ON METAL PURLINS
 23. CORRUGATED METAL SIDING
- 24. STANDING SEAM METAL ROOFING ON 1½" METAL DECKING ON METAL ROOF TRUSSES WITH R-30 VINYL FACED BATT INSULATION
- 25. ½" GYPSUM BOARD CEILING ON SUSPENDED METAL CHANNELS
- 26. METAL ROOF TRUSS. REFER TO STRUCTURAL DRAWINGS27. TRANSLUCENT PANEL SYSTEM. REFER TO SPECIFICATIONS
- 28. GLASS & ALUMINUM STOREFRONT SYSTEM. REFER TO SPECIFICATIONS
- 29. MOTOR OPERATED PRE-FINISHED OVERHEAD SECTIONAL METAL DOOR AND TRACK. REFER TO DOOR SCHEDULE & SPECIFICATIONS
- 30. ALUMINUM PANEL CLADDING SYSTEM. REFER TO SPECIFICATIONS
- 31. 6"H x 36"D PRE-FINISHED ALUMINUM LOUVERED 'ECOSHADE' AWNING WITH SIX 35° BLADES BY MASA ARCHITECTURAL CANOPIES (www.architecturalcanopies.com) OR APPROVED EQUAL
- 32. 42" HIGH x 6" DIA. CONCRETE FILLED STEEL PIPE BOLLARD. REFER TO DETAIL 1/A5.533. CONCRETE PAVEMENT. SEE CIVIL ENGINEERING DRAWINGS
- 34. PROVIDE CAST IRON DOWNSPOUT BOOT AND CONNECT TO UNDERGROUND STORM WATER COLLECTION SYSTEM. SEE CIVIL ENGINEERING DRAWINGS


36. FIBER CEMENT BOARD CLADDING SYSTEM OVER ½" FIRE TREATED PLYWOOD WITH

- 35. PRE-FINISHED METAL LINER PANEL. SEE SPECIFICATIONS
- METAL FRAMING AT 16" O.C. REFER TO SPECIFICATIONS

 37. PRE-FINISHED VENTED METAL SOFFIT PANEL
- 38. TOP OF RETURN AIR PLENUM: ½" GYPSUM BOARD ON METAL CHANNELS
- 39. EMBEDDED STEEL ANGLE40. PRE-ENGINEERED RIGID STEEL FRAME. REFER TO STRUCTURAL DRAWINGS
- 41. PROVIDE EXPANSION JOINT
 42. ½" FIRE TREATED PLYWOOD SHEATHING ON LIGHT GAUGE METAL FRAMING. REFER
- TO STRUCTURAL DRAWINGS

 43. HVAC DUCTWORK FROM ROOF TOP UNITS. REFER TO MECHANICAL DRAWINGS
- 44. %" GYPSUM BOARD SHEATHING ON METAL WALL STUDS AT 16" O.C.
- 45. PROVIDE CONTINUOUS PRE-FINISHED METAL COPING OVER BEAD OF SEALANT
 46. 60" HIGH PRE-FINISHED ALUMINUM PERFORATED 0.040" PANEL, BR5-36 ¾"
 ECONOLAP BY CENTRIA, WITH APPLIED LETTERING ON 2'x6" ANODIZED ALUMINUM
- ECONOLAP BY CENTRIA, WITH APPLIED LETTERING ON 2'x6" ANODIZED ALUMINUM TUBES WITH INTERMEDIATE VERTICALS TO ALIGN WITH WINDOW FRAME. SEE BUILDING ELEVATIONS
- 47. 8" x 8" RECESS. SEE BUILDING ELEVATIONS
- 48. DIAGONAL BRACE. SEE STRUCTURAL DRAWINGS49. COMPRESSIBLE EXPANSION MATERIAL
- 50. PRE-FINISHED ALUMINUM COLUMN COVER
- 51. EXTEND ROOF PURLIN. SEE STRUCTURAL DRAWINGS52. PRE-FINISHED METAL TRIM. AXIOM CLASSIC TRIM BY ARMSTRONG OR APPROVED
- 53. PROVIDE ICE & WATER SHIELD MEMBRANE ON HORIZONTAL AREAS. EXTEND
- MEMBRANE MINIMUM 6" ON ADJOINING VERTICAL SURFACES.
 54. X-BRACING. SEE STRUCTURAL DRAWINGS
- 55. SOLID SURFACE SILL AND APRON
- 56. 3" x ½" PVC BLOCKING AT SCREW DOWN LOCATIONS. DO NOT CAULK STOREFRONT
- TO ROOF MEMBRANE. ALLOW STORMWATER TO FLOW UNDER STOREFRONT
 BREAK METAL TRIM (MATCH STOREFRONT) OVER WOOD BLOCKING
- 57. BREAK METAL TRIM (MATCH STOREFRONT) OVER WOOD BLOCKING

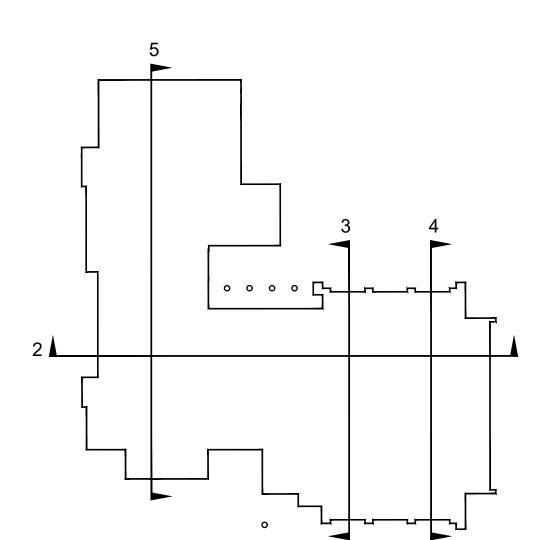

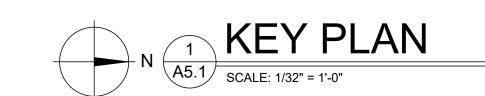

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7 (0.1

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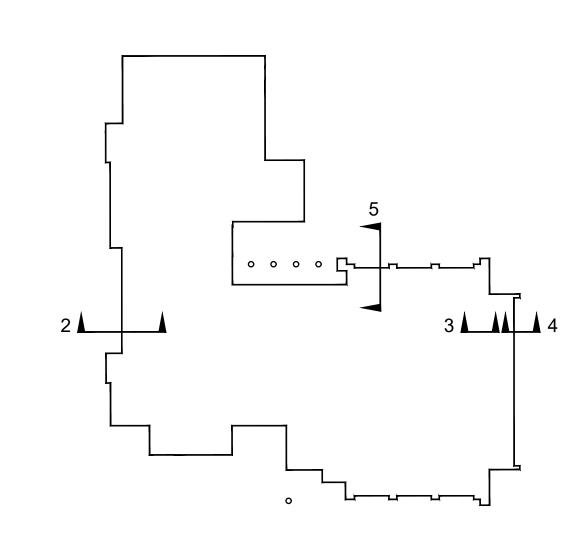
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- 8. LIQUID APPLIED VAPOR & MOISTURE BARRIER
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B ISSUED FOR REVIEW 0 ISSUED FOR REVIEW 1 ISSUED FOR BID ADDENDUM NO. 2 MGM Project No. BDW Project No. 2021-118 Drawn By: AS NOTED

Drawing Title:

WALL SECTIONS

A5.2

CONSTRUCTION DOCUMENTS

DOOR SCHEDULE											
MARK	SIZE	DOOR TYPE	MATERIAL	FR TYPE	AME MATERIAL	FIRE RATING	SIGNAGE	HEAD	DETAILS JAMB	SILL	REMARKS
101	PR 3'-0" x 8'-0"	SF-1	S.F.	SF-A	S.F.			1/A6.5	2/A6.5	O.L.L	
102	3'-0" x 7'-0"	В	WOOD	С	H.M.		UNI-SEX TOILET	1/A6.4	2/A6.4	3/A6.4	
103 104	PR 3'-0" x 8'-0" 3'-0" x 7'-0"	SF-1	S.F. WOOD	SF-B C	S.F.		STORAGE	21/A6.4 1/A6.4 (sim.)	22/A6.4 2/A6.4 (sim.)	3/A6.4 (sim.)	1
105	3'-0" x 7'-0"	В	WOOD	С	H.M.		UNI-SEX TOILET	1/A6.4 (SIIII.)	2/A6.4 (SiIII.)	3/A6.4	
108	3'-0" x 7'-0"	В	WOOD	С	H.M.	45 MINUTES		1/A6.4	2/A6.4	3/A6.4	
109A	3'-0" x 7'-0"	SF-2	S.F.	SF-C	S.F.			13/A6.4	14/A6.4		
109B 110	3'-0" x 7'-0" 3'-0" x 7'-0"	SF-2	S.F. WOOD	E C	S.F.			5/A6.5 1/A6.4 (sim.)	6/A6.5 2/A6.4 (sim.)	3/A6.4 (sim.)	
111	3'-0" x 7'-0"	В	WOOD	С	H.M.		I.T.	1/A6.4 (sim.)	2/A6.4 (sim.)	3/A6.4 (sim.)	
112	3'-0" x 7'-0"	В	WOOD	SF-P	S.F.		COMMAND WATCH	1/A6.4	2/A6.4	3/A6.4	
113A	PR 3'-0" x 7'-0"	SF-5	S.F.	SF-D	S.F.			19/A6.4	20/A6.4		
113B 113C	3'-0" x 7'-0" PR 7'-0" x 14'-0"	G BD-1	GHM SECTIONAL OVERHEAD	В	GHM			7/A6.4	8/A6.4	9/A6.4	
113D	PR 7'-0" x 14'-0"	BD-1	SECTIONAL OVERHEAD								
113E	PR 7'-0" x 14'-0"	BD-1	SECTIONAL OVERHEAD								
113F	3'-0" x 7'-0"	G	GHM	В	GHM			11/A6.4	12/A6.4		
113G 113H	3'-0" x 7'-0" PR 7'-0" x 14'-0"	G BD-1	GHM SECTIONAL OVERHEAD	В	GHM			11/A6.4	12/A6.4		
113J	PR 7'-0" x 14'-0"	BD-1	SECTIONAL OVERHEAD								
113K	PR 7'-0" x 14'-0"	BD-1	SECTIONAL OVERHEAD								
113L	3'-0" x 7'-0"	G	GHM	В	GHM			11/A6.4	12/A6.4		
114	5'-0" x 8'-0"	F	ROLL UP DOOR		OL INA		GEAR STORAGE	10/A6.4	11/A6.4	0/40-4	
115 116	PR 3'-0" x 7'-0" 3'-0" x 7'-0"	A	GHM GHM	В	GHM GHM		LAUNDRY WASH ROOM	4/A6.4 4/A6.4	5/A6.4 5/A6.4	6/A6.4 6/A6.4	
117	3'-0" x 7'-0"	A	GHM	В	GHM		UNI-SEX TOILET	4/A6.4 4/A6.4	5/A6.4	6/A6.4	
118	3'-0" x 7'-0"	A	GHM	В	GHM		UNI-SEX TOILET	4/A6.4	5/A6.4	6/A6.4	
119	PR 3'-0" x 7'-0"	E	GHM	A	GHM		CASCADE	4/A6.4	5/A6.4	6/A6.4	
120 121	PR 3'-0" x 7'-0" 3'-0" x 7'-0"	Ε	GHM	В	GHM		STORAGE STORAGE	7/A6.4 4/A6.4	8/A6.4 5/A6.4	9/A6.4 6/A6.4	2
125A	3'-0" x 7'-0"	A	GHM	В	GHM		SUPPLY	4/A6.4	5/A6.4 5/A6.4	6/A6.4	
125B	3'-0" x 7'-0"	Α	GHM	В	GHM		SUPPLY	4/A6.4	5/A6.4	6/A6.4	
126	3'-0" x 7'-0"	SF-2	S.F.	SF-G	S.F.			13/A6.4	3/A6.5		
127A	3'-0" x 7'-0" 3'-0" x 7'-0"	В	WOOD	SF-Z	S.F.		MEDIC OFFICE	1/A6.4	2/A6.4	3/A6.4	
128 129	3'-0" x 7'-0"	В	WOOD	С	H.M.		BUNK 1 BUNK 2	1/A6.4 1/A6.4	2/A6.4 2/A6.4	3/A6.4 3/A6.4	
130	3'-0" x 7'-0"	В	WOOD	С	H.M.		B0111112	1/A6.4	2/A6.4	3/A6.4	
131A	3'-0" x 7'-0"	В	WOOD	SF-Z	S.F.		SUPPRESSION OFF.	1/A6.4	2/A6.4	3/A6.4	
132	3'-0" x 7'-0"	В	WOOD	С	H.M.		BUNK 3	1/A6.4	2/A6.4	3/A6.4	
133 134	3'-0" x 7'-0" 3'-0" x 7'-0"	В	WOOD	С	H.M.		BUNK 4	1/A6.4 1/A6.4	2/A6.4 2/A6.4	3/A6.4 3/A6.4	
135	3'-0" x 7'-0"	В	WOOD	С	H.M.		JAN.	1/A6.4	2/A6.4	3/A6.4	
136	3'-0" x 7'-0"	В	WOOD	С	H.M.		BATTALION CHIEF	1/A6.4	2/A6.4	3/A6.4	
137	2'-6" x 7'-0"	В	WOOD	С	H.M.			1/A6.4	2/A6.4	3/A6.4	
138 139	3'-0" x 7'-0" 3'-0" x 7'-0"	В	WOOD	С	H.M.			1/A6.4 1/A6.4	2/A6.4 2/A6.4	3/A6.4	
140	3'-0" x 7'-0"	В	WOOD	С	H.M.	45 MINUTES		1/A6.4	2/A6.4 2/A6.4	3/A6.4 3/A6.4	
141	3'-0" x 7'-0"	В	WOOD	С	H.M.		BUNK 6	1/A6.4	2/A6.4	3/A6.4	
142	3'-0" x 7'-0"	В	WOOD	С	H.M.		BUNK 7	1/A6.4	2/A6.4	3/A6.4	
143 144	3'-0" x 7'-0" 3'-0" x 7'-0"	В	WOOD	С	H.M.		BUNK 8	1/A6.4	2/A6.4	3/A6.4	
144 145	3'-0" x 7'-0"	В	WOOD	С	H.M.		BUNK 9 BUNK 10	1/A6.4 1/A6.4	2/A6.4 2/A6.4	3/A6.4 3/A6.4	
146	3'-0" x 7'-0"	В	WOOD	С	H.M.		BUNK 11	1/A6.4	2/A6.4	3/A6.4	
147	3'-0" x 7'-0"	В	WOOD	С	H.M.		BUNK 12	1/A6.4	2/A6.4	3/A6.4	
148	3'-0" x 7'-0"	В	WOOD	С	H.M.		BUNK 13	1/A6.4	2/A6.4	3/A6.4	
149 150	3'-0" x 7'-0" 3'-0" x 7'-0"	В	WOOD	С	H.M.		BUNK 14 BUNK 15	1/A6.4 1/A6.4	2/A6.4 2/A6.4	3/A6.4 3/A6.4	
151	3'-0" x 7'-0"	В	WOOD	С	H.M.		BUNK 16	1/A6.4	2/A6.4	3/A6.4	
152	3'-0" x 7'-0"	В	WOOD	С	H.M.		BUNK 17	1/A6.4	2/A6.4	3/A6.4	
153	3'-0" x 7'-0"	В	WOOD	С	H.M.	45 MINUTES		1/A6.4	2/A6.4	3/A6.4	
155 156A	3'-0" x 7'-0" 3'-0" x 7'-0"	В	WOOD	С	H.M. GHM		STORAGE SHOWERS	1/A6.4 1/A6.4	2/A6.4 2/A6.4	3/A6.4 3/A6.4	
156B	3'-0" x 7'-0"	В	WOOD	С	GHM		TOILETS / SHOWERS		2/A6.4 2/A6.4	3/A6.4 3/A6.4	
156D	2'-6" x 7'-0"	С	FIBERGLASS	D	FIBERGLASS			1/A6.4	2/A6.4	3/A6.4	
156E	2'-6" x 7'-0"	С	FIBERGLASS	D	FIBERGLASS			1/A6.4	2/A6.4	3/A6.4	
156F 156G	2'-6" x 7'-0" 3'-0" x 7'-0"	С	FIBERGLASS FIBERGLASS	D	FIBERGLASS FIBERGLASS			1/A6.4 1/A6.4	2/A6.4 2/A6.4	3/A6.4 3/A6.4	
156G 156H	2'-6" x 7'-0"	C	FIBERGLASS	D	FIBERGLASS			1/A6.4 1/A6.4	2/A6.4 2/A6.4	3/A6.4 3/A6.4	
1561	2'-6" x 7'-0"	C	FIBERGLASS	D	FIBERGLASS			1/A6.4	2/A6.4	3/A6.4	
156J	3'-0" x 7'-0"	D	WOOD	D	GHM			1/A6.4	2/A6.4	3/A6.4	
156K	2'-6" x 7'-0" 2'-6" x 7'-0"	D	WOOD	D	GHM			1/A6.4	2/A6.4	3/A6.4	
156L 156M	2'-6" x 7'-0" 2'-6" x 7'-0"	D	WOOD	D D	GHM			1/A6.4 1/A6.4	2/A6.4 2/A6.4	3/A6.4 3/A6.4	
156N	(3'-0" x 7'-0") 2	D	WOOD	D	GHM			1/A6.4	9/A6.5 2	3/A6.4	
1560	2'-6" x 7'-0"	D	WOOD	D	GHM			1/A6.4	2/A6.4	3/A6.4	
156P	2'-6" x 7'-0"	D	WOOD	D	GHM			1/A6.4	2/A6.4	3/A6.4	
156Q 157	2'-6" x 7'-0" 3'-0" x 7'-0"	D B	WOOD	C	GHM H.M.		BUNK 18	1/A6.4 1/A6.4	2/A6.4 2/A6.4	3/A6.4 3/A6.4	
158	3'-0" x 7'-0"	В	WOOD	С	H.M.		BUNK 19	1/A6.4	2/A6.4 2/A6.4	3/A6.4	
159	3'-0" x 7'-0"	В	WOOD	С	H.M.		BUNK 20	1/A6.4	2/A6.4	3/A6.4	
160	3'-0" x 7'-0"	В	WOOD	С	H.M.		BUNK 21	1/A6.4	2/A6.4	3/A6.4	
161 162	3'-0" x 7'-0" 3'-0" x 7'-0"	В	WOOD	С	H.M.		BUNK 22 BUNK 23	1/A6.4	2/A6.4 2/A6.4	3/A6.4	
163	3'-0" x 7'-0"	В	WOOD	С	H.M.		BUNK 24	1/A6.4 1/A6.4	2/A6.4 2/A6.4	3/A6.4 3/A6.4	
164	3'-0" x 7'-0"	В	WOOD	С	H.M.		UNI-SEX TOILET	1/A6.4	2/A6.4	3/A6.4	
165	3'-0" x 7'-0"	В	WOOD	С	H.M.	45 MINUTES	0111 027 101221	1/A6.4	2/A6.4	3/A6.4	
166	PR 3'-0" x 7'-0"	E	H.M.	А	H.M.	20 MINUTES	TRAINING	7/A6.5	8/A6.5		

	DOOR SCHEDULE										
MARK	DOOR			FRAME		FIRE	CICNACE	DETAILS			
	SIZE	TYPE	MATERIAL	TYPE	MATERIAL	RATING	SIGNAGE	HEAD	JAMB	SILL	REMARKS
167	3'-0" x 7'-0"	Α	H.M.	В	H.M.		STORAGE	4/A6.4	5/A6.4	6/A6.4	
168	3'-0" x 7'-0"	G	GHM	В	GHM			5/A6.5	6/A6.5		
169	3'-0" x 7'-0"	В	WOOD	С	H.M.		STORAGE	1/A6.4	2/A6.4	3/A6.4	
170	3'-6" x 7'-0"	В	GHM	В	GHM		ELECTRICAL	5/A6.5	6/A6.5		2
171	3'-0" x 7'-0"	В	WOOD	С	H.M.		I.T.	1/A6.4	2/A6.4	3/A6.4	
172	PR 3'-0" x 7'-0"	E	H.M.	G	H.M.		MECHANICAL	1/A6.4	2/A6.4	3/A6.4	
173A	3'-0" x 7'-0"	SF-2	S.F.	SF-H	S.F.			1/A6.5	4/A6.5		
173B	3'-0" x 7'-0"	SF-2	S.F.	SF-J	S.F.			21/A6.4	22/A6.4		1
174A	3'-0" x 7'-0"	В	WOOD	С	H.M.		MEETING ROOM	1/A6.4	2/A6.4	3/A6.4	
174B	3'-0" x 7'-0"	В	WOOD	С	H.M.		MEETING ROOM	1/A6.4	2/A6.4	3/A6.4	
175	3'-0" x 7'-0"	В	WOOD	С	H.M.			1/A6.4	2/A6.4	3/A6.4	
176A	3'-0" x 7'-0"	В	WOOD	С	H.M.			1/A6.4	2/A6.4	3/A6.4	
176B	3'-0" x 7'-0"	В	WOOD	С	H.M.		OFFICE	1/A6.4	2/A6.4	3/A6.4	
177A	3'-0" x 7'-0"	В	WOOD	С	H.M.			1/A6.4	2/A6.4	3/A6.4	
177B	3'-0" x 7'-0"	В	WOOD	С	H.M.			1/A6.4	2/A6.4	3/A6.4	
178	3'-0" x 7'-0"	В	WOOD	С	H.M.		UNI-SEX TOILET	1/A6.4	2/A6.4	3/A6.4	
180	PR 3'-0" x 7'-0"	E	WOOD	G	H.M.		STORAGE	1/A6.4	2/A6.4	3/A6.4	
181	3'-0" x 7'-0"	Α	GHM	В	GHM		MECHANICAL	7/A6.4	8/A6.4	9/A6.4	2

REMARKS:

- 1. GLAZING WILL BE G6 AT THESE DOORS AND FRAMES
- 2. PROVIDE SIGNAGE "NO BUILDING ACCESS"

ABBREVIATIONS:


FRP FIBERGLASS REINFORCED PANEL
GHM GALVANIZED HOLLOW METAL, PAINTED
H.M. HOLLOW METAL, PAINTED
PR PAIR OF DOORS

S.F. STOREFRONT - ANODIZED ALUMINUM WOOD WOOD, PAINTED OR STAINED

Barganier Davis Williams Architects Associated



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NEW FIRE STATION NO. 10 FOR THE CITY OF MONTGOMERY, ALABAMA 36104

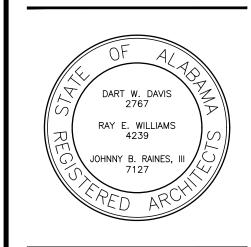REVISIONS								
No	. Description	Date						
Α	ISSUED FOR REVIEW	11/08/22						
В	ISSUED FOR REVIEW	11/15/22						
0	ISSUED FOR REVIEW	01/16/23						
1	ISSUED FOR BID	02/03/23						
2	ADDENDUM NO. 2	02/13/23						
MGM Project No. SP-5-21								
BDW Project No. 2021-118								
Drawn By: BDW								
Date:								
Sca	Scale: AS NOTED							
Drawing Title:								


SCHEDULE

Sheet No:

7 (0. 1


CONSTRUCTION DOCUMENTS



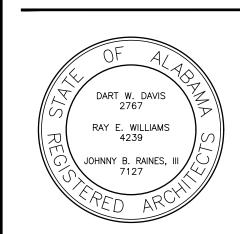

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10 TATION NEW


2 ADDENDUM NO. 2 MGM Project No. SP-5-21 BDW Project No. 2021-118 Drawn By: Date: AS NOTED Scale:

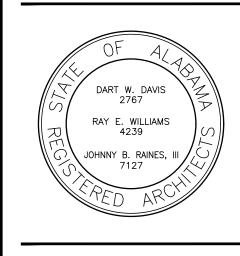
> HEAD, JAMB & SILL DETAILS


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Drawing Title:

CONSTRUCTION DOCUMENTS




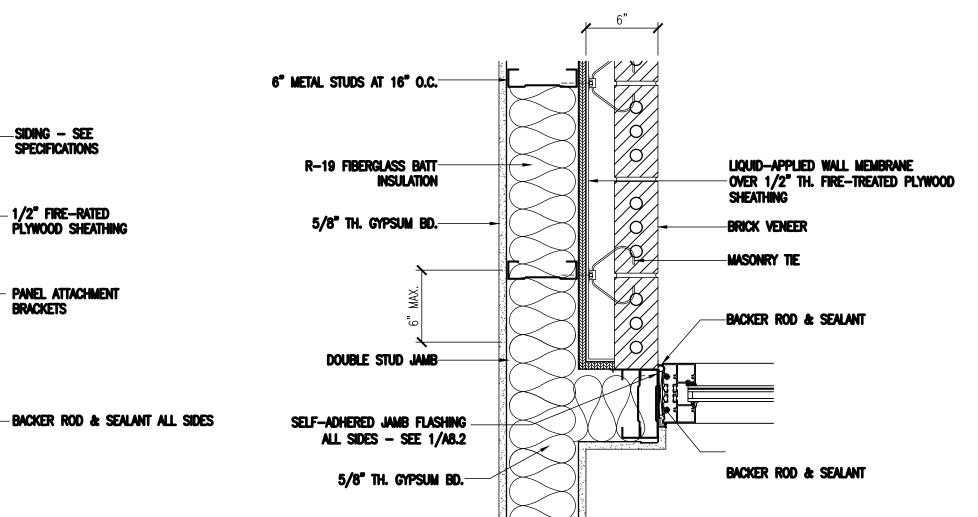

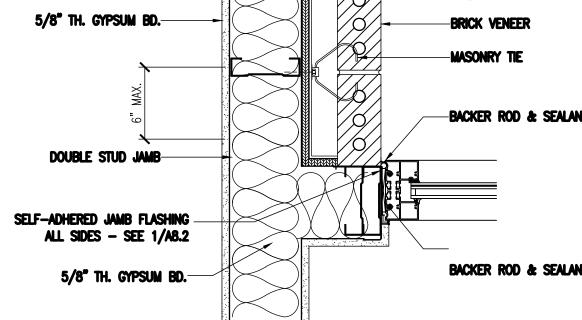

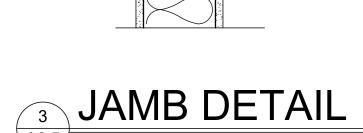



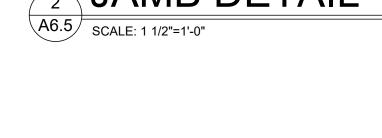

6" METAL STUDS AT 16" O.C.—

5/8" TH. GYPSUM BD.—

DOUBLE STUD JAMB-

5/8" TH. GYPSUM BD.—

BACKER ROD &-SEALANT

-METAL PANELS - SEE SPECIFICATIONS

_ 1/2" FIRE—RATED PLYWOOD SHEATHING

- PANEL ATTACHMENT BRACKETS

- BACKER ROD & SEALANT ALL SIDES

LIQUID—APPLIED WALL MEMBRANE

OVER 1/2" TH. FIRE—TREATED PLYWOOD
SHEATHING

1" WIDE SEALED TERMINATION BAR

SELF-ADHEREED FLEXIBLE THRU-WALL FLASHING — HOLD 1/2° FROM FROM DAYLIGHT

W/ FASTENERS AT 8" O.C.


- WEEPS AT 24" O.C.

- SEALANT ALL SIDES
- PAINTED HOLLOW METAL DOOR
FRAME FILLED WITH CONC.

- PAINTED STEEL LINTEL

- HOLLOW METAL DOOR

BRICK VENEER

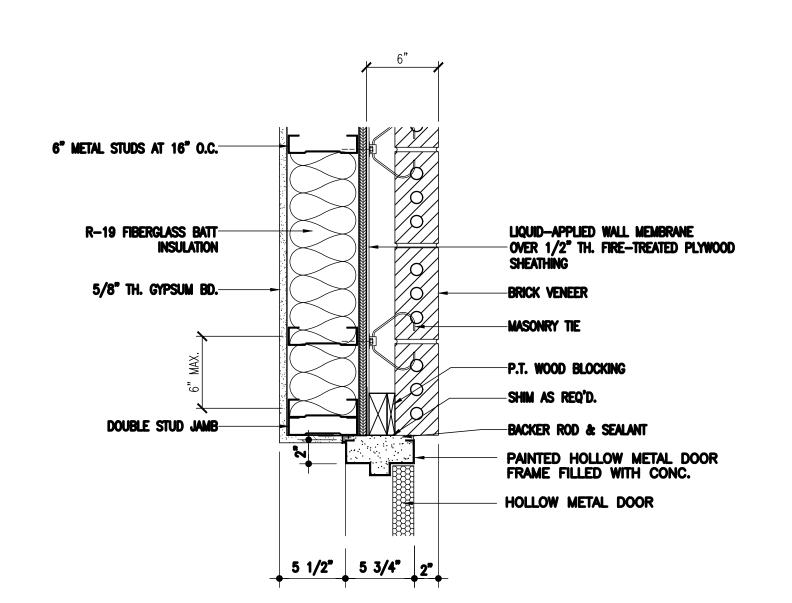



-SIDING - SEE SPECIFICATIONS

_ 1/2" FIRE—RATED PLYWOOD SHEATHING

- PANEL ATTACHMENT BRACKETS



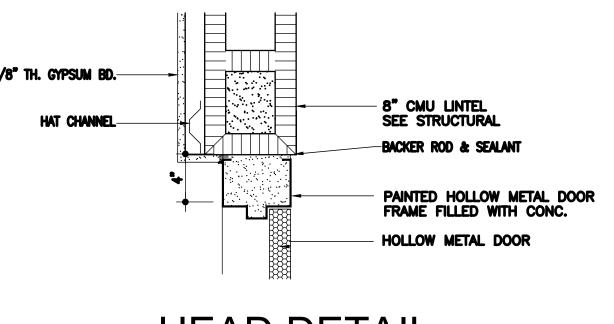

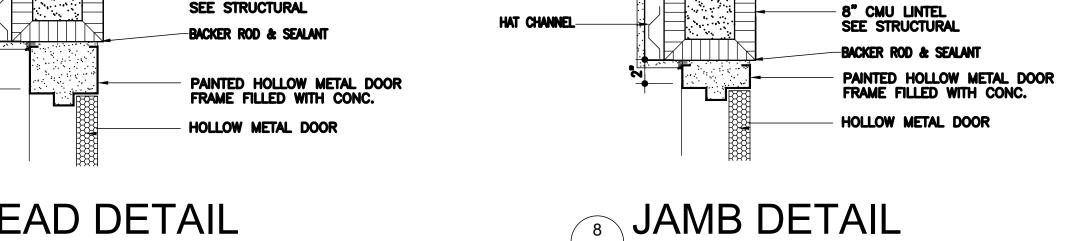

A6.5 SCALE: 1 1/2"=1'-0"

5/8" TH. GYPSUM BD.—

6" METAL STUDS AT 16" O.C.

5/8" TH. GYPSUM BD.—

_SIDING - SEE SPECIFICATIONS


1/2" FIRE—RATED PLYWOOD SHEATHING

PANEL ATTACHMENT BRACKETS

—BACKER ROD & SEALANT —5/8" TH. GYPSUM BD.

JAMB DETAIL

A6.5 SCALE: 1 1/2"=1'-0"

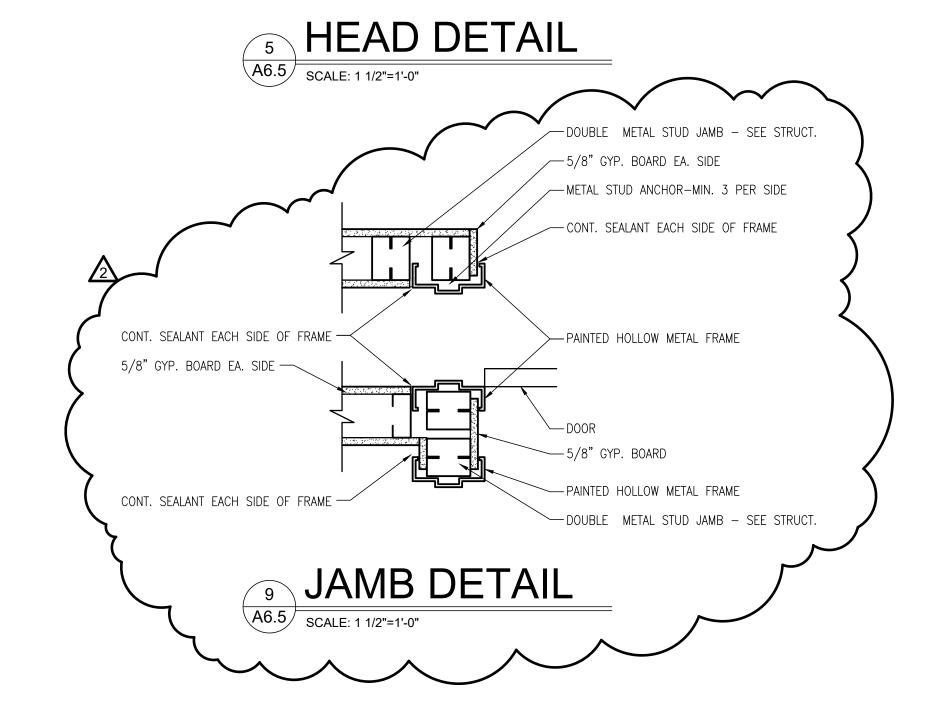

4 1/8" 5 3/4" 2" 3/4" PROJECTION

6" METAL STUDS— AT 16" O.C.

METAL STUD BOX— HEADER

BACKER ROD &-

HEAD DETAIL

A6.5 SCALE: 1 1/2"=1'-0"


6" METAL STUDS— AT 16" O.C.

METAL STUD BOX— HEADER

5/8" TH. GYPSUM BD.-

5/8" TH. GYPSUM BD.—

5/8" TH. GYPSUM BD.—

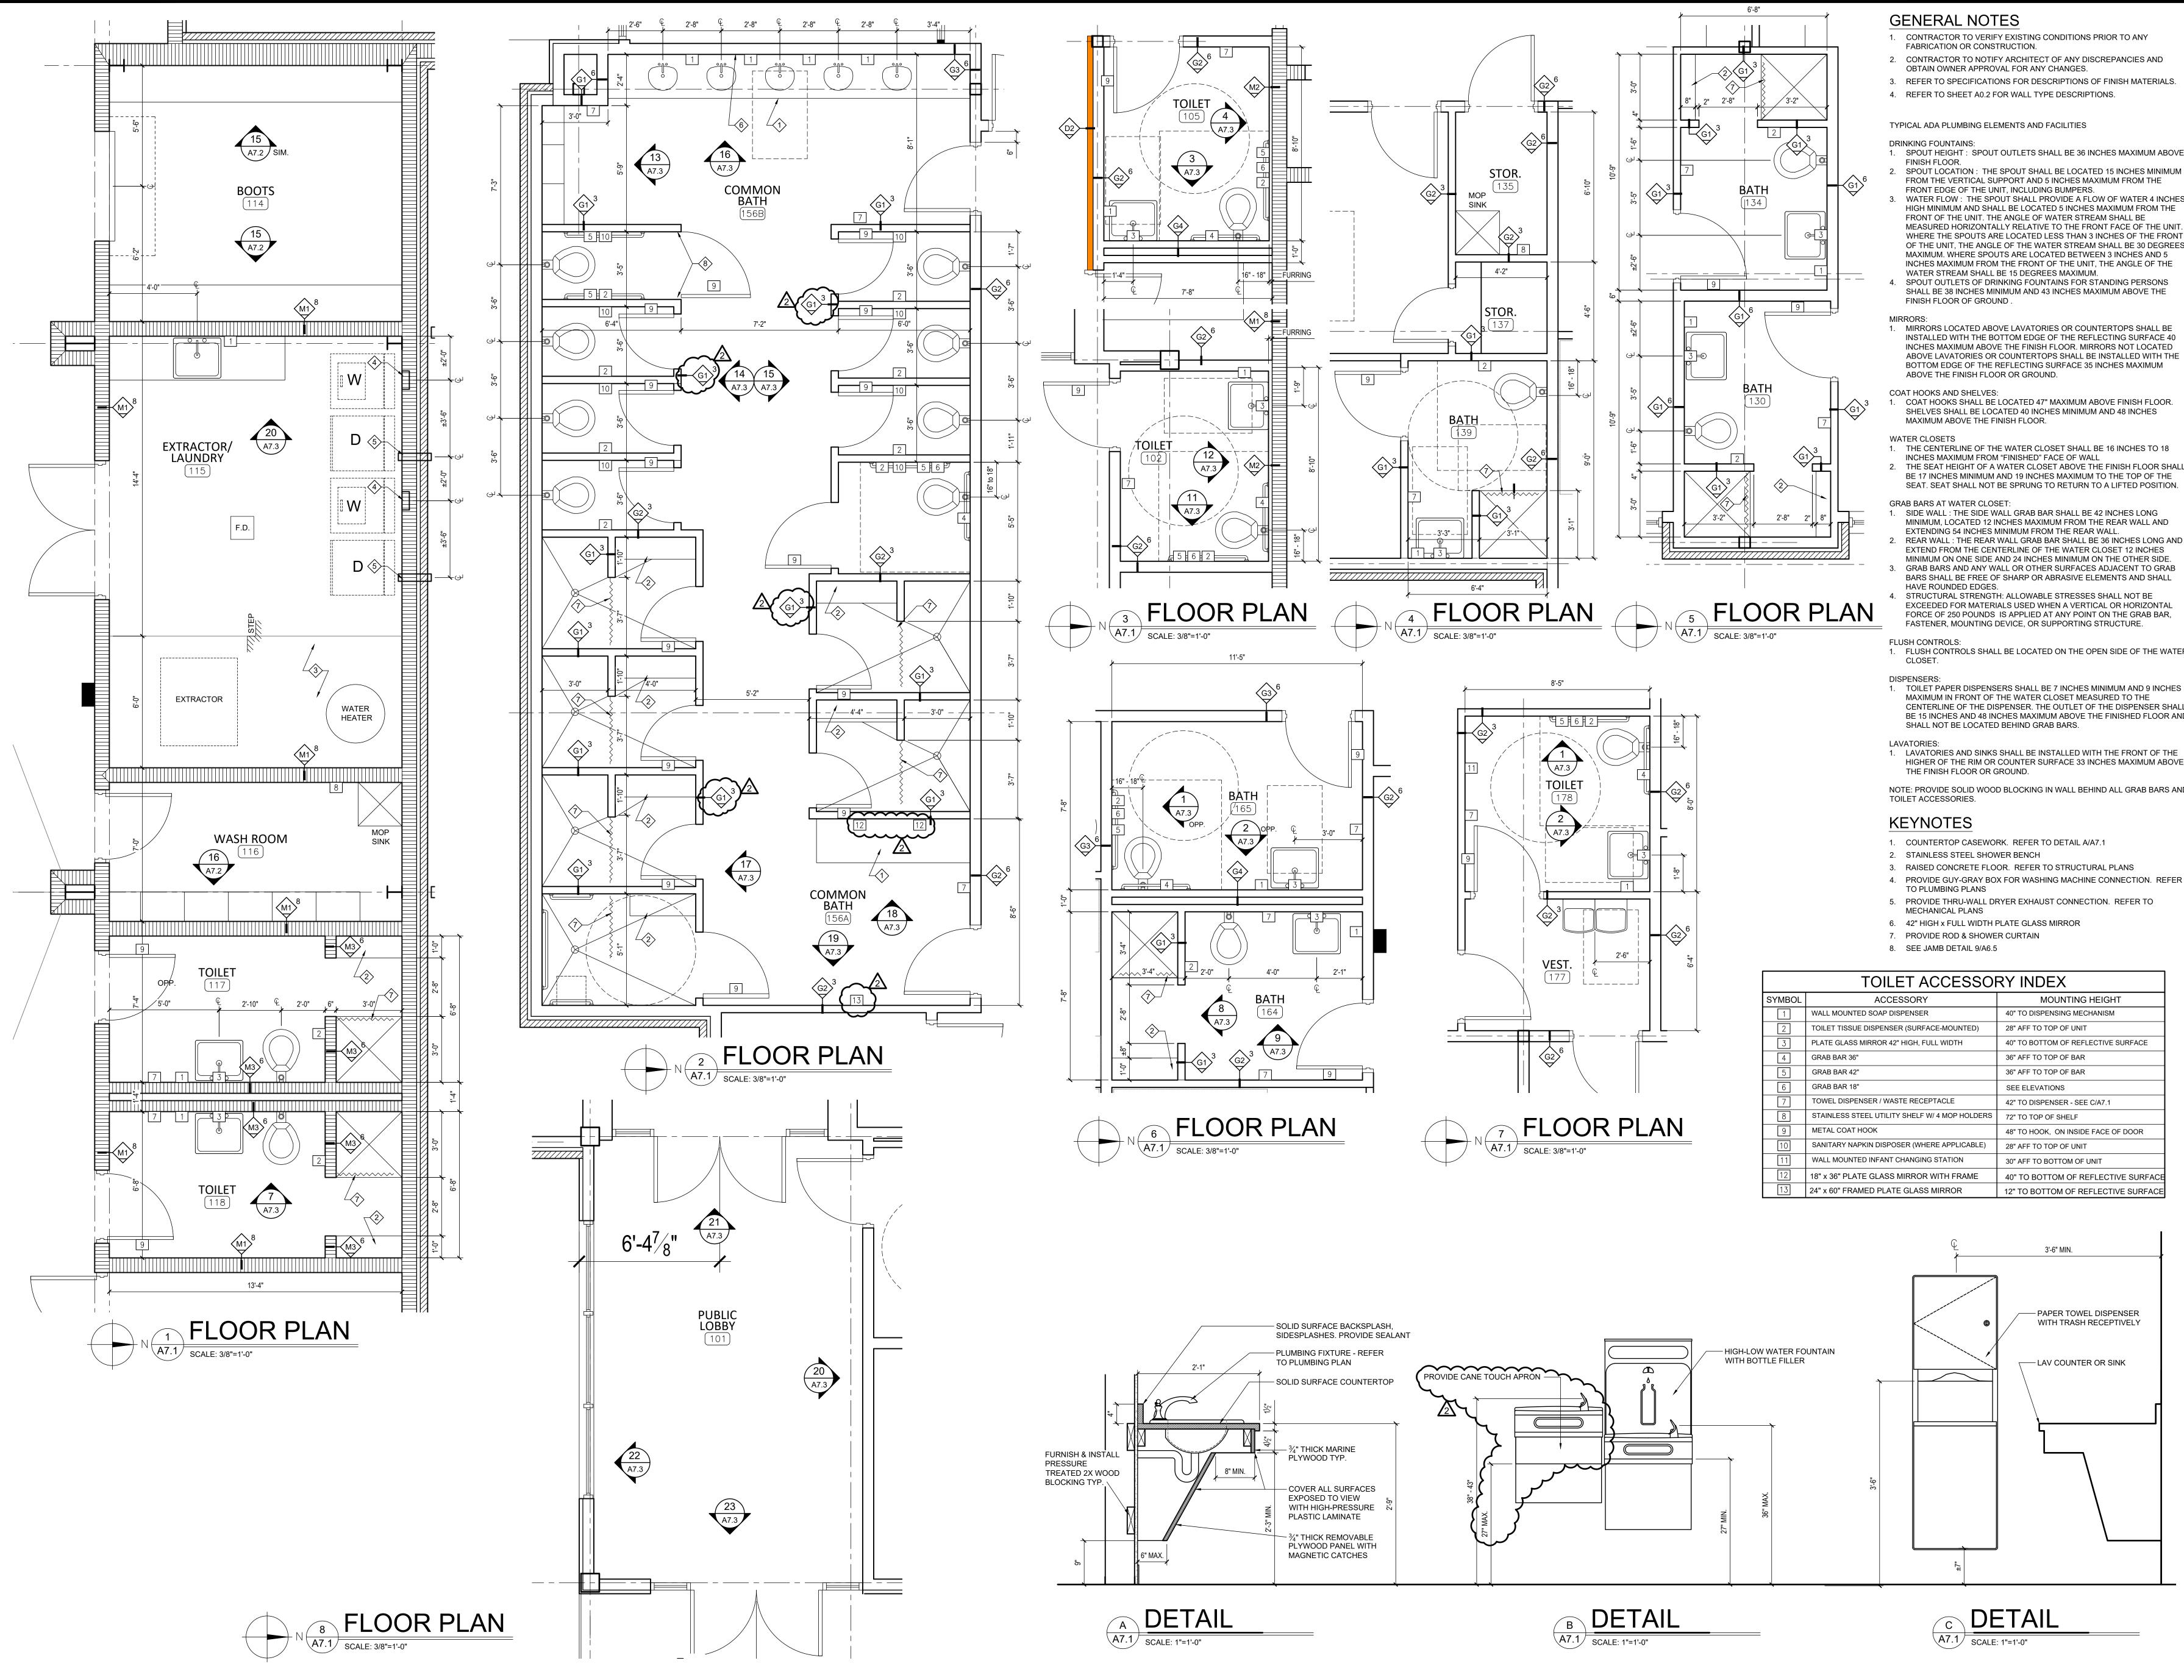

Barganier Davis Williams

Architects Associated




624 South McDonough Street Montgomery, AL 36104 phone: 334.834.2038 www.bdwarchitects.com

RAY E. WILLIAMS

0

- 1. FLUSH CONTROLS SHALL BE LOCATED ON THE OPEN SIDE OF THE WATER
- CENTERLINE OF THE DISPENSER. THE OUTLET OF THE DISPENSER SHALL BE 15 INCHES AND 48 INCHES MAXIMUM ABOVE THE FINISHED FLOOR AND
- HIGHER OF THE RIM OR COUNTER SURFACE 33 INCHES MAXIMUM ABOVE
- NOTE: PROVIDE SOLID WOOD BLOCKING IN WALL BEHIND ALL GRAB BARS AND

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TOILET PLANS

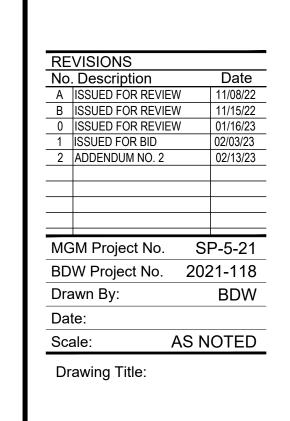Sheet No:

CONSTRUCTION DOCUMENTS

— DOOR AND STOREFRONT ASSEMBLY AS

PUBLIC LOBBY 101

A7.3 SCALE: 1/4"=1'-0"

PUBLIC LOBBY 101

A7.3 SCALE: 1/4"=1'-0"

ACCESSIBLE FOLDING SEAT

24" x 60" FRAMED PLATE GLASS MIRROR

FLUSH VALVE TOILET

UTILITY HOOKS

GENERAL NOTES

NOTED. SEE SPECIFICATIONS.

TOILETS & BATHS: KITCHEN #108:

STAINLESS STEEL UTILITY SHELF W/ 4 MOP HOLDERS

1. ALL CASEWORK TO BE LAMINATE CLAD CASEWORK UNLESS OTHERWISE

QUARTZ

SOLID SURFACE

2. COUNTER TOP MATERIALS TO BE (UNLESS NOTED OTHERWISE):

ALL OTHER SPACES: PLASTIC LAMINATE

12" TO BOTTOM OF REFLECTIVE SURFACE

KEYNOTES

1. PORCELAIN TILE 12" x 24"

2. PAINTED CONCRETE MASONRY UNITS

3. 12" DEEP COATED WIRE SHELVES

Barganier Davis Williams Architects Associated

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Montgomery, AL 36104

phone: 334.834.2038

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RAY E. WILLIAMS
4239

JOHNNY B. RAINES, III
7127

FOR

SITY OF MONTGOMERY, ALABAMA 3610

REVISIONS
No. Description Date
A ISSUED FOR REVIEW 11/15/22
0 ISSUED FOR REVIEW 01/16/23
1 ISSUED FOR BID 02/03/23
2 ADDENDUM NO. 2 02/13/23

MGM Project No. SP-5-21
BDW Project No. 2021-118
Drawn By: BDW
Date:
Scale: AS NOTED

Drawing Title:

INTERIOR ELEVATIONS

Sheet No:

A7.3

CONSTRUCTION DOCUMENTS

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PUBLIC LOBBY 101

SCALE: 1/4"=1'-0"

DOOR AND STOREFRONT ASSEMBLY AS SCHEDULED —

PUBLIC LOBBY 101

A7.3 SCALE: 1/4"=1'-0"