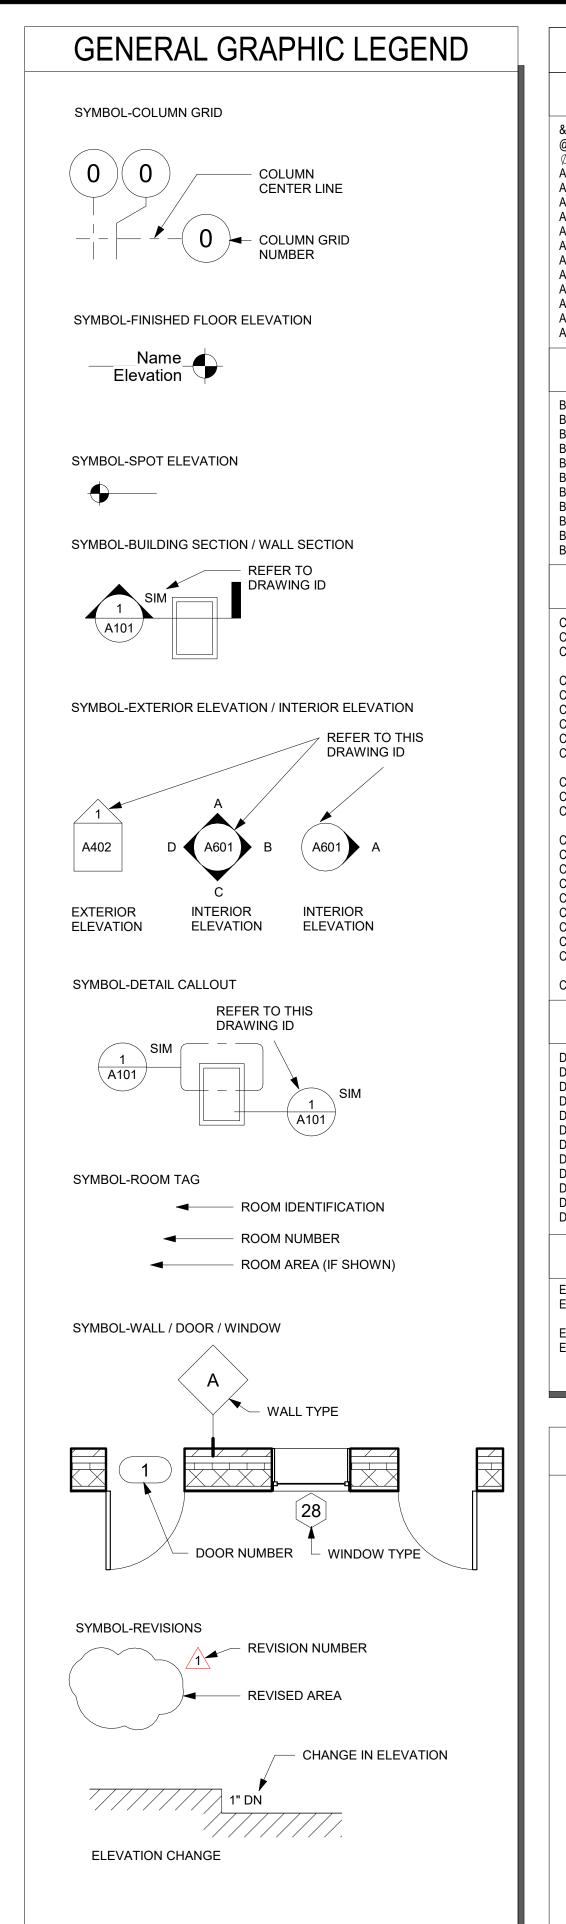
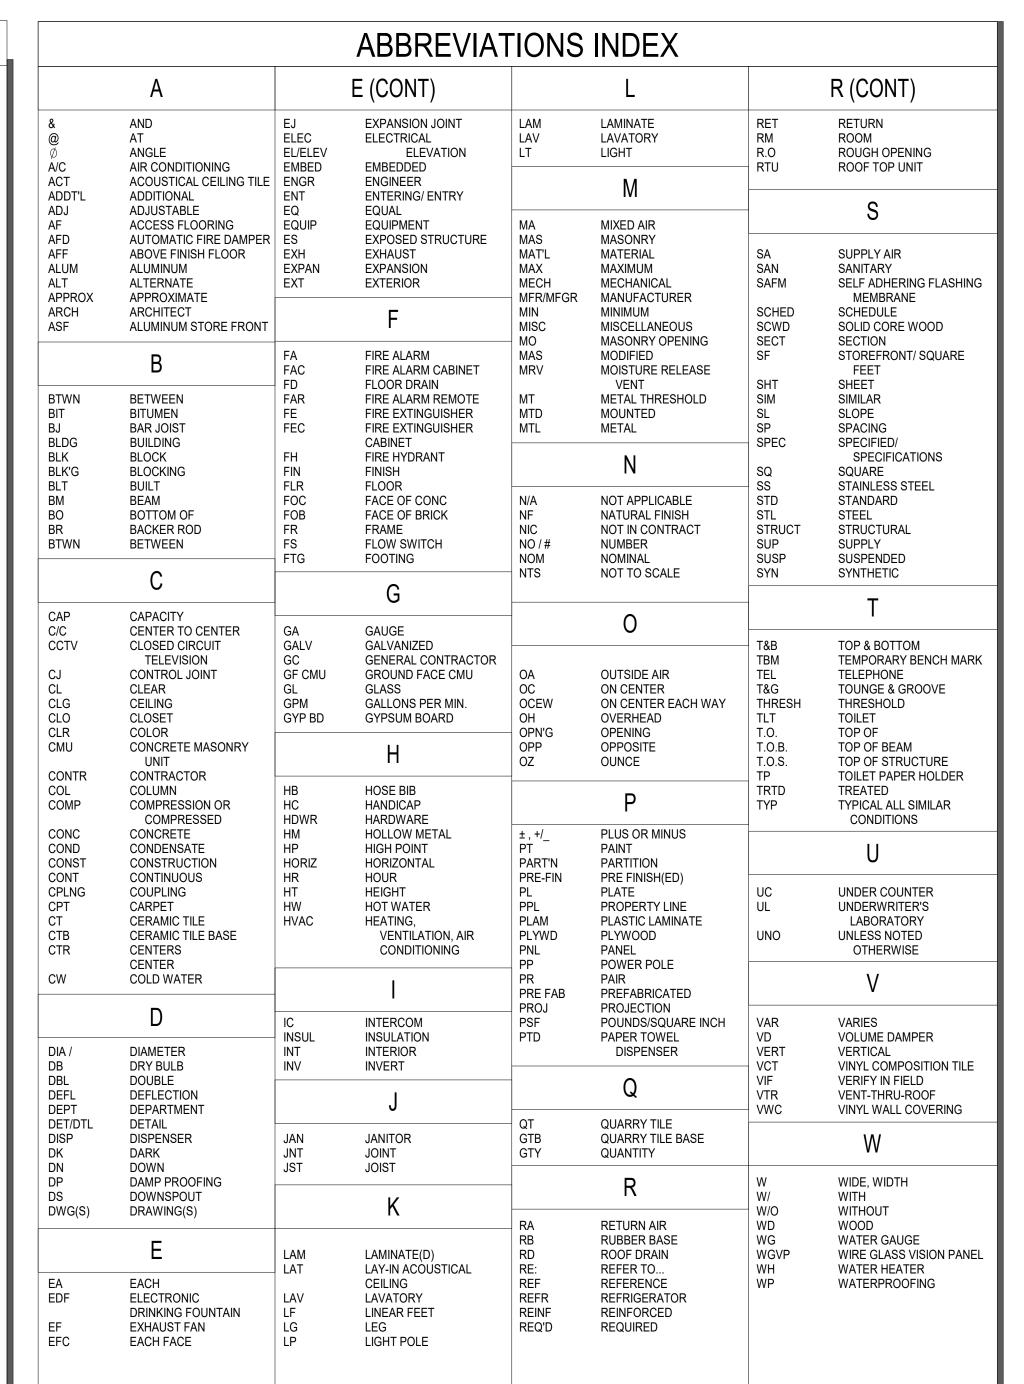
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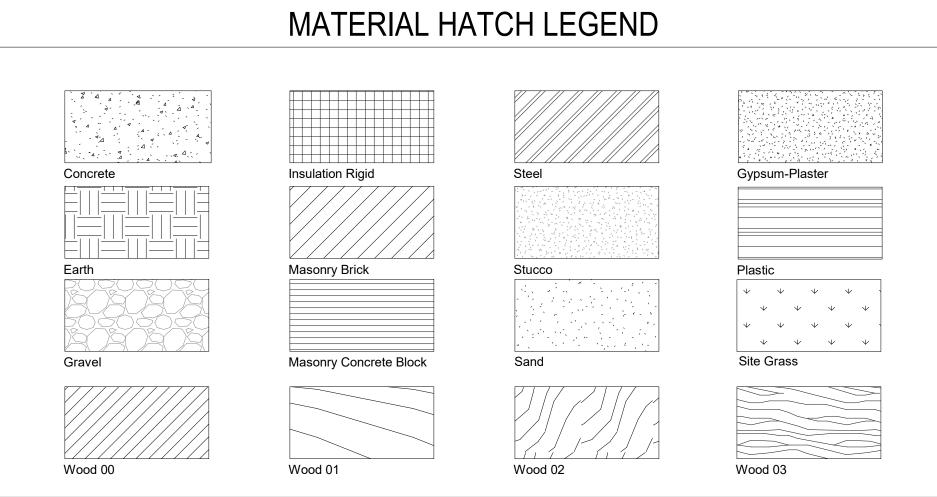
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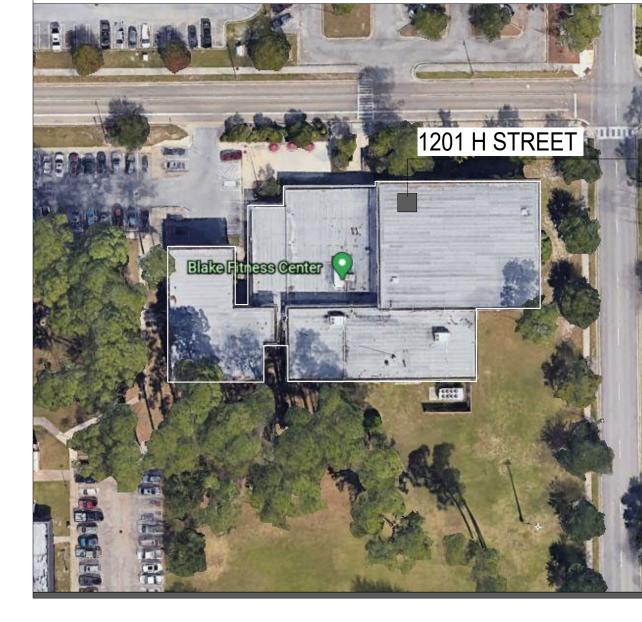








PROJECT MAP



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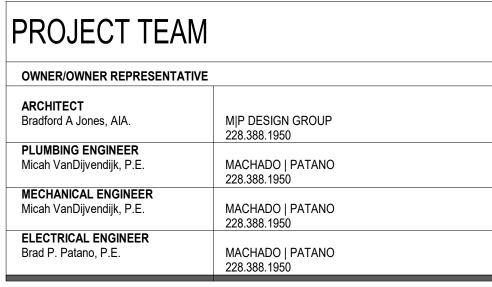
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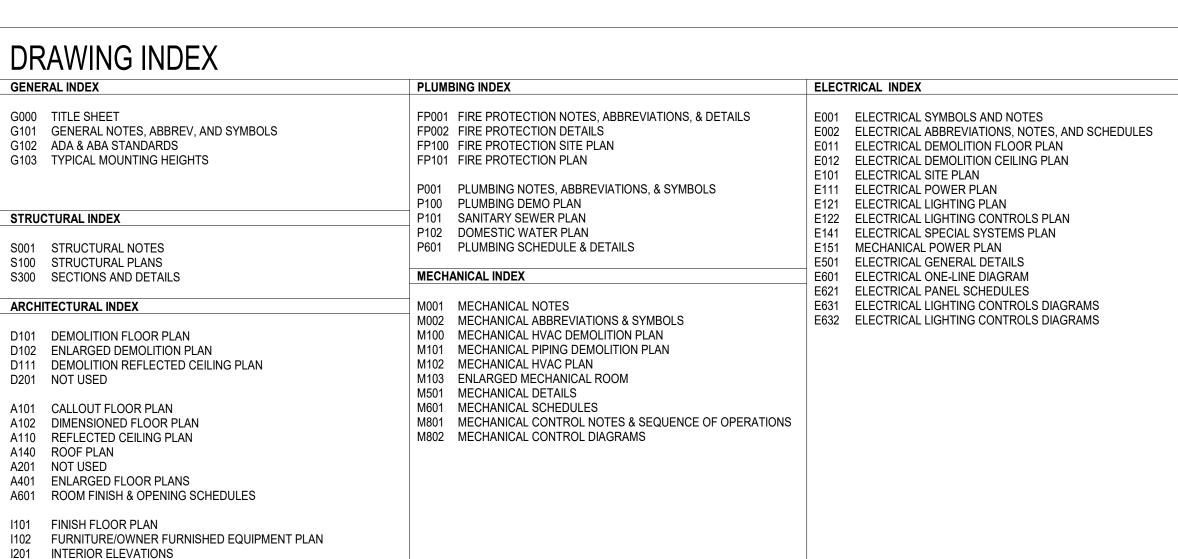
PROJECT GENERAL NOTES

- THE CONSTRUCTION DOCUMENTS ARE COMPRISED OF BOTH DRAWINGS AND SPECIFICATIONS (PROJECT MANUAL). THE GENERAL CONTRACTOR
- SHALL NOT BREAK OUT SECTIONS TO SUB-CONTRACTORS OR VENDORS. DO NOT SCALE DRAWINGS; IF DIMENSIONS ARE IN QUESTION CONTRACTOR
- SHALL BE RESPONSIBLE FOR OBTAINING CLARIFICATION FROM ARCHITECT BEFORE CONTINUING WITH CONSTRUCTION.
- BIDDERS SHALL FIELD VERIFY ALL EXISTING CONDITIONS ON THE PROJECT JOB SITE PRIOR TO BIDDING.
- GENERAL CONTRACTOR IS RESPONSIBLE FOR COORDINATING WORK OF ALL TRADES TO INSURE A USABLE & FUNCTIONAL END PRODUCT. ANY CONFLICTS BETWEEN THE DRAWINGS AND SPECIFICATIONS SHALL BE CLARIFIED BY THE ARCHITECT/ENGINEER. IF NO CLARIFICATION IS ISSUED THE BIDDER SHALL BID THE MOST STRINGENT PRODUCT OR APPLICATION.
- GENERAL CONTRACTOR IS RESPONSIBLE FOR COORDINATING ALL ABOVE CEILING WORK TO INSURE ADEQUATE INSTALL FOR ALL COMPONENTS AND TO PREVENT THE ADJUSTMENT OF ANY CEILING COMPONENTS.
- GENERAL CONTRACTOR IS RESPONSIBLE FOR SECURING AND PROTECTING ALL CONSTRUCTION MATERIALS, EQUIPMENT, TOOLS, AND TEMPORARY FACILITIES ON THE JOB SITE FOR THE DURATION OF THE PROJECT.
- MATERIALS USED ON THIS PROJECT SHALL NOT CONTAIN ASBESTOS. GENERAL CONTRACTOR SHALL PLACE AND MAINTAIN THROUGHOUT DURATION OF PROJECT SPECIFIED GROUND MATERIAL OVER SOILS ADJACENT TO BUILDING PRIOR TO INSTALLING EXTERIOR WALL FINISH MATERIALS TO PREVENT STAINING ON FINISHED PRODUCT. ALL STAINS ON EXTERIOR WALL MATERIALS SHALL BE CLEANED AND FULLY REMOVED BEFORE SUBSTANTIAL COMPLETION OF PROJECT AT NO ADDITIONAL COST TO THE OWNER. IF STAINS CAN NOT BE REMOVED FROM THE FINISH MATERIALS, THE MATERIAL MUST BE REPLACED AT NO ADDITIONAL COST TO

THE OWNER.

- GENERAL CONTRACTOR SHALL SUBMIT SHOP DRAWINGS AND SUBMITTALS FOR REVIEW AND APPROVAL BEFORE PROCEEDING WITH CONSTRUCTION. CONTRACTOR IS PROCEEDING AT HIS OWN RISK IF MATERIAL OR COMPONENTS ARE INSTALLED PRIOR TO RECEIVING REVIEWED AND EXECUTED SHOP DRAWINGS AND SUBMITTALS. CONTRACTOR SHALL TAKE LIABILITY FOR REMOVAL AND REPLACEMENT, AT NO ADDITIONAL COST TO THE OWNER, OF ALL MATERIAL, COMPONENTS AND LABOR FOR WORK INSTALLED WITHOUT SIGNED/STAMPED/APPROVED SHOP DRAWINGS AND
- ALL DOOR, FRAME, AND OPENING DIMENSIONS SHALL BE FIELD VERIFIED BEFORE FABRICATION.
- ELEVATION TYPICAL.
- 12. ALL BID AMOUNTS MUST BE BASED ON THE MOST STRINGENT REQUIREMENT AND TAKE PRECEDENCE IN THE EVENT OF ANY AND ALL CONFLICTS SCHEDULES, ETC...), BETWEEN DIFFERENT SPECIFICATION SECTIONS, FOR FURTHER CLARITY PRIOR TO SUBMITTING A FORMAL BID.





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NP DESIGN|GROUP

ARCHITECTURI Bradford A. Jones, Architect



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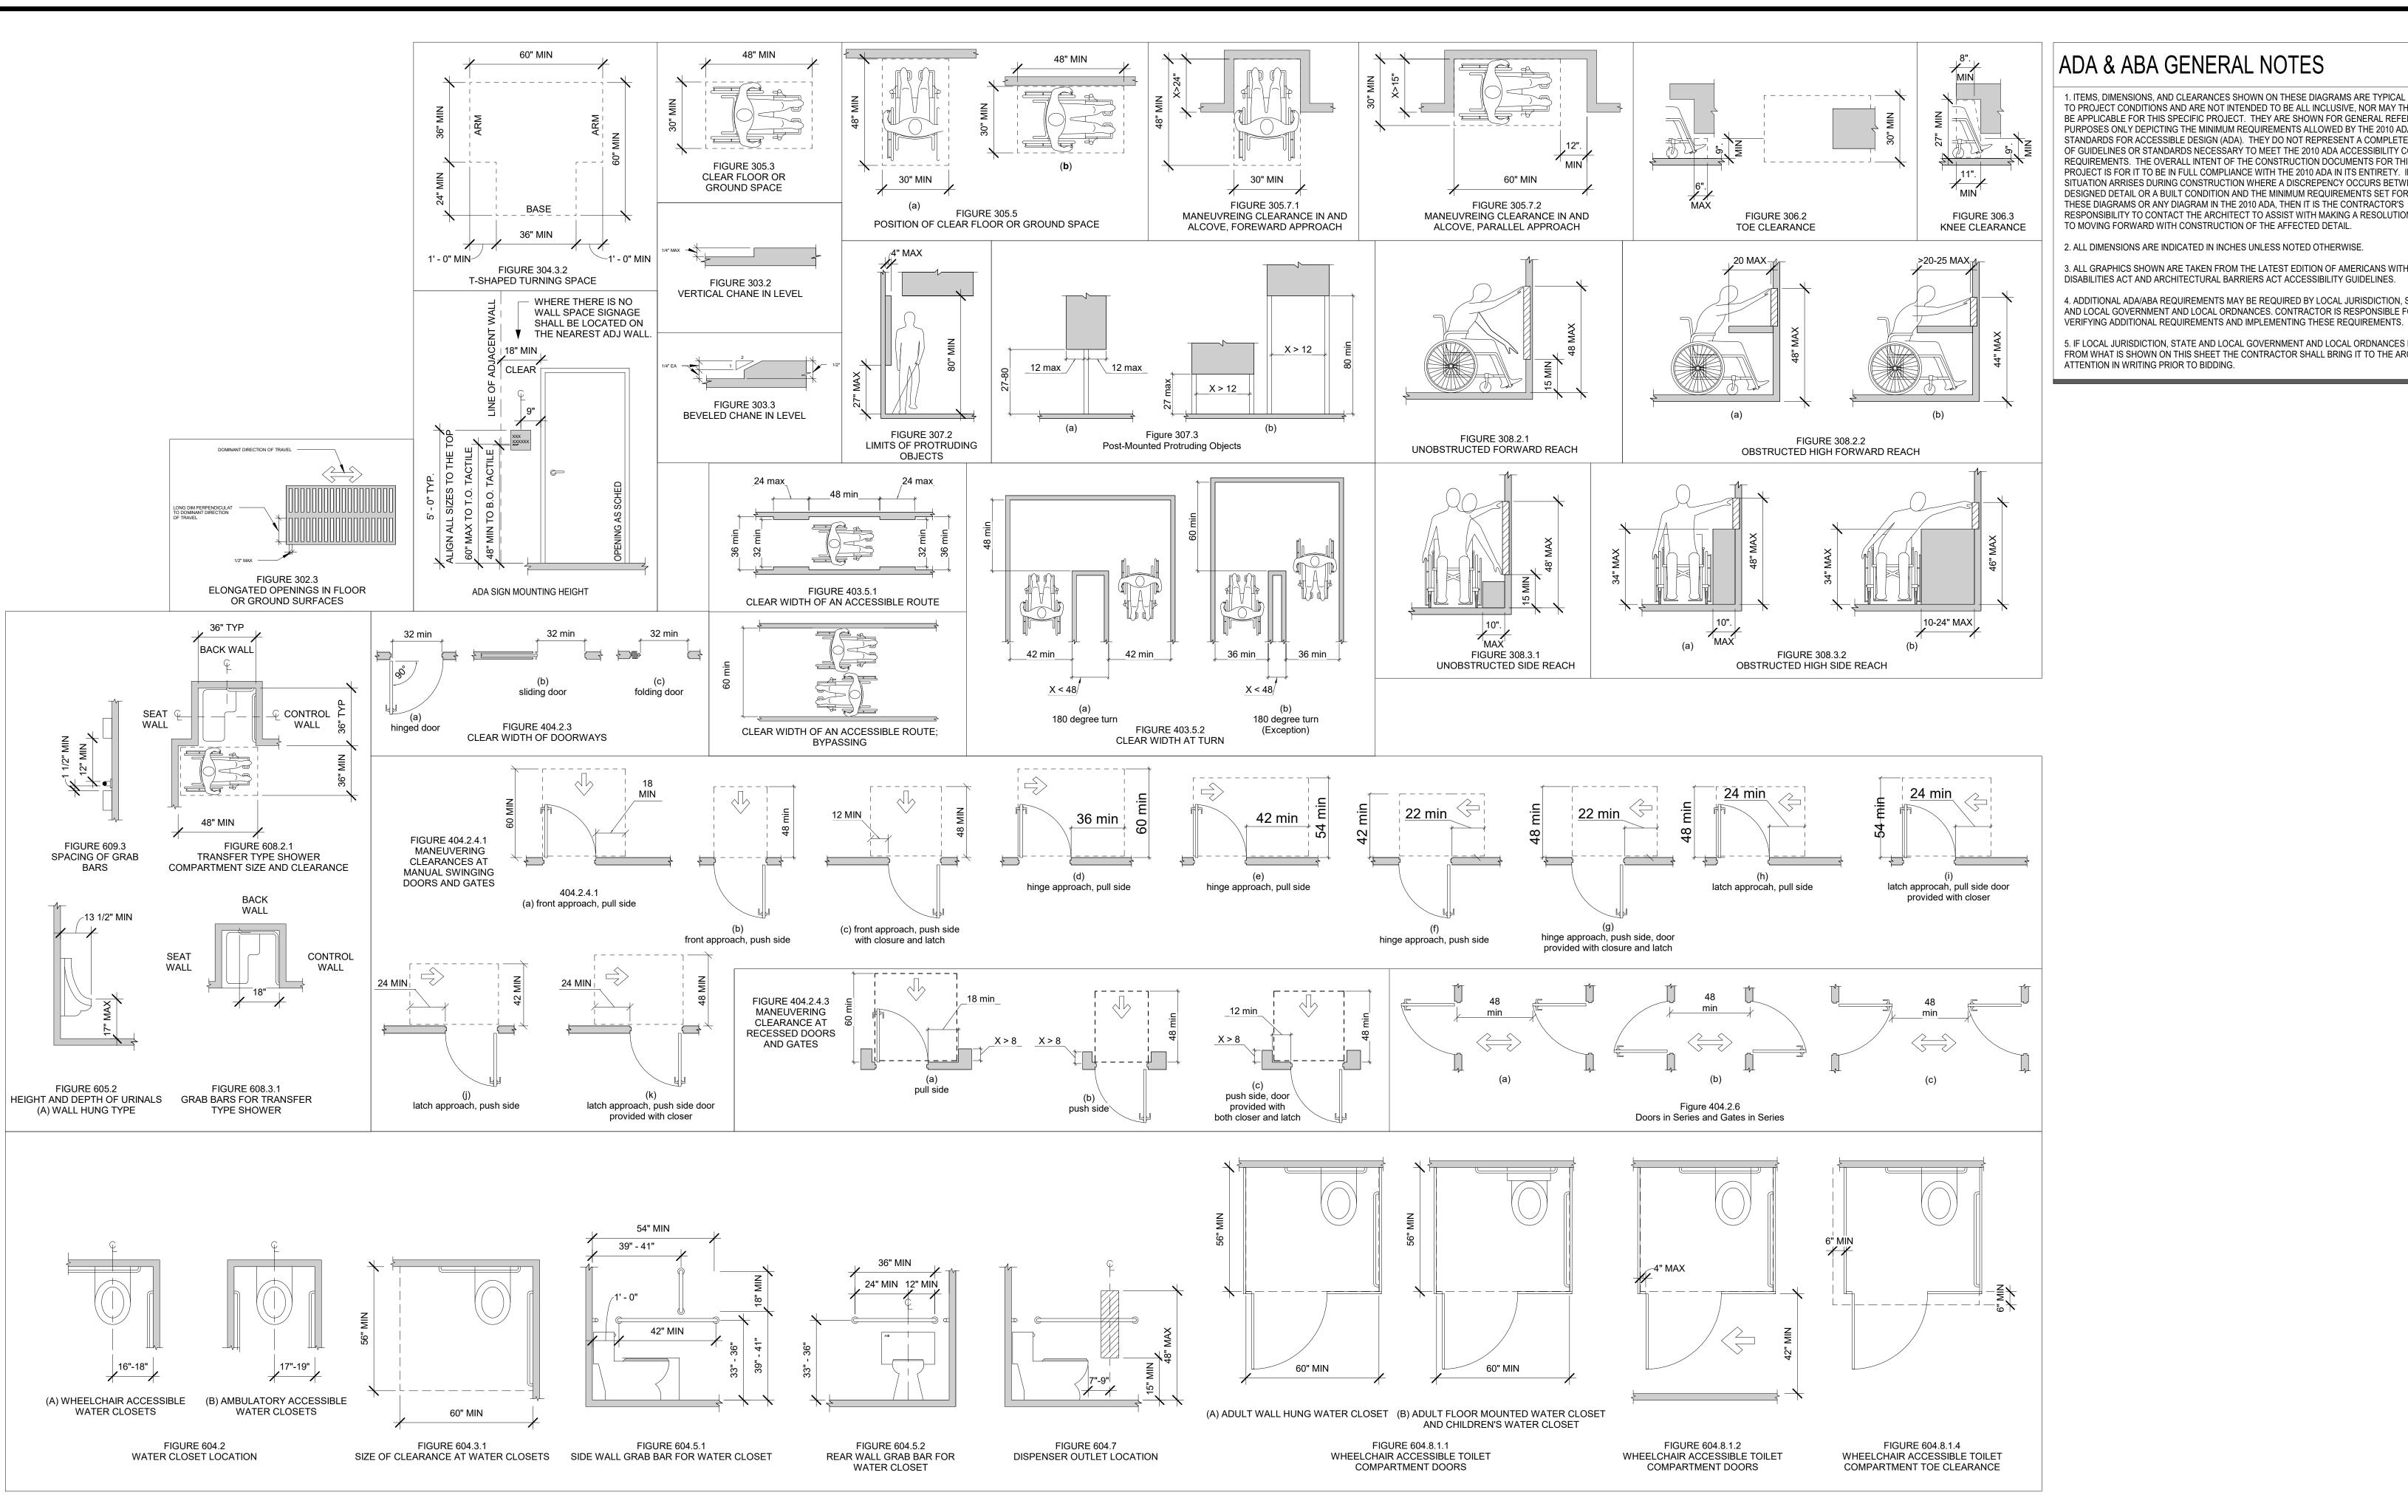
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PROJECT NO: 0110.20.002

CONTRACTOR TO COORDINATE & VERIFY ANY/ALL WEEP HOLES IN MASONRY ARE LOCATED ABOVE FINISH GRADE ELEVATION AND BELOW FINISH FLOOR

CALLED FOR IN THE COMPLETE CONSTRUCTION DOCUMENT PACKAGE. IN ADDITION, THE MOST STRINGENT REQUIREMENT SHOWN SHALL GOVERN BETWEEN DIFFERENT DRAWINGS (PLANS, ELEVATIONS, DETAILS, SECTIONS, WITHIN SPECIFICATION SECTIONS, AND BETWEEN THE DRAWINGS AND THE SPECIFICATIONS. IT WILL BE THE GENERAL CONTRACTORS RESPONSIBILITY TO BRING ANY AND ALL DISCREPANCIES TO THE ARCHITECT'S ATTENTION

	Brad P. Patano, P.		MACHADO PATANO 228.388.1950
		ELEC	TRICAL INDEX
	s, & DETAILS BOLS	E002 E011 E012 E101 E111 E121 E122 E141 E151	ELECTRICAL SYMBOLS AND NOTES ELECTRICAL ABBREVIATIONS, NOTES, AND SCHEDULES ELECTRICAL DEMOLITION FLOOR PLAN ELECTRICAL DEMOLITION CEILING PLAN ELECTRICAL SITE PLAN ELECTRICAL POWER PLAN ELECTRICAL LIGHTING PLAN ELECTRICAL LIGHTING CONTROLS PLAN ELECTRICAL SPECIAL SYSTEMS PLAN MECHANICAL POWER PLAN ELECTRICAL GENERAL DETAILS
			ELECTRICAL ONE-LINE DIAGRAM
LS		E631	ELECTRICAL PANEL SCHEDULES ELECTRICAL LIGHTING CONTROLS DIAGRAMS ELECTRICAL LIGHTING CONTROLS DIAGRAMS



ADA & ABA GENERAL NOTES

1. ITEMS, DIMENSIONS, AND CLEARANCES SHOWN ON THESE DIAGRAMS ARE TYPICAL PROJECT TO PROJECT CONDITIONS AND ARE NOT INTENDED TO BE ALL INCLUSIVE, NOR MAY THEY ALL BE APPLICABLE FOR THIS SPECIFIC PROJECT. THEY ARE SHOWN FOR GENERAL REFERENCE PURPOSES ONLY DEPICTING THE MINIMUM REQUIREMENTS ALLOWED BY THE 2010 ADA STANDARDS FOR ACCESSIBLE DESIGN (ADA). THEY DO NOT REPRESENT A COMPLETE LISTING OF GUIDELINES OR STANDARDS NECESSARY TO MEET THE 2010 ADA ACCESSIBILITY CODE REQUIREMENTS. THE OVERALL INTENT OF THE CONSTRUCTION DOCUMENTS FOR THIS PROJECT IS FOR IT TO BE IN FULL COMPLIANCE WITH THE 2010 ADA IN ITS ENTIRETY. IF A SITUATION ARRISES DURING CONSTRUCTION WHERE A DISCREPENCY OCCURS BETWEEN A DESIGNED DETAIL OR A BUILT CONDITION AND THE MINIMUM REQUIREMENTS SET FORTH BY THESE DIAGRAMS OR ANY DIAGRAM IN THE 2010 ADA, THEN IT IS THE CONTRACTOR'S RESPONSIBILITY TO CONTACT THE ARCHITECT TO ASSIST WITH MAKING A RESOLUTION PRIOR TO MOVING FORWARD WITH CONSTRUCTION OF THE AFFECTED DETAIL.

2. ALL DIMENSIONS ARE INDICATED IN INCHES UNLESS NOTED OTHERWISE. 3. ALL GRAPHICS SHOWN ARE TAKEN FROM THE LATEST EDITION OF AMERICANS WITH

DISABILITIES ACT AND ARCHITECTURAL BARRIERS ACT ACCESSIBILITY GUIDELINES. 4. ADDITIONAL ADA/ABA REQUIREMENTS MAY BE REQUIRED BY LOCAL JURISDICTION, STATE AND LOCAL GOVERNMENT AND LOCAL ORDNANCES. CONTRACTOR IS RESPONSIBLE FOR

5. IF LOCAL JURISDICTION, STATE AND LOCAL GOVERNMENT AND LOCAL ORDNANCES DIFFER FROM WHAT IS SHOWN ON THIS SHEET THE CONTRACTOR SHALL BRING IT TO THE ARCHITECTS

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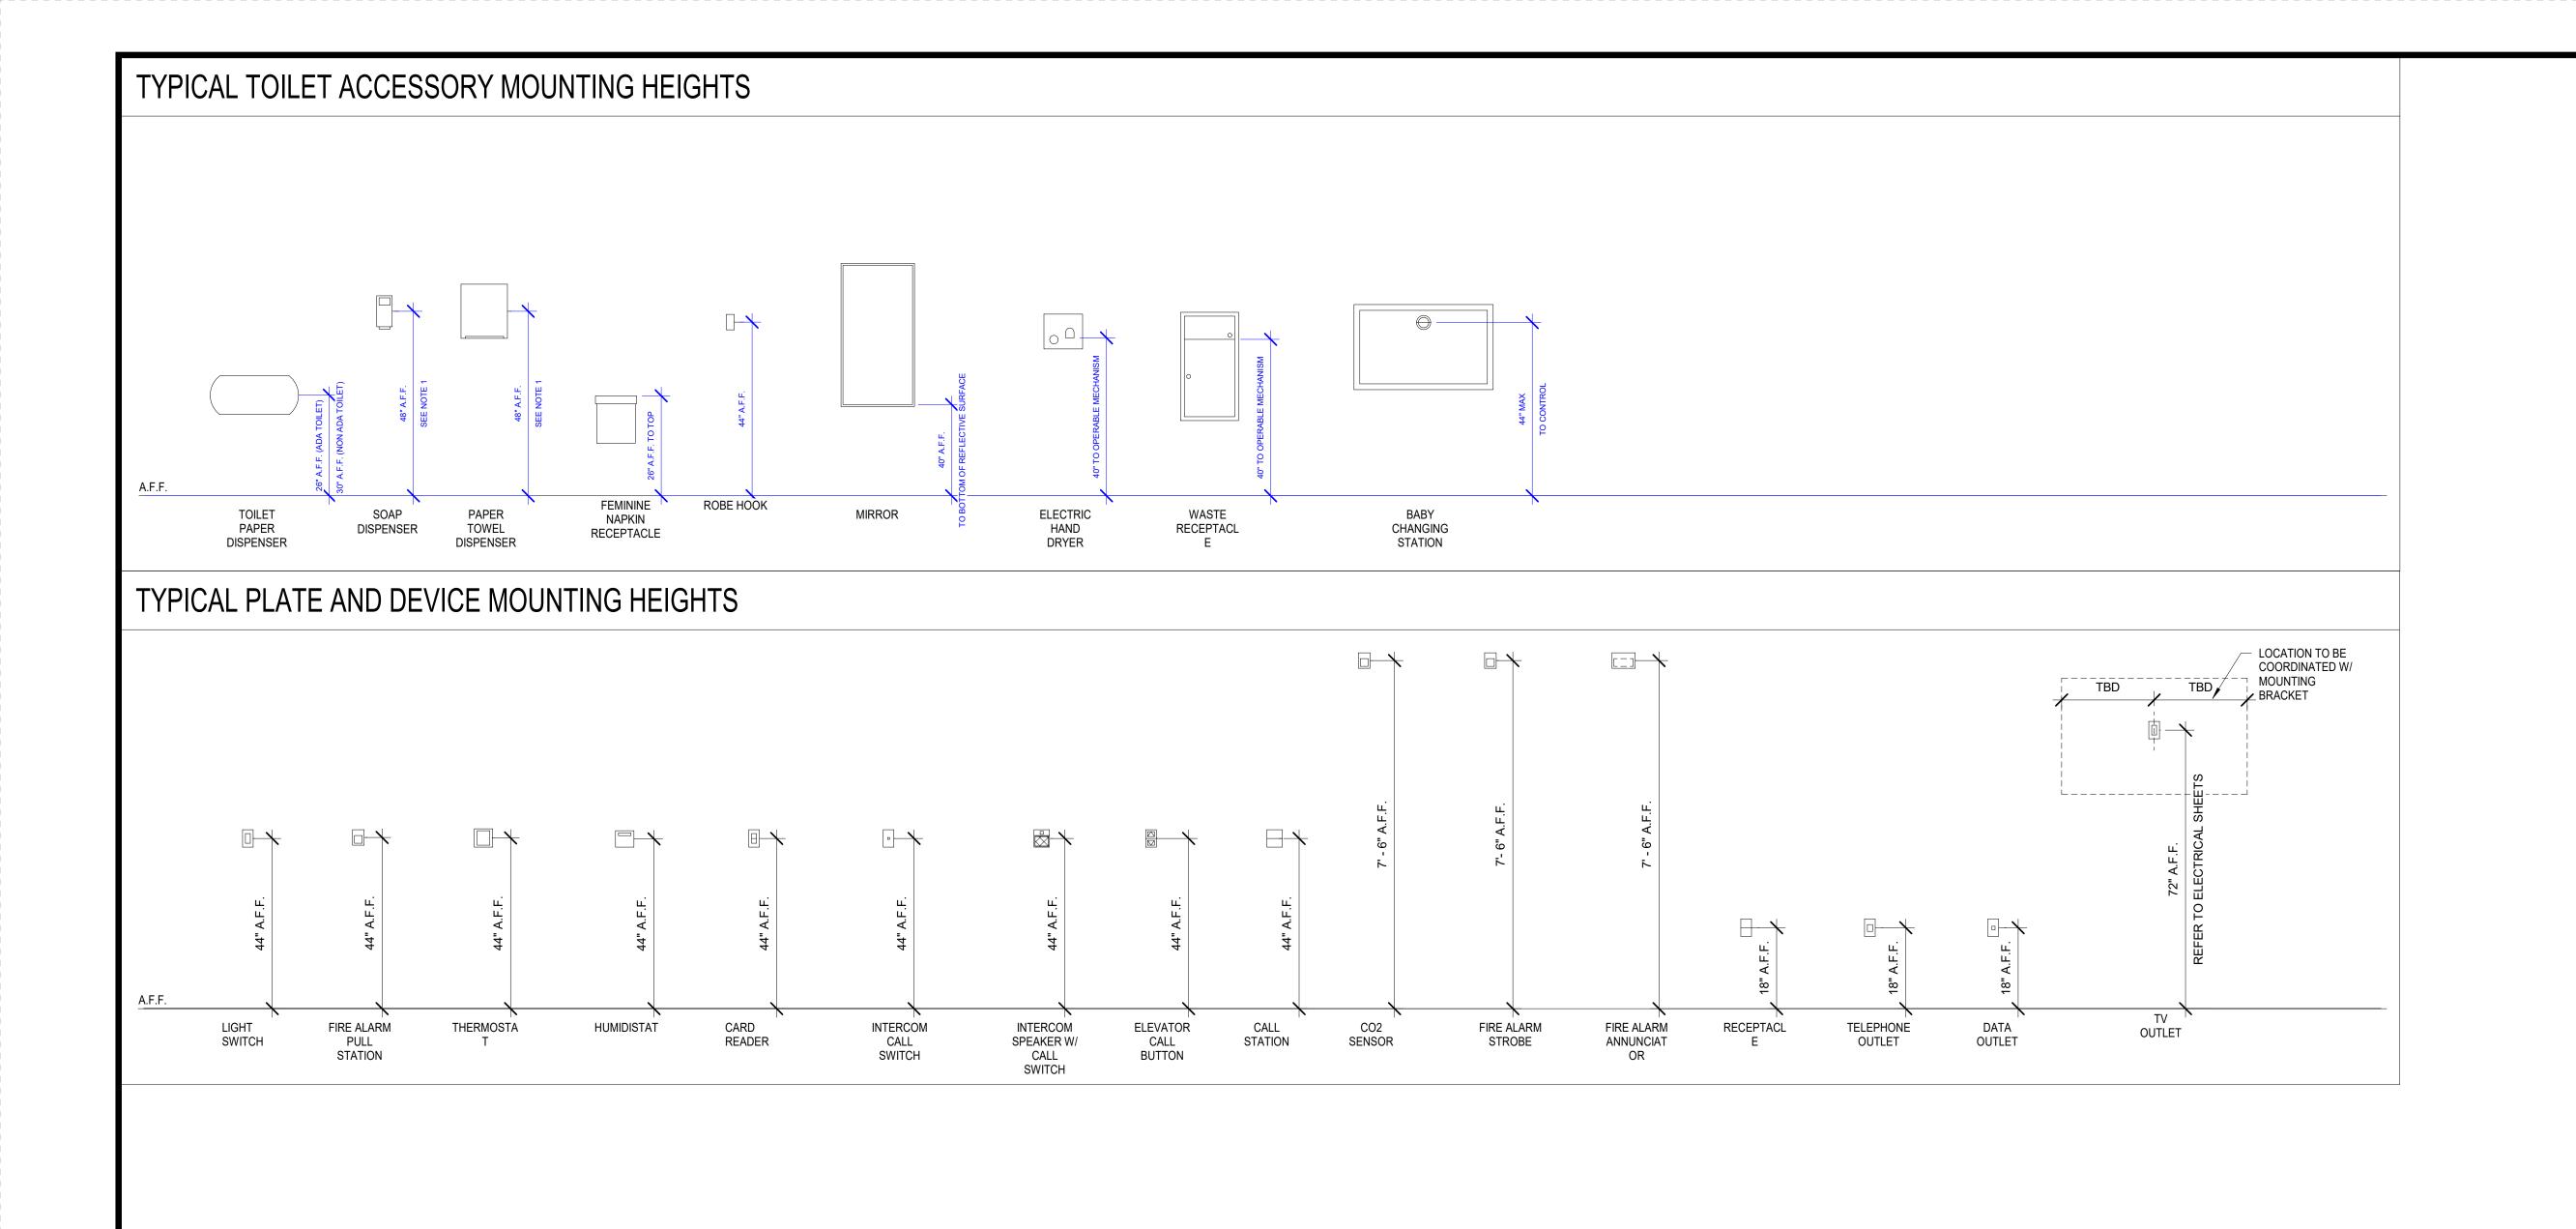
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ARCHITECTURI Bradford A. Jones, Architect



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PROJECT NO: 0110.20.002 DRAWN BY:MLW CHECKED BY: FAS



TYP. MOUNTING HEIGHT GENERAL NOTES

1. ANY DEVICE WITH OPERABLE COMPONENTS TO BE 48" MAX TO TOP OF OPERABLE COMPONENT. GC TO NOTIFY ARCHITECT PRIOR TO INSTALLATION OF ANY DEVIATIONS FROM THIS ADA MAXIMUM OPERABLE REACH HEIGHT.

2. ANY DEVICE WITH OPERABLE COMPONENTS TO BE 15" MIN TO BOTTOM OF OPERABLE COMPONENT. GC TO NOTIFY ARCHITECT PRIOR TO INSTALLATION OF ANY DEVIATIONS FROM THIS ADA MINIMUM OPERABLE REACH HEIGHT.

3. ALL TYPICAL MOUNTING HEIGHT DIMENSIONS SHOWN HEREIN ARE TO CENTERLINE OF DEVICE OR FIXTURE U.N.O.



MACHADO I PATANO ENGINEERING

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M P DESIGN GROUP

ARCHITECTURE
Bradford A. Jones, Architect



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SCALE: As indicated
PROJECT NO: 0110.20.002
DRAWN BY:MLW
CHECKED BY: FAS

. MOUNTING HEIGHTS

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GENERAL CONDITIONS

- MASONRY WALLS AND STRUCTURAL STEEL ARE NON-SELF-SUPPORTING AND ARE DESIGNED FOR A COMPLETED CONDITION ONLY. A COMPLETED STRUCTURE IS REQUIRED TO PROVIDE LATERAL STABILITY AND RESISTANCE TO WIND AND SEISMIC FORCES. CONTRACTOR SHALL PROVIDE ALL TEMPORARY BRACING REQUIRED TO MAINTAIN STABILITY OF STRUCTURAL SYSTEM.
- 2. IN CASE OF CONFLICT BETWEEN THE GENERAL NOTES, THE SPECIFICATIONS, OR INFORMATION IN DRAWINGS, THE MORE RIGID REQUIREMENT SHALL GOVERN UNLESS AMENDED IN WRITING BY THE STRUCTURAL ENGINEER OF RECORD.

SUBMITTALS

- REVIEW OF SHOP DRAWINGS AND OTHER SUBMITTALS BY THE STRUCTURAL ENGINEER DOES NOT RELIEVE THE CONTRACTOR OF THE RESPONSIBILITY TO REVIEW AND CHECK SHOP DRAWINGS BEFORE SUBMITTING TO THE STRUCTURAL ENGINEER. THE CONTRACTOR REMAINS SOLELY RESPONSIBLE FOR ERRORS AND OMISSIONS ASSOCIATED WITH THE PREPARATION OF SHOP DRAWINGS AS THEY PERTAIN TO MEMBER SIZES, DETAILS, AND DIMENSIONS SPECIFIED IN THE CONTRACT DOCUMENTS. ALL SHOP DRAWINGS MUST BE STAMPED BY THE CONTRACTOR PRIOR TO SUBMITTAL.
- 2. SUBMIT ALL SHOPS DRAWINGS & OTHER SUBMITTALS IN PDF FORMAT OR HARD COPY. IF HARD COPY IS SUBMITTED, PROVIDE 3 SETS ONLY. ALL OTHERS WILL BE RETURNED UNMARKED. MACHADO PATANO WILL RETURN 1 MARKED SET TO THE CONTRACTOR.
- 3. SHOP DRAWINGS: THE CONTRACTOR SHALL SUBMIT FOR STRUCTURAL ENGINEER REVIEW SHOP DRAWINGS FOR THE FOLLOWING ITEMS. ITEMS MARKED (*) SHALL HAVE SHOP DRAWINGS SEALED BY A PROFESSIONAL ENGINEER REGISTERED IN THE STATE IN WHICH THE PROJECT IS LOCATED.
 - a. STRUCTURAL STEEL b. MASONRY REINFORCING STEEL c. MASONRY GROUT MIX DESIGN

REINFORCING STEEL

- 1. MINIMUM COVER (OR CONCRETE PROTECTION) OF ALL CONCRETE REINFORCEMENT MEASURED FROM THE FINISHED CONCRETE FACE TO THE SOIL SHALL BE THREE (3) INCHES FOR FOOTINGS AND GRADE BEAMS (BOTTOM AND SIDE) AND THREE (3) INCHES BOTTOM AND SIDE FOR SLAB ON GRADE.
- 2. ALL DETAILING, FABRICATION, AND ERECTION OF REINFORCING STEEL SHALL CONFORM TO THE A.C.I. MANUAL OF PRACTICE FOR DETAILING REINFORCED CONCRETE STRUCTURES, A.C.I. 315.
- 3. REINFORCING STEEL SHALL BE PLACED IAW CRSI "PLACING REINFORCING BARS", LATEST EDITION. REINFORCING BARS SHALL BE ASTM A615 GRADE 60.
- 4. DEFORMED WELDED WIRE FABRIC (WWF) SHALL CONFORM WITH A185.
- 5. THE LAP SPLICE DEVELOPMENT LENGTH OF STEEL REINFORCEMENT SHALL BE ACHIEVED AND MADE TO DEVELOP FULL STRENGTH OF THE REINFORCEMENT STEEL. WHERE SPLICES IN REINFORCING ARE NECESSARY, REINFORCING SHALL BE LAPPED 48 BAR DIAMETERS IN INCHES (MINIMUM). ALL BAR SPLICES SHALL BE CLASS "B" TENSION LAP SPLICES, UNLESS NOTED OTHERWISE. SPLICES SHALL CONFORM TO A.C.I. 318, LATEST REVISION.
- 6. REINFORCEMENT STEEL SHALL BE STORED IN SUCH MANNER TO PREVENT EXPOSURE TO THE ELEMENTS AND SHALL BE FREE OF RUST BEFORE PLACEMENT. REINFORCEMENT STEEL SHALL NOT BE WELDED.
- 7. ALL FOOTING REINFORCEMENT SHALL BE HELD SECURELY FROM THE GROUND USING REBAR CHAIRS OR OTHER APPROVED METHODS. CONCRETE BLOCK OR BROKEN TILE MAY BE USED.
- 8. ALL TIE REINFORCEMENT SHALL BE NO. 3 UNLESS NOTED OTHERWISE.
- 9. OUTER BAR OF FOUNDATION REINFORCEMENTS SHALL BE CONTINUOUS AROUND CORNERS OR BY BENDING THE BAR, MINIMUM BAR LAP SHALL BE 25 INCHES.
- 10. PROVIDE ONE (1) #4 HOOP WITH 8' LAP IN SLAB AROUND ALL FLOOR DRAINS.

CONCRETE MASONRY

- 1. MASONRY CONSTRUCTION SHALL COMPLY WITH ACI 530; BUILDING CODE REQUIREMENTS & SPECIFICATIONS FOR MASONRY STRUCTURES.
- 2. ALL CONCRETE MASONRY UNITS SHALL CONFORM TO ASTM C-90, TYPE II, AND HAVE A MINIMUM ULTIMATE COMPRESSIVE PRISM STRENGTH (F'm) OF 1,900 PSI FOR THE MASONRY ASSEMBLAGE.
- 3. ALL MORTAR SHALL BY TYPE S CONFORMING TO ASTM C270 WITH A MINIMUM 28 DAY COMPRESSIVE STRENGTH OF 2,000 PSI.
- 4. CMU WALLS SHALL BE GROUTED IN 4'-0" LIFTS, MAXIMUM.
- 5. ALL CMU BOND BEAMS, LINTELS, AND CELLS WHICH CONTAIN REINFORCING STEEL SHALL BE FILLED SOLID WITH 3000 PSI CONCRETE GROUT (UNLESS NOTED OTHERWISE).
- 6. VERTICAL CELLS TO BE FILLED SHALL HAVE A VERTICAL ALIGNMENT SUFFICIENT TO MAINTAIN A CLEAR UNOBSTRUCTED CONTINUOUS VERTICAL CELL NOT LESS THAN 2" X 3" IN PLAN DIMENSIONS.
- 7. A CONTINUOUS BOND BEAM WITH (2) #5 BARS SHALL BE PROVIDED NEAR THE TOP AND BOTTOM OF ALL CMU WALLS AND AT INTERVALS OF 4'-0" VERTICALLY, UNLESS NOTED OTHERWISE IN PLANS. ALL BOND BEAMS SHALL BE REINFORCED WITH (2) #5 BARS UNLESS NOTED OTHERWISE IN PLANS.
- 8. FOUNDATION DOWELS SHALL EXTEND INTO FOUNDATION CONCRETE. SPLICES LENGTHS FOR WALL REINFORCEMENT SHALL BE DEVELOPED A MINIMUM OF 48". BEND DIAMETER FOR REINFORCING BARS SHALL BE A MINIMUM OF 6 x BAR DIA. WITH A MINIMUM EXTENSION OF 7.5", AND HOOK EXTENSIONS SHALL BE A MINIMUM OF 13 x BAR DIA. THERE SHALL BE A FOUNDATION DOWEL FOR EACH VERTICAL WALL REINFORCEMENT.
- 9. HORIZONTAL REINFORCING SHALL BE KNOCKOUT BOND BEAMS WITH (2) #5 CONTINUOUS UNLESS NOTED OTHERWISE. CORNER BARS SHALL BE INSTALLED IN BOND BEAMS.
- 10. CORNER BARS SHALL BE PROVIDED FOR ALL HORIZONTAL REINFORCEMENT, WITH A MINIMUM LEG LENGTH OF 2'-0" OR 48" x BAR DIA., WHICHEVER IS GREATER.
- 11. NORMAL VERTICAL WALL REINFORCING SHALL EXTEND CONTINUOUSLY FROM THE TOP OF THE FOUNDATION TO EMBED AT LEAST 6" INTO THE TOP OF WALL BOND BEAM, THE VERTICAL SLOTS IN KNOCKOUT BOND BEAMS SHALL BE AT LEAST 3" INTO THE HEIGHT OF AN 8" HIGH BLOCK UNIT. AN ADDITIONAL #4 HOOKED DOWEL SHALL BE INSTALLED IN THE TOP OF ALL MASONRY WALLS AT EACH VERTICAL WALL CELL CONTAINING VERTICAL REINFORCING. DOWELS SHALL PROJECT 24" INTO THE WALL AND HOOK 6" INTO THE WALL TOP BOND BEAM.
- 12. AN ADDITIONAL VERTICAL BAR, SAME SIZE AND LENGTH AS THE NORMAL VERTICAL REINFORCING BAR SHALL BE
 - a. AS SHOWN ON DRAWINGS.
 - b. AT A CORNER INTERSECTION OF TWO WALLS. c. AT "T" INTERSECTIONS OF TWO WALLS.
 - d. AT EACH SIDE ON CONTROL JOINTS.
- e. AT END OF DISCONTINUOUS WALLS AND AT OPENINGS. 13. CORNER BLOCKS SHALL BE INTERWOVEN BETWEEN TWO WALLS.
- 14. NON-LOAD BEARING WALLS:
- a. PROVIDE CONTINUOUS BOND BEAMS WITH (2) #5 BARS NEAR THE TOP AND BOTTOM OF CMU WALLS AND AT INTERVALS OF 4'-0" VERTICALLY, UNLESS NOTED OTHERWISE IN PLANS.
- 16. EVERY PIER OR WALL SECTION WITH A WIDTH OF 3'-0" OR LESS SHALL HAVE HORIZONTAL SHEAR STEEL IN THE
- 17. ALL BOLTS, ANCHORS, REINFORCEMENT AND EMBEDDED ITEMS SHALL BE GROUTED IN PLACE.
- 18. CONTINUE REINFORCEMENT THROUGH MASONRY CONTROL JOINTS FOR BOND BEAMS AT FLOOR AND TOP OF WALL.

STRUCTURAL STEEL

- 1. STRUCTURAL STEEL SHALL BE DETAILED, FABRICATED AND ERECTED IN CONFORMANCE WITH THE AISC360 "SPECIFICATION FOR STRUCTURAL STEEL". SEISMIC DESIGN OF STRUCTURAL STEEL STRUCTURES SHALL CONFORM
- 2. STRUCTURAL STEEL SHALL CONFORM TO THE FOLLOWING ASTM SPECIFICATIONS: (SEE MATERIAL SPECIFICATIONS THIS SHEET)
- 3. ALL WELDING SHALL CONFORM TO THE SPECIFICATIONS OF THE AMERICAN WELDING SOCIETY. WELDING ELECTRODES SHALL BE E-70 SERIES. WELDING SHALL BE DONE BY A CERTIFIED WELDER.
- 4. WELDS NOT SPECIFIED ON PLANS SHALL BE OF SIZE AND TYPE BASED ON AISC AND AWS STANDARDS FOR
- 5. WELDING ELECTRODES SHALL BE E6022 WHEN METAL DECK IS WELDED.
- 6. HIGH STRENGTH BOLTS SHALL BE 3/4" DIAMETER (U.N.O.) CONFORMING TO ASTM A-325. CONNECTIONS SHALL BE DESIGNED AS BEARING TYPE WITH THREADS IN SHEAR PLANE. HOLES SHALL BE 1/16" LARGER THAN BOLT SIZE (U.N.O.)
- 7. NO OPENINGS SHALL BE CUT IN STRUCTURAL MEMBERS UNLESS SHOWN ON THE DRAWINGS.
- 8. ALL STEEL SHALL BE SHOP PRIMED PRIOR TO SHIPMENT TO JOB SITE. REFER TO ARCHITECTURAL PLANS AND SPECIFICATIONS FOR FINISH PAINT.

DESIGN CODES (ALL LATEST EDITION U.N.O.)

- INTERNATIONAL BUILDING CODE (IBC 2018)

AMERICAN WELDING SOCIETY (AWS)

- AMERICAN SOCIETY OF CIVIL ENGINEERS (ASCE 7-16) MINIMUM DESIGN LOADS FOR BUILDINGS AND OTHER STRUCTURES
- AMERICAN CONCRETE INSTITUTE (ACI)
- AMERICAN INSTITUTE OF STEEL CONSTRUCTION (AISC)
- AMERICAN IRON AND STEEL INSTITUTE (SPECIFICATIONS FOR THE DESIGN OF COLD FORMED STEEL CONSTRUCTION MEMBERS)

(ASTM A616 (S1), GRADE 60)

MATERIAL SPECIFICATIONS

- ANCHOR BOLTS $Fy = 55,000 \, PSI \, (ASTM \, F1554)$ - EMBEDDED STEEL $Fy = 36,000 \, PSI \, (ASTM \, A36)$
- REINFORCING STEEL – #3 OR LARGER $Fy = 60,000 \, PSI \, (ASTM A615, GRADE 60)$
- WELDED WIRE FABRIC ASTM A185 (FLAT SHEETS ONLY)
- Fy = 50 KSI - STRUCTURAL STEEL - STRUCTURAL ANGLE Fy = 36 KSI
- STRUCTURAL TUBE Fy = 46 KSI- HIGH STRENGTH STRUCTURAL BOLTS ASTM A325-N (U.N.O.)



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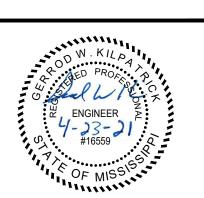
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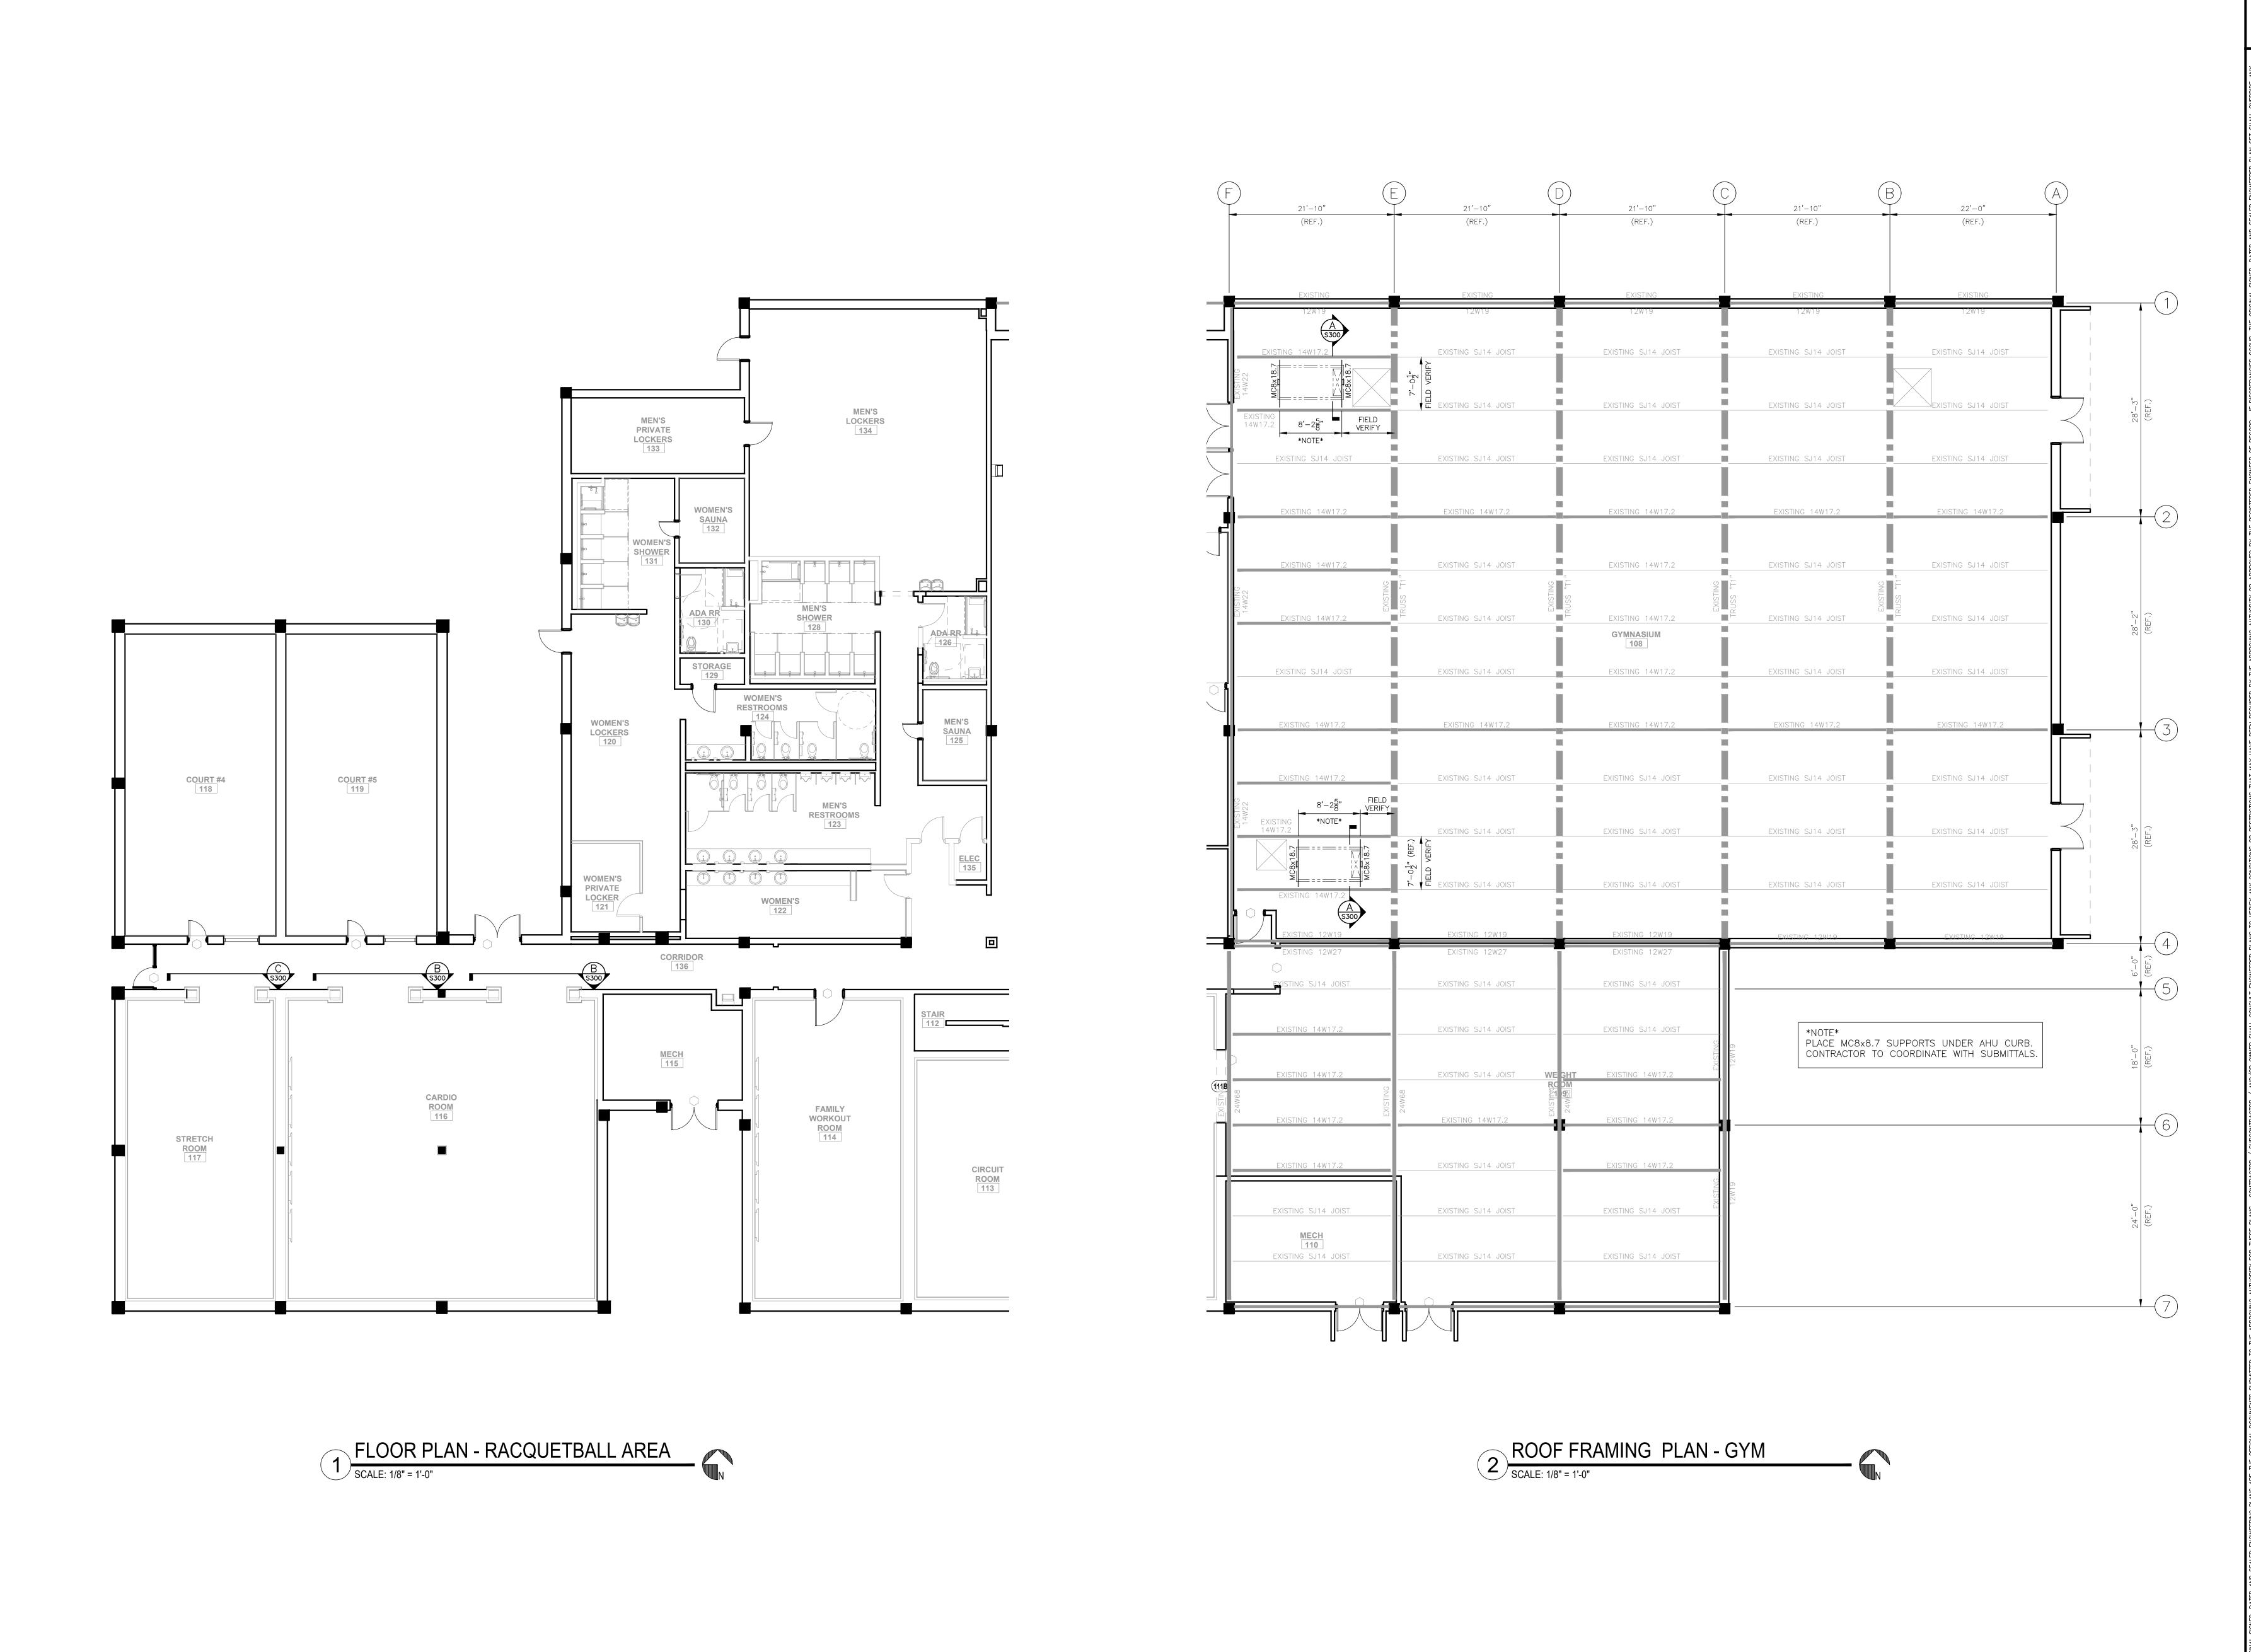
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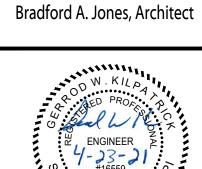


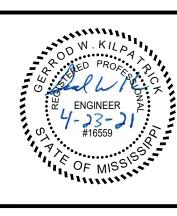
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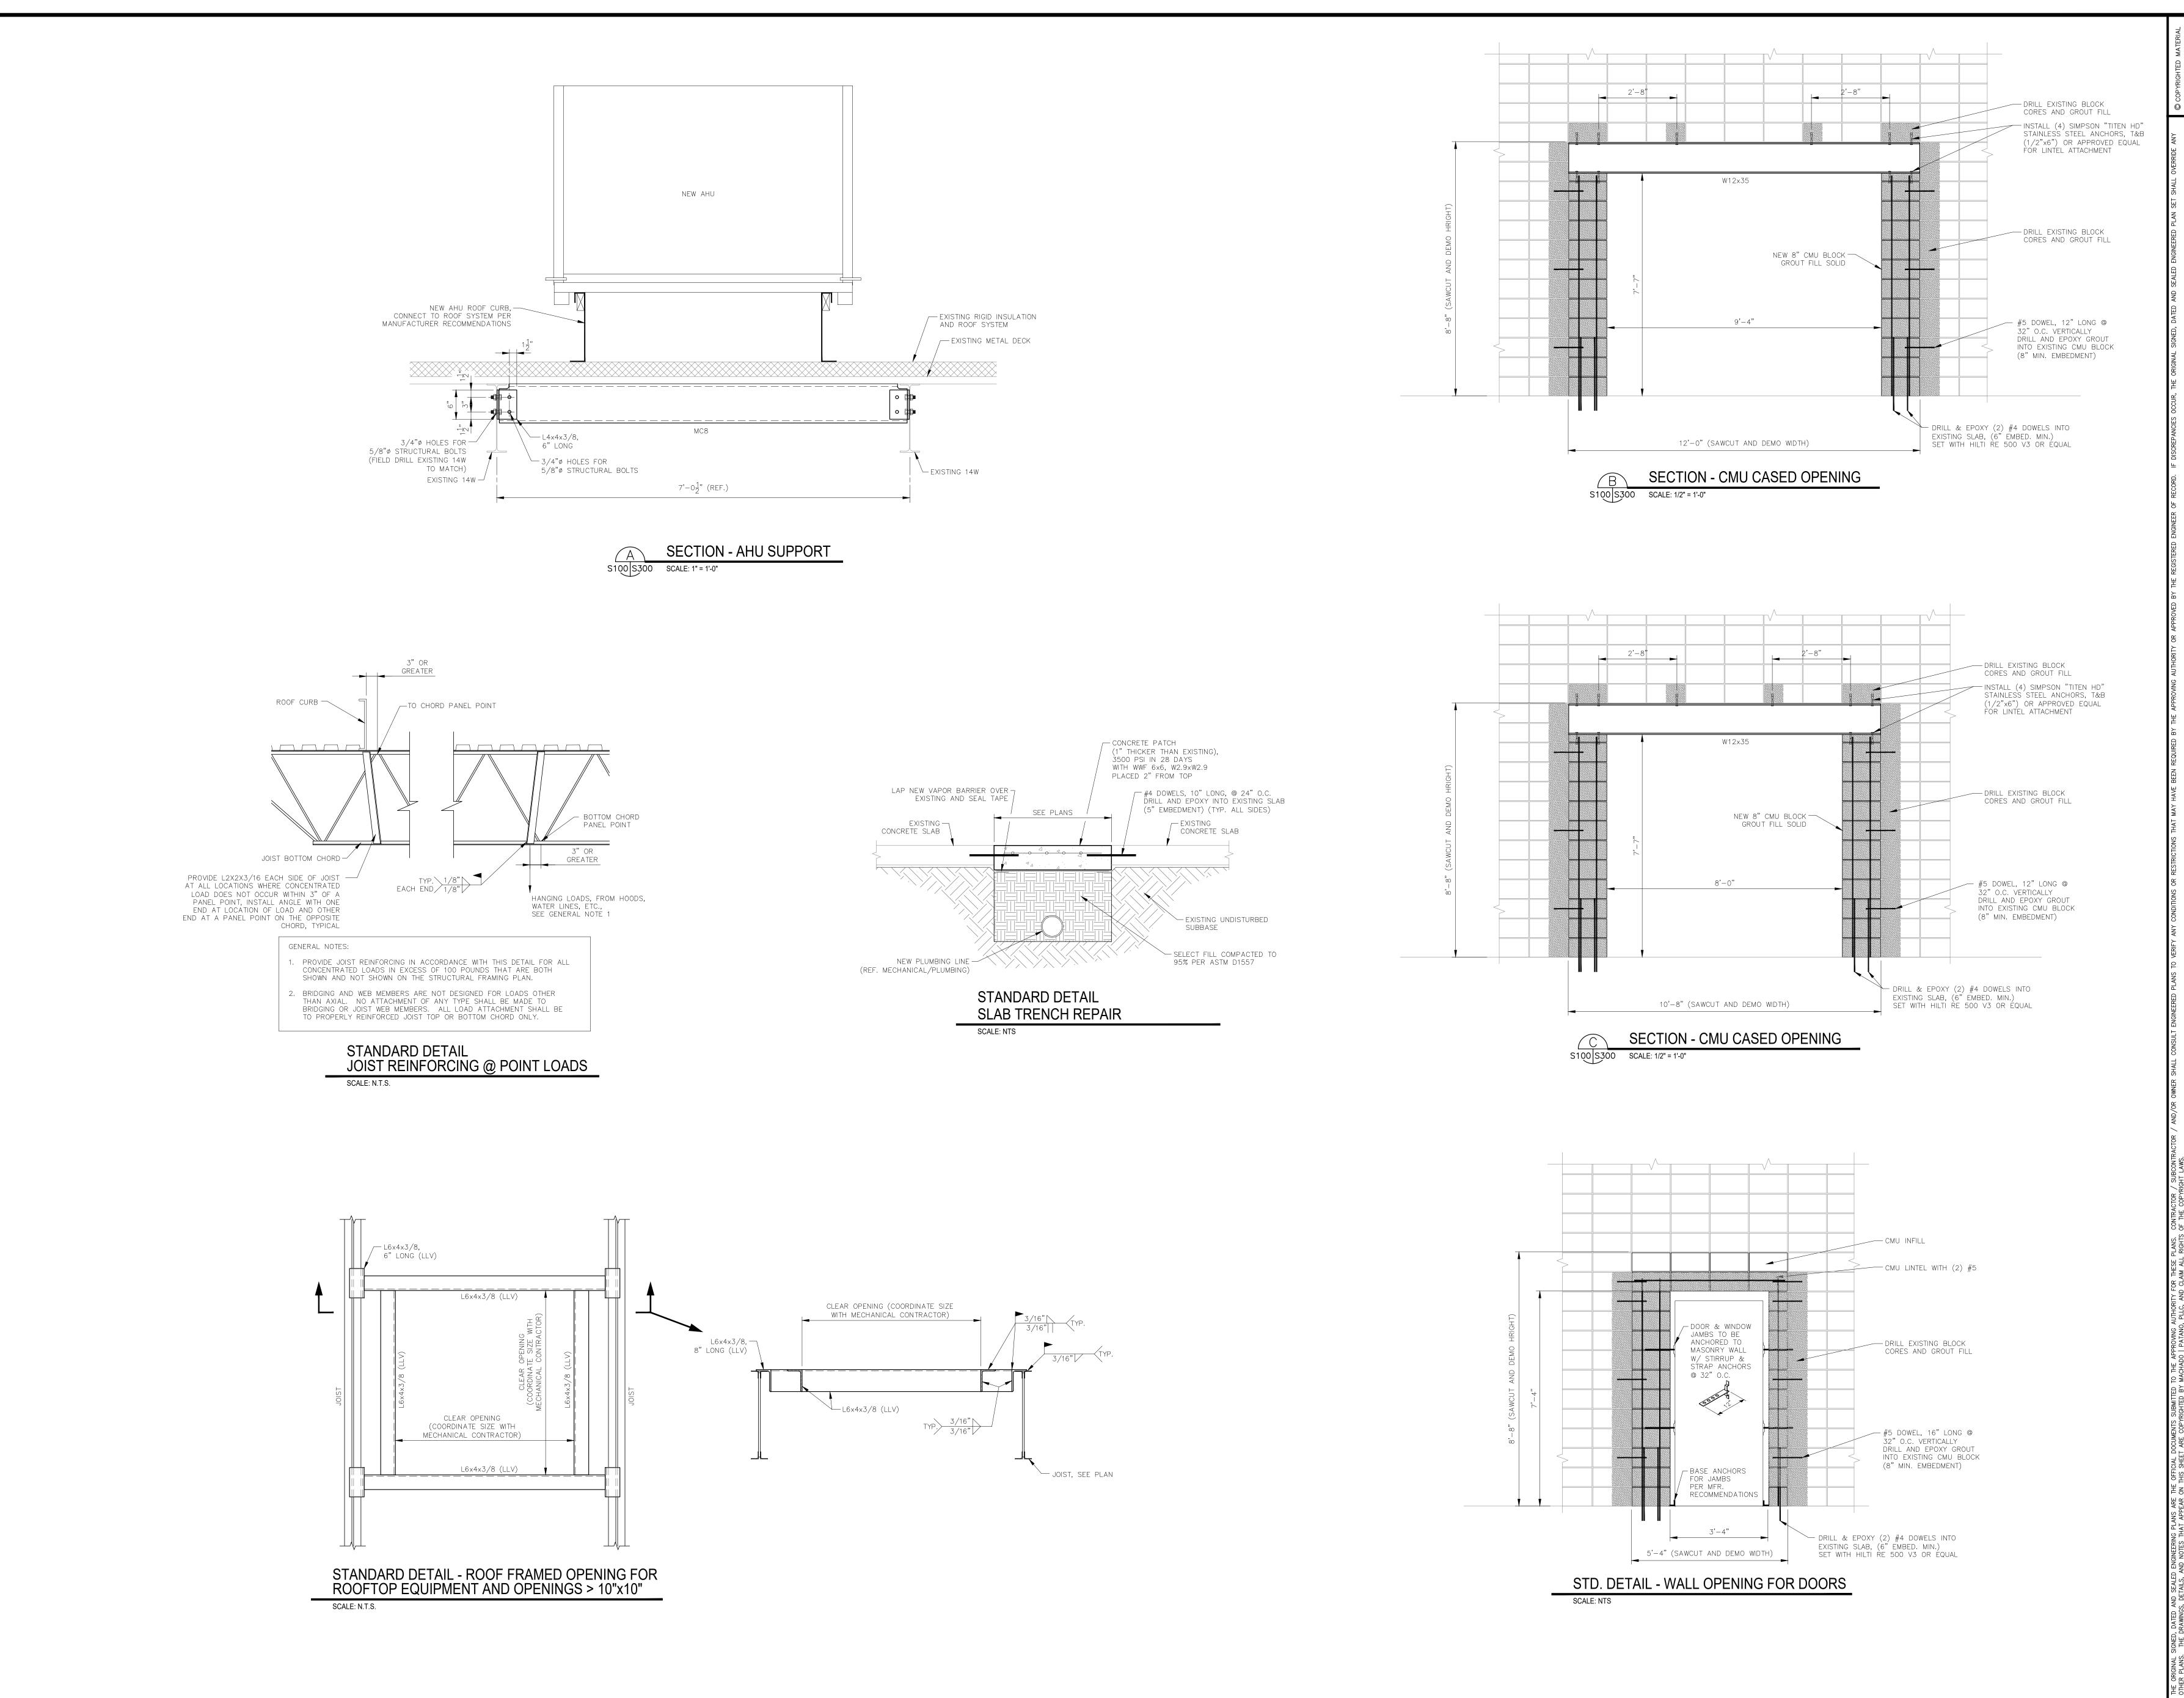




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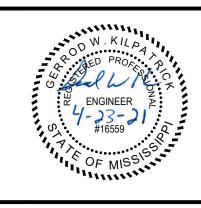
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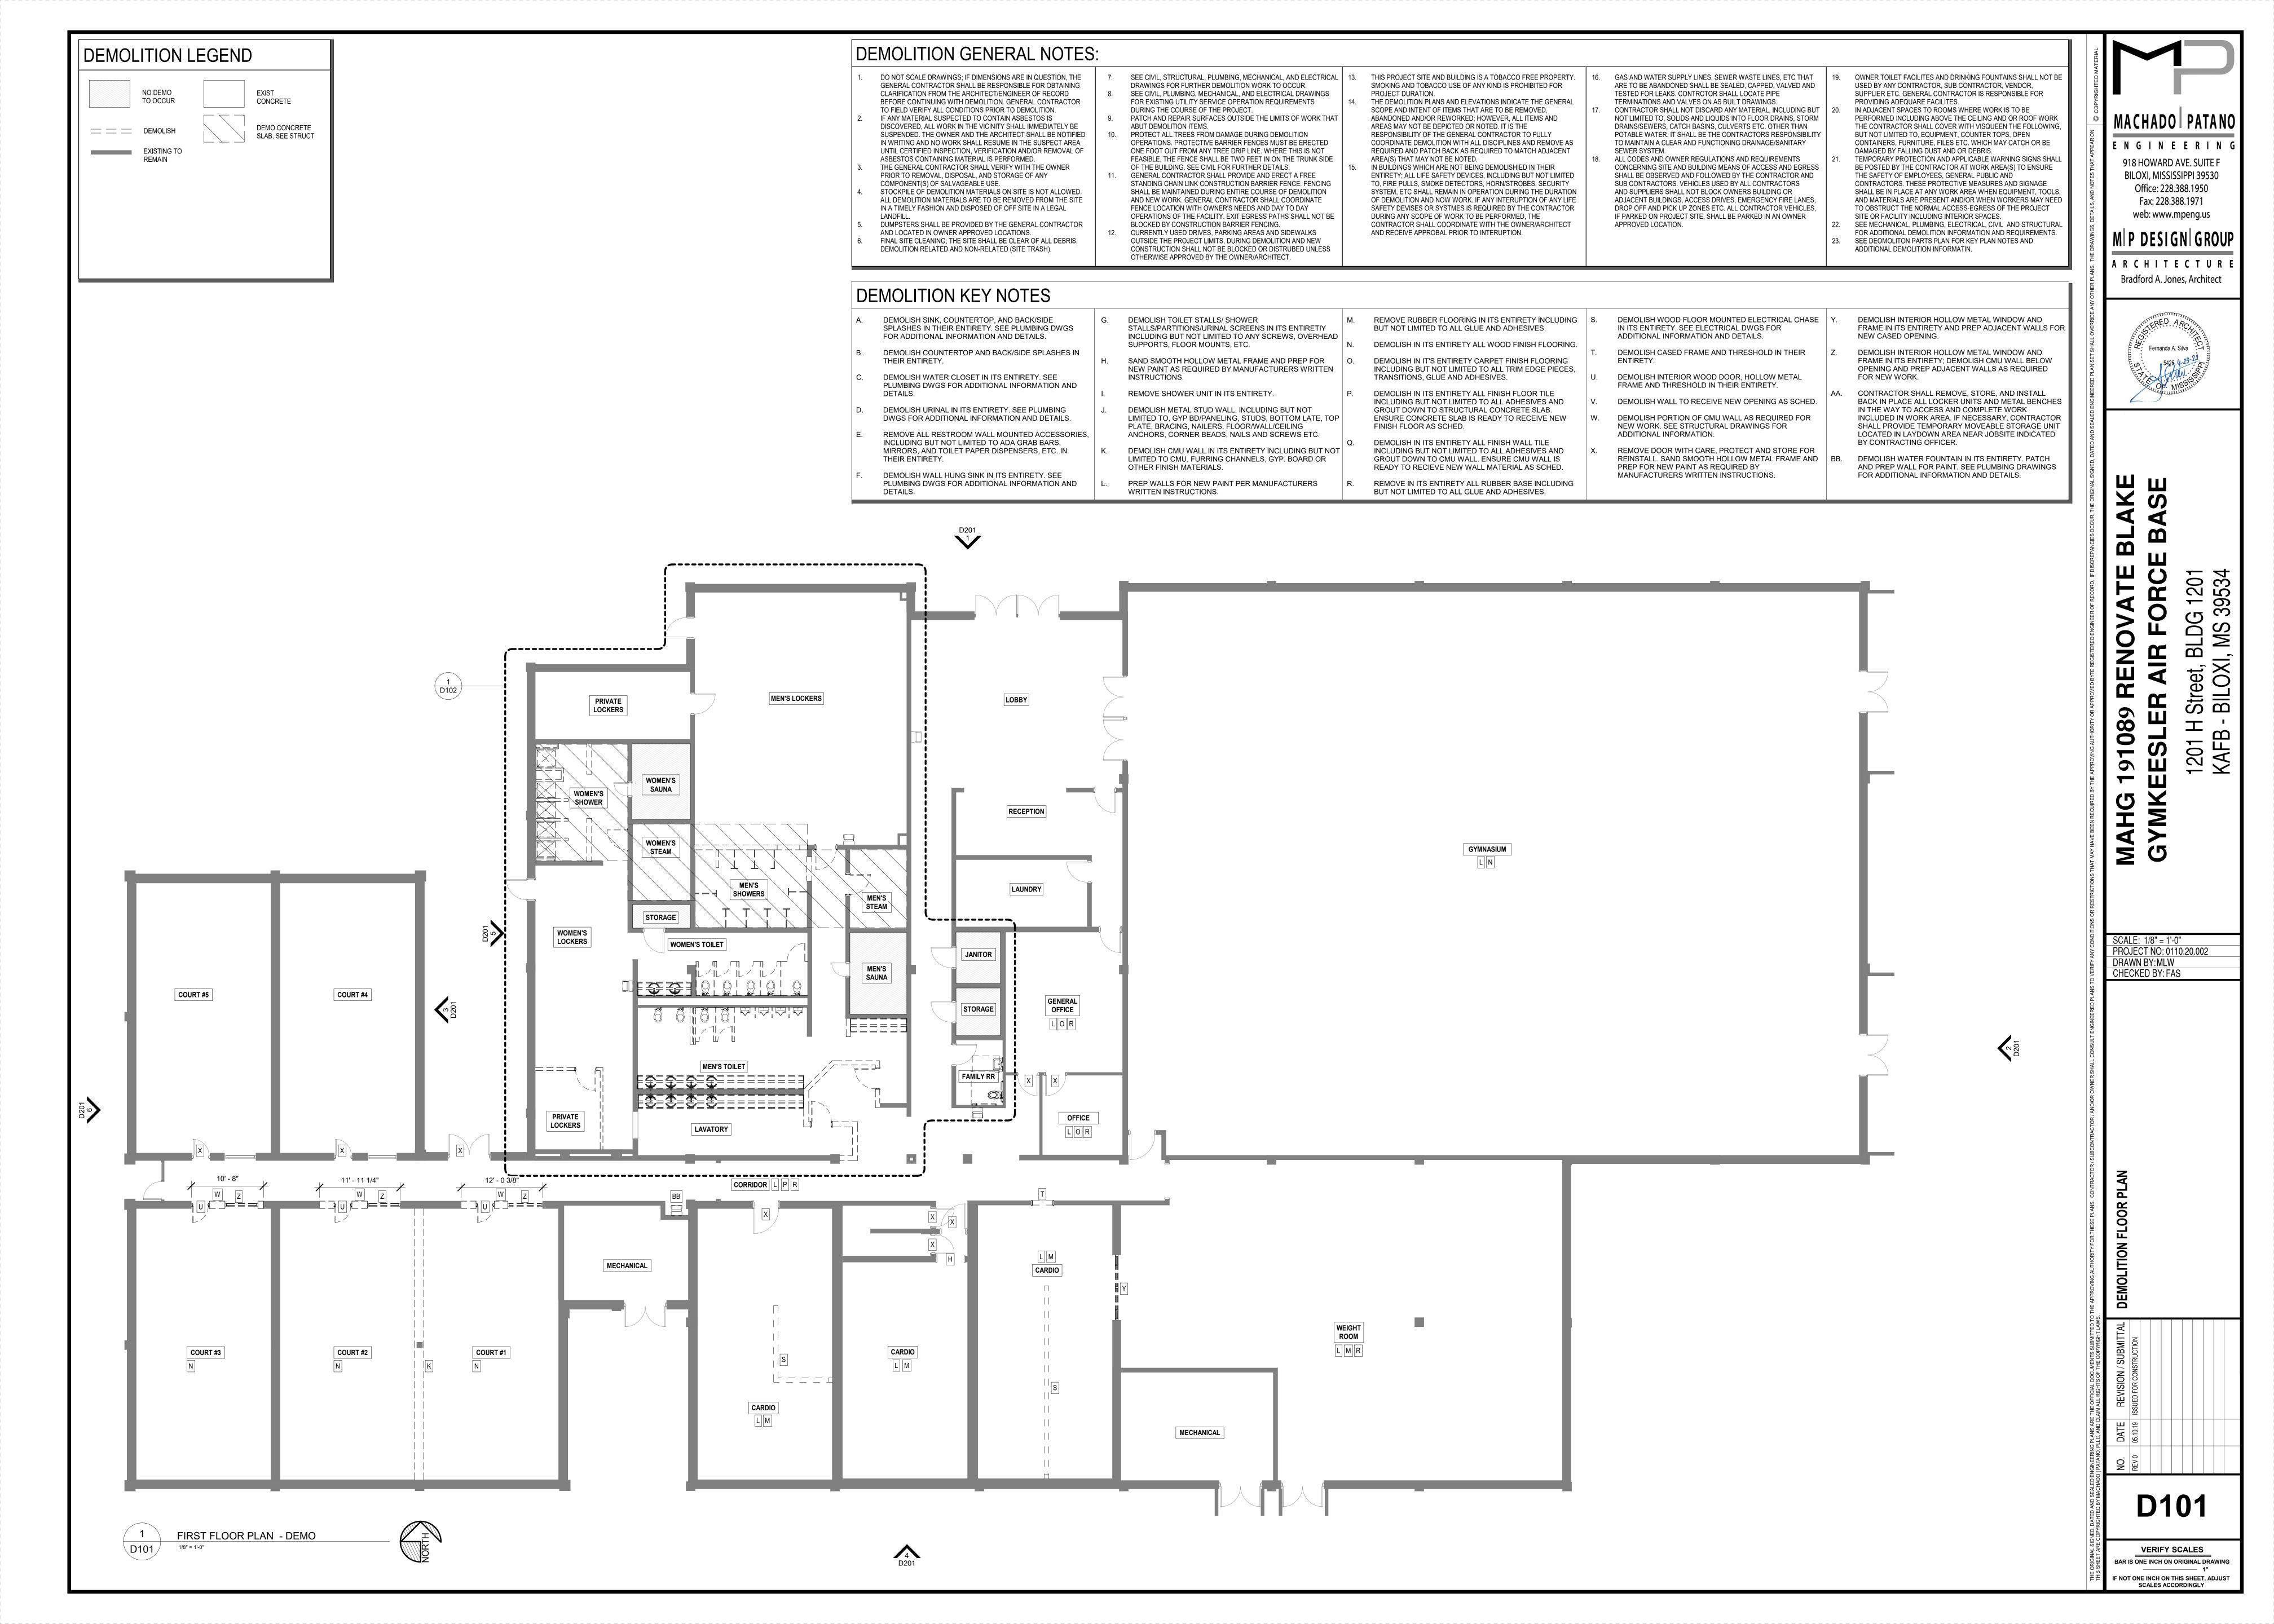
Bradford A. Jones, Architect




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- SEE CIVIL, STRUCTURAL, PLUMBING, MECHANICAL, AND ELECTRICAL 13.
- DRAWINGS FOR FURTHER DEMOLITION WORK TO OCCUR. SEE CIVIL, PLUMBING, MECHANICAL, AND ELECTRICAL DRAWINGS FOR EXISTING UTILITY SERVICE OPERATION REQUIREMENTS DURING THE COURSE OF THE PROJECT.
- PROTECT ALL TREES FROM DAMAGE DURING DEMOLITION OPERATIONS. PROTECTIVE BARRIER FENCES MUST BE ERECTED ONE FOOT OUT FROM ANY TREE DRIP LINE. WHERE THIS IS NOT FEASIBLE, THE FENCE SHALL BE TWO FEET IN ON THE TRUNK SIDE
- STANDING CHAIN LINK CONSTRUCTION BARRIER FENCE. FENCING SHALL BE MAINTAINED DURING ENTIRE COURSE OF DEMOLITION AND NEW WORK. GENERAL CONTRACTOR SHALL COORDINATE FENCE LOCATION WITH OWNER'S NEEDS AND DAY TO DAY OPERATIONS OF THE FACILITY. EXIT EGRESS PATHS SHALL NOT BE BLOCKED BY CONSTRUCTION BARRIER FENCING. CURRENTLY USED DRIVES, PARKING AREAS AND SIDEWALKS OUTSIDE THE PROJECT LIMITS, DURING DEMOLITION AND NEW
- CONSTRUCTION SHALL NOT BE BLOCKED OR DISTRUBED UNLESS
- THIS PROJECT SITE AND BUILDING IS A TOBACCO FREE PROPERTY. SMOKING AND TOBACCO USE OF ANY KIND IS PROHIBITED FOR PROJECT DURATION.
- THE DEMOLITION PLANS AND ELEVATIONS INDICATE THE GENERAL SCOPE AND INTENT OF ITEMS THAT ARE TO BE REMOVED, ABANDONED AND/OR REWORKED; HOWEVER, ALL ITEMS AND AREAS MAY NOT BE DEPICTED OR NOTED. IT IS THE RESPONSIBILITY OF THE GENERAL CONTRACTOR TO FULLY COORDINATE DEMOLITION WITH ALL DISCIPLINES AND REMOVE AS REQUIRED AND PATCH BACK AS REQUIRED TO MATCH ADJACENT AREA(S) THAT MAY NOT BE NOTED.
- IN BUILDINGS WHICH ARE NOT BEING DEMOLISHIED IN THEIR ENTIRETY: ALL LIFE SAFETY DEVICES, INCLUDING BUT NOT LIMITED TO, FIRE PULLS, SMOKE DETECTORS, HORN/STROBES, SECURITY SYSTEM, ETC SHALL REMAIN IN OPERATION DURING THE DURATION OF DEMOLITION AND NOW WORK. IF ANY INTERUPTION OF ANY LIFE SAFETY DEVISES OR SYSTMES IS REQUIRED BY THE CONTRACTOR DURING ANY SCOPE OF WORK TO BE PERFORMED, THE CONTRACTOR SHALL COORDINATE WITH THE OWNER/ARCHITECT AND RECEIVE APPROBAL PRIOR TO INTERUPTION.
- GAS AND WATER SUPPLY LINES, SEWER WASTE LINES, ETC THAT ARE TO BE ABANDONED SHALL BE SEALED, CAPPED, VALVED AND TESTED FOR LEAKS, CONTRCTOR SHALL LOCATE PIPE TERMINATIONS AND VALVES ON AS BUILT DRAWINGS.
- CONTRACTOR SHALL NOT DISCARD ANY MATERIAL, INCLUDING BUT NOT LIMITED TO, SOLIDS AND LIQUIDS INTO FLOOR DRAINS, STORM DRAINS/SEWERS, CATCH BASINS, CULVERTS ETC. OTHER THAN POTABLE WATER. IT SHALL BE THE CONTRACTORS RESPONSIBILITY TO MAINTAIN A CLEAR AND FUNCTIONING DRAINAGE/SANITARY SEWER SYSTEM.
- ALL CODES AND OWNER REGULATIONS AND REQUIREMENTS CONCERNING SITE AND BUILDING MEANS OF ACCESS AND EGRESS SHALL BE OBSERVED AND FOLLOWED BY THE CONTRACTOR AND SUB CONTRACTORS. VEHICLES USED BY ALL CONTRACTORS AND SUPPLIERS SHALL NOT BLOCK OWNERS BUILDING OR ADJACENT BUILDINGS, ACCESS DRIVES, EMERGENCY FIRE LANES, DROP OFF AND PICK UP ZONES ETC. ALL CONTRACTOR VEHICLES, IF PARKED ON PROJECT SITE, SHALL BE PARKED IN AN OWNER APPROVED LOCATION.
- OWNER TOILET FACILITES AND DRINKING FOUNTAINS SHALL NOT BE USED BY ANY CONTRACTOR, SUB CONTRACTOR, VENDOR, SUPPLIER ETC. GENERAL CONTRACTOR IS RESPONSIBLE FOR PROVIDING ADEQUARE FACILITES. IN ADJACENT SPACES TO ROOMS WHERE WORK IS TO BE
 - PERFORMED INCLUDING ABOVE THE CEILING AND OR ROOF WORK THE CONTRACTOR SHALL COVER WITH VISQUEEN THE FOLLOWING, BUT NOT LIMITED TO, EQUIPMENT, COUNTER TOPS, OPEN CONTAINERS, FURNITURE, FILES ETC. WHICH MAY CATCH OR BE DAMAGED BY FALLING DUST AND OR DEBRIS. TEMPORARY PROTECTION AND APPLICABLE WARNING SIGNS SHALL BE POSTED BY THE CONTRACTOR AT WORK AREA(S) TO ENSURE THE SAFETY OF EMPLOYEES, GENERAL PUBLIC AND CONTRACTORS. THESE PROTECTIVE MEASURES AND SIGNAGE SHALL BE IN PLACE AT ANY WORK AREA WHEN EQUIPMENT. TOOLS. AND MATERIALS ARE PRESENT AND/OR WHEN WORKERS MAY NEED TO OBSTRUCT THE NORMAL ACCESS-EGRESS OF THE PROJECT
 - SITE OR FACILITY INCLUDING INTERIOR SPACES. SEE MECHANICAL, PLUMBING, ELECTRICAL, CIVIL AND STRUCTURAL FOR ADDITIONAL DEMOLITION INFORMATION AND REQUIREMENTS. SEE DEOMOLITON PARTS PLAN FOR KEY PLAN NOTES AND ADDITIONAL DEMOLITION INFORMATIN.

DEMOLITION LEGEND

NO DEMO **EXIST** TO OCCUR CONCRETE DEMO CONCRETE SLAB, SEE STRUCT EXISTING TO REMAIN

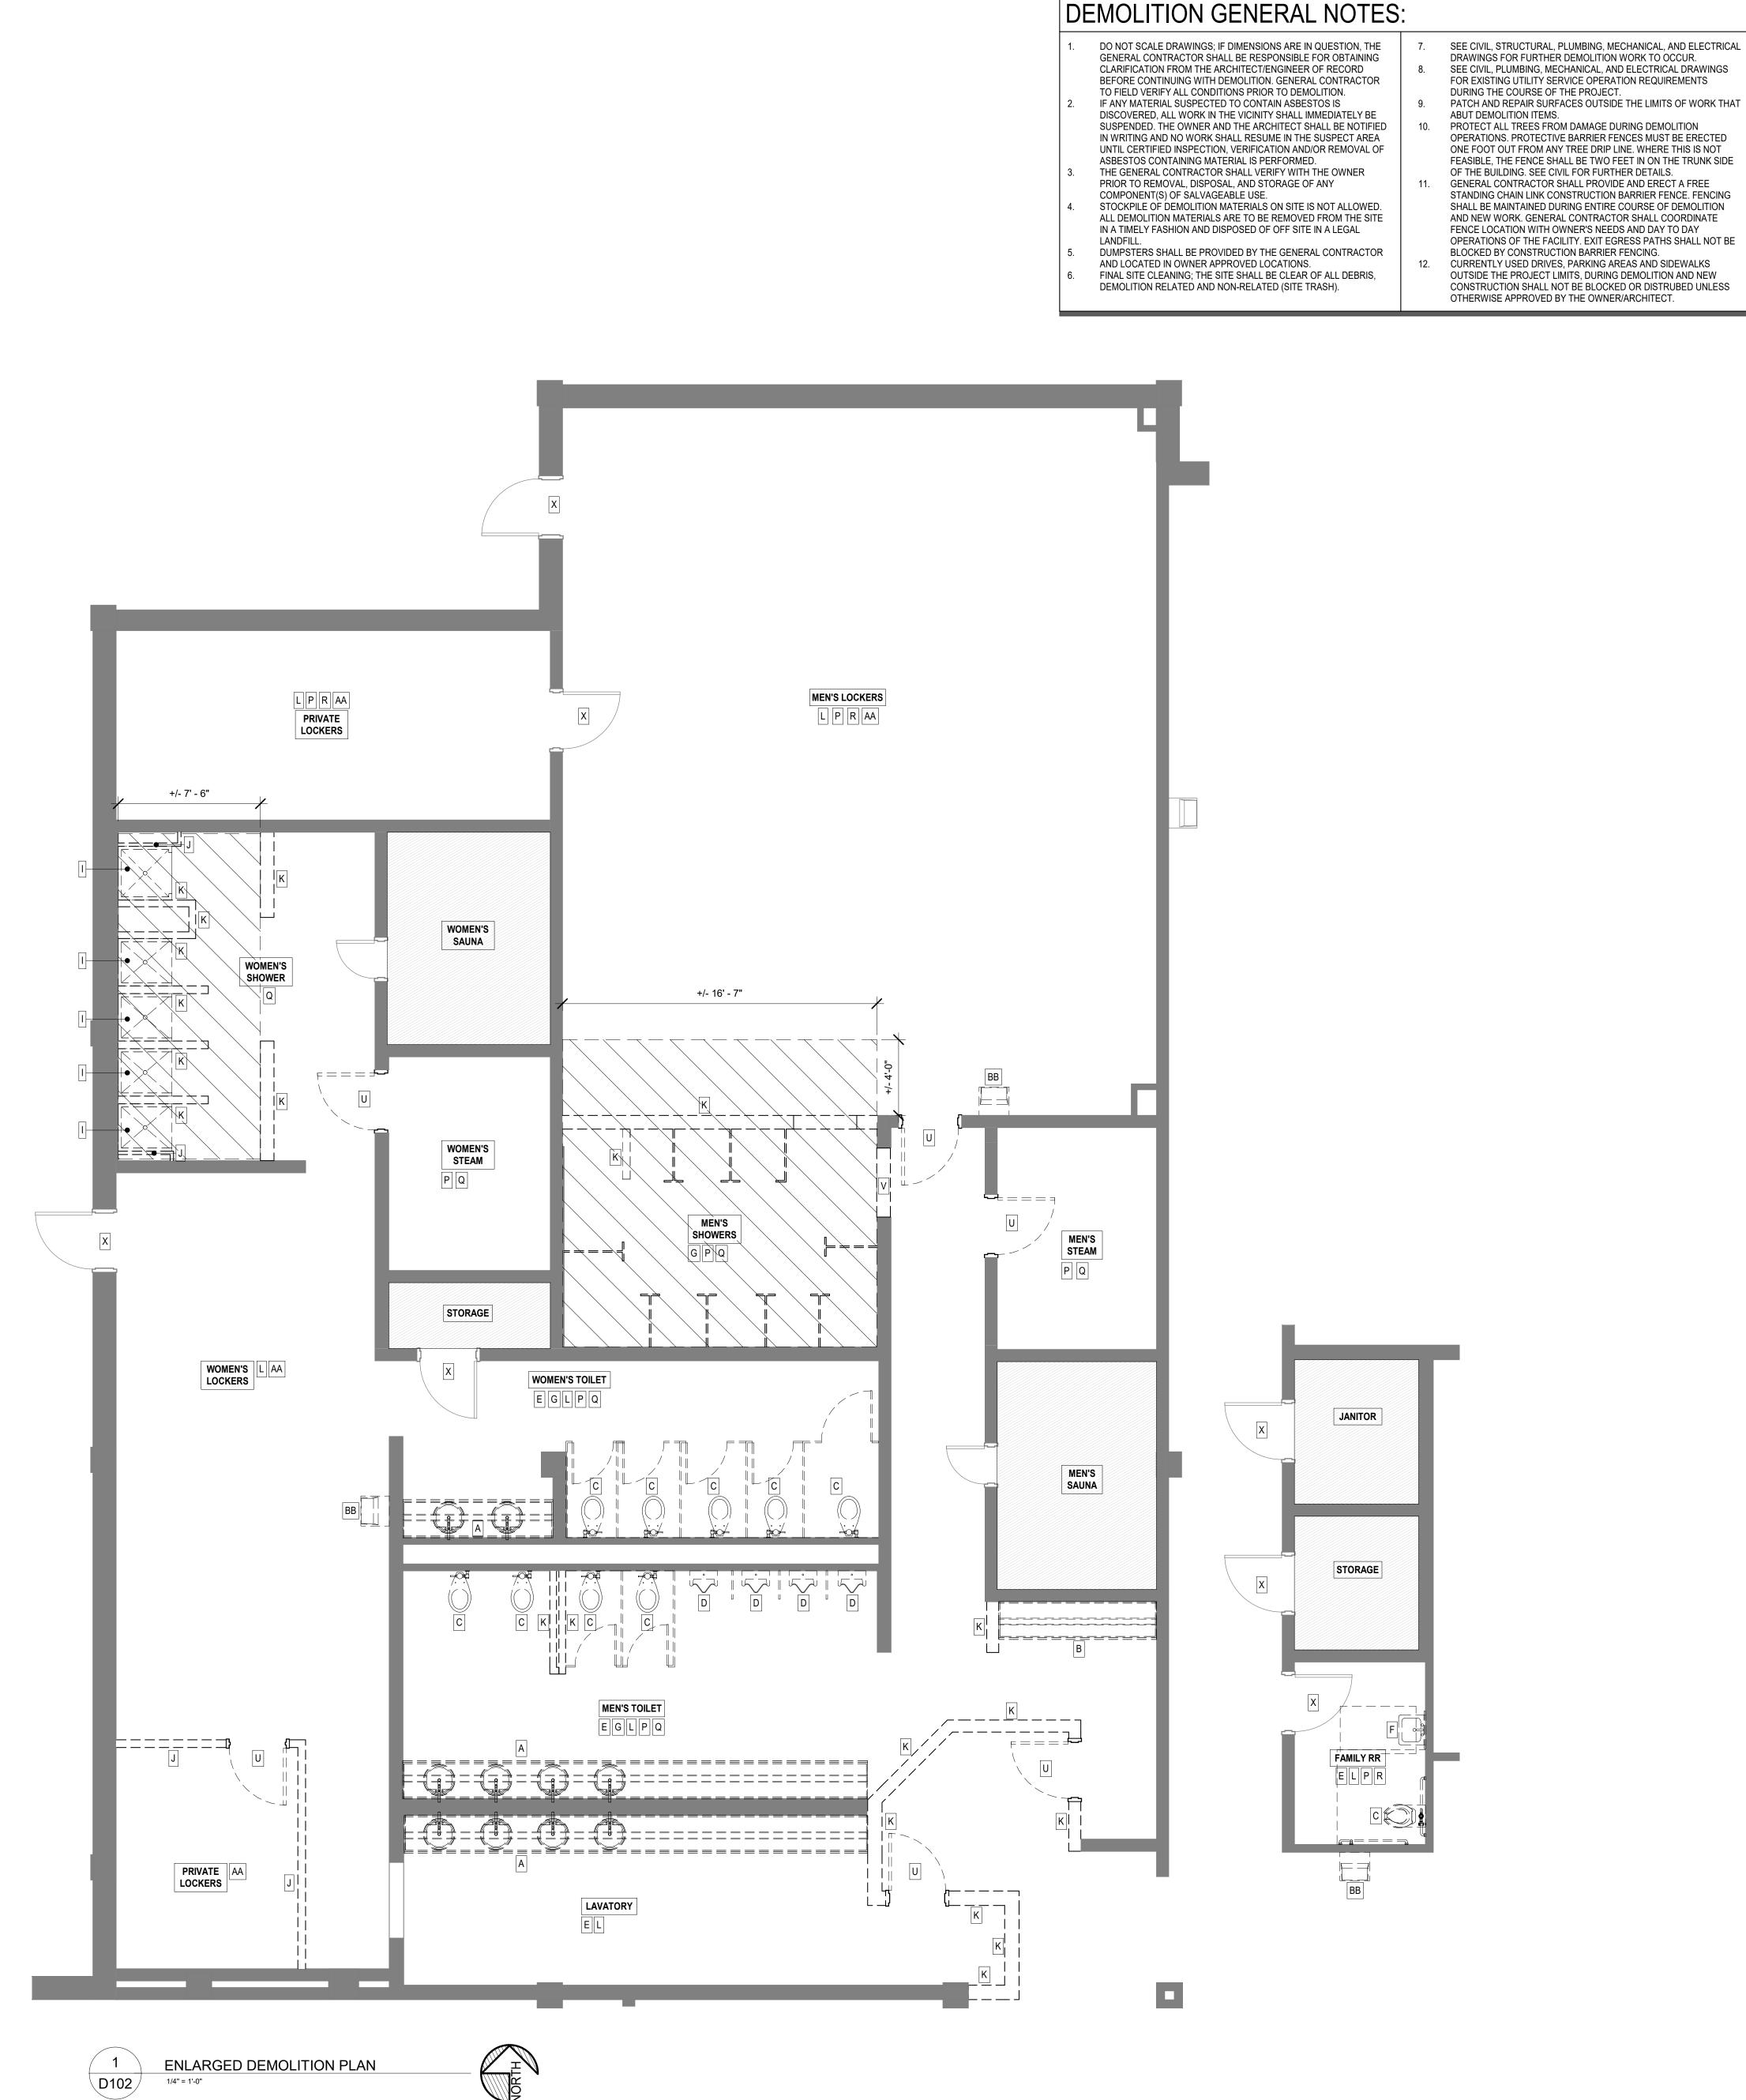DEMOLITION KEY NOTES

- DEMOLISH SINK, COUNTERTOP, AND BACK/SIDE
 - DEMOLISH COUNTERTOP AND BACK/SIDE SPLASHES IN THEIR ENTIRETY.
- DEMOLISH WATER CLOSET IN ITS ENTIRETY. SEE PLUMBING DWGS FOR ADDITIONAL INFORMATION AND
- DEMOLISH URINAL IN ITS ENTIRETY. SEE PLUMBING
- REMOVE ALL RESTROOM WALL MOUNTED ACCESSORIES, INCLUDING BUT NOT LIMITED TO ADA GRAB BARS. MIRRORS, AND TOILET PAPER DISPENSERS, ETC. IN
- DEMOLISH WALL HUNG SINK IN ITS ENTIRETY. SEE PLUMBING DWGS FOR ADDITIONAL INFORMATION AND
- DEMOLISH TOILET STALLS/ SHOWER INCLUDING BUT NOT LIMITED TO ANY SCREWS,
- SAND SMOOTH HOLLOW METAL FRAME AND PREP FOR NEW PAINT AS REQUIRED BY MANUFACTURERS WRITTEN
- DEMOLISH METAL STUD WALL, INCLUDING BUT NOT LIMITED TO, GYP BD/PANELING, STUDS, BOTTOM LATE, TOP PLATE, BRACING, NAILERS, FLOOR/WALL/CEILING
- WRITTEN INSTRUCTIONS.
- REMOVE RUBBER FLOORING IN ITS ENTIRETY INCLUDING BUT NOT LIMITED TO ALL GLUE AND ADHESIVES.
- DEMOLISH IN ITS ENTIRETY ALL WOOD FINISH FLOORING.
- TRANSITIONS, GLUE AND ADHESIVES. DEMOLISH IN ITS ENTIRETY ALL FINISH FLOOR TILE
- DEMOLISH IN ITS ENTIRETY ALL FINISH WALL TILE INCLUDING BUT NOT LIMITED TO ALL ADHESIVES AND GROUT DOWN TO CMU WALL. ENSURE CMU WALL IS
- READY TO RECIEVE NEW WALL MATERIAL AS SCHED. REMOVE IN ITS ENTIRETY ALL RUBBER BASE INCLUDING
- BUT NOT LIMITED TO ALL GLUE AND ADHESIVES. DEMOLISH WOOD FLOOR MOUNTED ELECTRICAL CHASE IN ITS ENTIRETY. SEE ELECTRICAL DWGS FOR ADDITIONAL INFORMATION AND DETAILS.
- DEMOLISH INTERIOR WOOD DOOR, HOLLOW METAL FRAME AND THRESHOLD IN THEIR ENTIRETY.
- DEMOLISH WALL TO RECEIVE NEW OPENING AS SCHED,
- DEMOLISH PORTION OF CMU WALL AS REQUIRED FOR NEW WORK. SEE STRUCTURAL DRAWINGS FOR
- REMOVE DOOR WITH CARE, PROTECT AND STORE FOR REINSTALL. SAND SMOOTH HOLLOW METAL FRAME AND PREP FOR NEW PAINT AS REQUIRED BY
- DEMOLISH INTERIOR HOLLOW METAL WINDOW AND FRAME IN ITS ENTIRETY AND PREP ADJACENT WALLS FOR

NEW CASED OPENING.

- DEMOLISH INTERIOR HOLLOW METAL WINDOW AND FRAME IN ITS ENTIRETY; DEMOLISH CMU WALL BELOW OPENING AND PREP ADJACENT WALLS AS REQUIRED FOR NEW WORK.
- CONTRACTOR SHALL REMOVE, STORE, AND INSTALL BACK IN PLACE ALL LOCKER UNITS AND METAL BENCHES IN THE WAY TO ACCESS AND COMPLETE WORK INCLUDED IN WORK AREA. IF NECESSARY, CONTRACTOR SHALL PROVIDE TEMPORARY MOVEABLE STORAGE UNIT LOCATED IN LAYDOWN AREA NEAR JOBSITE INDICATED


- SPLASHES IN THEIR ENTIRETY. SEE PLUMBING DWGS FOR ADDITIONAL INFORMATION AND DETAILS.
- DETAILS.
- DWGS FOR ADDITIONAL INFORMATION AND DETAILS.
- THEIR ENTIRETY AND RETURN TO OWNER.
- STALLS/PARTITIONS/URINAL SCREENS IN ITS ENTIRETIY OVERHEAD SUPPORTS, FLOOR MOUNTS, ETC.
- INSTRUCTIONS.
- REMOVE SHOWER UNIT IN ITS ENTIRETY.
- ANCHORS, CORNER BEADS, NAILS AND SCREWS ETC.
- DEMOLISH CMU WALL IN ITS ENTIRETY INCLUDING BUT NOT LIMITED TO CMU, FURRING CHANNELS, GYP. BOARD OR OTHER FINISH MATERIALS.
- PREP WALLS FOR NEW PAINT PER MANUFACTURERS
- DEMOLISH IN IT'S ENTIRETY CARPET FINISH FLOORING INCLUDING BUT NOT LIMITED TO ALL TRIM EDGE PIECES,
- INCLUDING BUT NOT LIMITED TO ALL ADHESIVES AND GROUT DOWN TO STRUCTURAL CONCRETE SLAB. ENSURE CONCRETE SLAB IS READY TO RECEIVE NEW FINISH FLOOR AS SCHED.

- DEMOLISH CASED FRAME AND THRESHOLD IN THEIR
- SEE SHEET A601.
- ADDITIONAL INFORMATION.
- MANUFACTURERS WRITTEN INSTRUCTIONS.
- BY CONTRACTING OFFICER.
- DEMOLISH WATER FOUNTAIN IN ITS ENTIRETY. PATCH AND PREP WALL FOR PAINT. SEE PLUMBING DRAWINGS FOR ADDITIONAL INFORMATION AND DETAILS.

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ARCHITECTURI



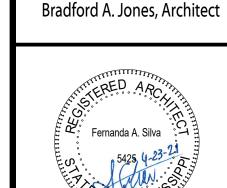Stree BILO

SCALE: As indicated PROJECT NO: 0110.20.002 DRAWN BY:MLW CHECKED BY: FAS

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CEILING TO BE DEMO		NO WORK REQUIRED	SD	SMOKE DETECTOR TO BE REINSTALLED
SECONDARY CEILING TO BE DEMO	_	EXISTING TO REMAIN	•	SPRINKLER HEAD TO REMAIN
	===	DEMOLISH	ı	SURFACE LIGHTING FIXTURE TO BE DEMO
2 X 4 LIGHTING FIXTURE TO REMAIN		2 X 4 LIGHTING FIXTURE TO BE DEMO	0	RECESSED DOWN LIGHT TO BE
2 X 2 LIGHTING FIXTURE TO REMAIN		SUSPENDED LINEAR FIXTURE TO		DEMO
SUPPLY DIFFUSER TO REMAIN		REMAIN		EXIT SIGN TO REMAIN - SEE ELEC FOR FULL EXTENTS
RETURN DIFFUSER TO REMAIN		SUPPLY DIFFUSER TO BE DEMO	<u>C</u>	CAMERA TO BE REINSTALLED
		RETURN DIFFUSER TO BE DEMO	S	SPEAKER TO BE REINSTALLED
IOTE:				

DEMOLITION GENERAL NOTES:

1. DO NOT SCALE DRAWINGS: IF DIMENSIONS ARE IN QUESTION. THE GENERAL CONTRACTOR SHALL BE RESPONSIBLE FOR OBTAINING CLARIFICATION FROM THE ARCHITECT/ENGINEER OF RECORD BEFORE CONTINUING WITH DEMOLITION. GENERAL CONTRACTOR TO FIELD VERIFY ALL CONDITIONS PRIOR TO DEMOLITION. IF ANY MATERIAL SUSPECTED TO CONTAIN ASBESTOS IS DISCOVERED. ALL WORK IN THE VICINITY SHALL IMMEDIATELY BE SUSPENDED. THE OWNER AND THE ARCHITECT SHALL BE NOTIFIED IN WRITING AND NO WORK SHALL RESUME IN THE SUSPECT AREA UNTIL CERTIFIED INSPECTION, VERIFICATION AND/OR REMOVAL OF ASBESTOS CONTAINING MATERIAL IS PERFORMED. THE GENERAL CONTRACTOR SHALL VERIFY WITH THE OWNER PRIOR TO REMOVAL, DISPOSAL, AND STORAGE OF ANY COMPONENT(S) OF SALVAGEABLE USE. STOCKPILE OF DEMOLITION MATERIALS ON SITE IS NOT ALLOWED. ALL DEMOLITION MATERIALS ARE TO BE REMOVED FROM THE SITE IN A TIMELY FASHION AND DISPOSED OF OFF SITE IN A LEGAL

DUMPSTERS SHALL BE PROVIDED BY THE GENERAL CONTRACTOR

FINAL SITE CLEANING; THE SITE SHALL BE CLEAR OF ALL DEBRIS,

DEMOLITION RELATED AND NON-RELATED (SITE TRASH).

AND LOCATED IN OWNER APPROVED LOCATIONS.

10. PROTECT ALL TREES FROM DAMAGE DURING DEMOLITION OPERATIONS. PROTECTIVE BARRIER FENCES MUST BE ERECTED ONE FOOT OUT FROM ANY TREE DRIP LINE. WHERE THIS IS NOT FEASIBLE, THE FENCE SHALL BE TWO FEET IN ON THE TRUNK SIDE OF THE BUILDING. SEE CIVIL FOR FURTHER DETAILS. GENERAL CONTRACTOR SHALL PROVIDE AND ERECT A FREE STANDING CHAIN LINK CONSTRUCTION BARRIER FENCE. FENCING SHALL BE MAINTAINED DURING ENTIRE COURSE OF DEMOLITION AND NEW WORK. GENERAL CONTRACTOR SHALL COORDINATE FENCE LOCATION WITH OWNER'S NEEDS AND DAY TO DAY OPERATIONS OF THE FACILITY. EXIT EGRESS PATHS SHALL NOT BE BLOCKED BY CONSTRUCTION BARRIER FENCING. 12. CURRENTLY USED DRIVES, PARKING AREAS AND SIDEWALKS OUTSIDE THE PROJECT LIMITS, DURING DEMOLITION AND NEW CONSTRUCTION SHALL NOT BE BLOCKED OR DISTRUBED UNLESS

OTHERWISE APPROVED BY THE OWNER/ARCHITECT.

DRAWINGS FOR FURTHER DEMOLITION WORK TO OCCUR.

DURING THE COURSE OF THE PROJECT.

ABUT DEMOLITION ITEMS.

SEE CIVIL, PLUMBING, MECHANICAL, AND ELECTRICAL DRAWINGS

FOR EXISTING UTILITY SERVICE OPERATION REQUIREMENTS

SEE CIVIL. STRUCTURAL, PLUMBING, MECHANICAL, AND ELECTRICAL | 13. THIS PROJECT SITE AND BUILDING IS A TOBACCO FREE PROPERTY. SMOKING AND TOBACCO USE OF ANY KIND IS PROHIBITED FOR PROJECT DURATION. THE DEMOLITION PLANS AND ELEVATIONS INDICATE THE GENERAL SCOPE AND INTENT OF ITEMS THAT ARE TO BE REMOVED, PATCH AND REPAIR SURFACES OUTSIDE THE LIMITS OF WORK THAT ABANDONED AND/OR REWORKED; HOWEVER, ALL ITEMS AND AREAS MAY NOT BE DEPICTED OR NOTED. IT IS THE RESPONSIBILITY OF THE GENERAL CONTRACTOR TO FULLY COORDINATE DEMOLITION WITH ALL DISCIPLINES AND REMOVE AS REQUIRED AND PATCH BACK AS REQUIRED TO MATCH ADJACENT

AREA(S) THAT MAY NOT BE NOTED. IN BUILDINGS WHICH ARE NOT BEING DEMOLISHIED IN THEIR ENTIRETY; ALL LIFE SAFETY DEVICES, INCLUDING BUT NOT LIMITED TO, FIRE PULLS, SMOKE DETECTORS, HORN/STROBES, SECURITY SYSTEM, ETC SHALL REMAIN IN OPERATION DURING THE DURATION OF DEMOLITION AND NOW WORK. IF ANY INTERUPTION OF ANY LIFE SAFETY DEVISES OR SYSTMES IS REQUIRED BY THE CONTRACTOR DURING ANY SCOPE OF WORK TO BE PERFORMED, THE CONTRACTOR SHALL COORDINATE WITH THE OWNER/ARCHITECT AND RECEIVE APPROBAL PRIOR TO INTERUPTION.

GAS AND WATER SUPPLY LINES, SEWER WASTE LINES, ETC THAT 19. ARE TO BE ABANDONED SHALL BE SEALED, CAPPED, VALVED AND TESTED FOR LEAKS. CONTRCTOR SHALL LOCATE PIPE TERMINATIONS AND VALVES ON AS BUILT DRAWINGS. CONTRACTOR SHALL NOT DISCARD ANY MATERIAL, INCLUDING BUT | 2

NOT LIMITED TO, SOLIDS AND LIQUIDS INTO FLOOR DRAINS, STORM DRAINS/SEWERS. CATCH BASINS, CULVERTS ETC. OTHER THAN POTABLE WATER. IT SHALL BE THE CONTRACTORS RESPONSIBILITY TO MAINTAIN A CLEAR AND FUNCTIONING DRAINAGE/SANITARY SEWER SYSTEM. ALL CODES AND OWNER REGULATIONS AND REQUIREMENTS CONCERNING SITE AND BUILDING MEANS OF ACCESS AND EGRESS SHALL BE OBSERVED AND FOLLOWED BY THE CONTRACTOR AND SUB CONTRACTORS. VEHICLES USED BY ALL CONTRACTORS AND SUPPLIERS SHALL NOT BLOCK OWNERS BUILDING OR ADJACENT BUILDINGS, ACCESS DRIVES, EMERGENCY FIRE LANES, DROP OFF AND PICK UP ZONES ETC. ALL CONTRACTOR VEHICLES, IF PARKED ON PROJECT SITE, SHALL BE PARKED IN AN OWNER APPROVED LOCATION.

OWNER TOILET FACILITES AND DRINKING FOUNTAINS SHALL NOT BE USED BY ANY CONTRACTOR, SUB CONTRACTOR, VENDOR, SUPPLIER ETC. GENERAL CONTRACTOR IS RESPONSIBLE FOR PROVIDING ADEQUARE FACILITES. IN ADJACENT SPACES TO ROOMS WHERE WORK IS TO BE PERFORMED INCLUDING ABOVE THE CEILING AND OR ROOF WORK

THE CONTRACTOR SHALL COVER WITH VISQUEEN THE FOLLOWING, BUT NOT LIMITED TO, EQUIPMENT, COUNTER TOPS, OPEN CONTAINERS, FURNITURE, FILES ETC. WHICH MAY CATCH OR BE DAMAGED BY FALLING DUST AND OR DEBRIS. TEMPORARY PROTECTION AND APPLICABLE WARNING SIGNS SHALL BE POSTED BY THE CONTRACTOR AT WORK AREA(S) TO ENSURE THE SAFETY OF EMPLOYEES, GENERAL PUBLIC AND CONTRACTORS. THESE PROTECTIVE MEASURES AND SIGNAGE SHALL BE IN PLACE AT ANY WORK AREA WHEN EQUIPMENT, TOOLS, AND MATERIALS ARE PRESENT AND/OR WHEN WORKERS MAY NEED

TO OBSTRUCT THE NORMAL ACCESS-EGRESS OF THE PROJECT SITE OR FACILITY INCLUDING INTERIOR SPACES. SEE MECHANICAL, PLUMBING, ELECTRICAL, CIVIL AND STRUCTURAL FOR ADDITIONAL DEMOLITION INFORMATION AND REQUIREMENTS. SEE DEOMOLITON PARTS PLAN FOR KEY PLAN NOTES AND ADDITIONAL DEMOLITION INFORMATIN.

RCP DEMOLITION KEY NOTES

- DEMOLISH LAY IN ACOUSTICAL CEILING SYSTEM. INCLUDING BUT NOT LIMITED TO ACOUSTICAL SUSPENSION SYSTEM MAIN BEAM, CROSS TEE, ANGLE MOLDING, ETC.
- NOT USED. DEMOLISH CERAMIC CEILING TILE ON METAL LATH IN ITS
- ENTIRETY. DEMOLISH LIGHT FIXTURES. SEE ELECTRICAL DRAWINGS
- FOR EXTENT AND DEMOLITION REQUIREMENTS. DEMOLISH GYP BD CEILING IN ITS ENTIRETY, INCLUDING BUT NOT LIMITED TO SUSPENSION SYSTEM, HANGER WIRE,

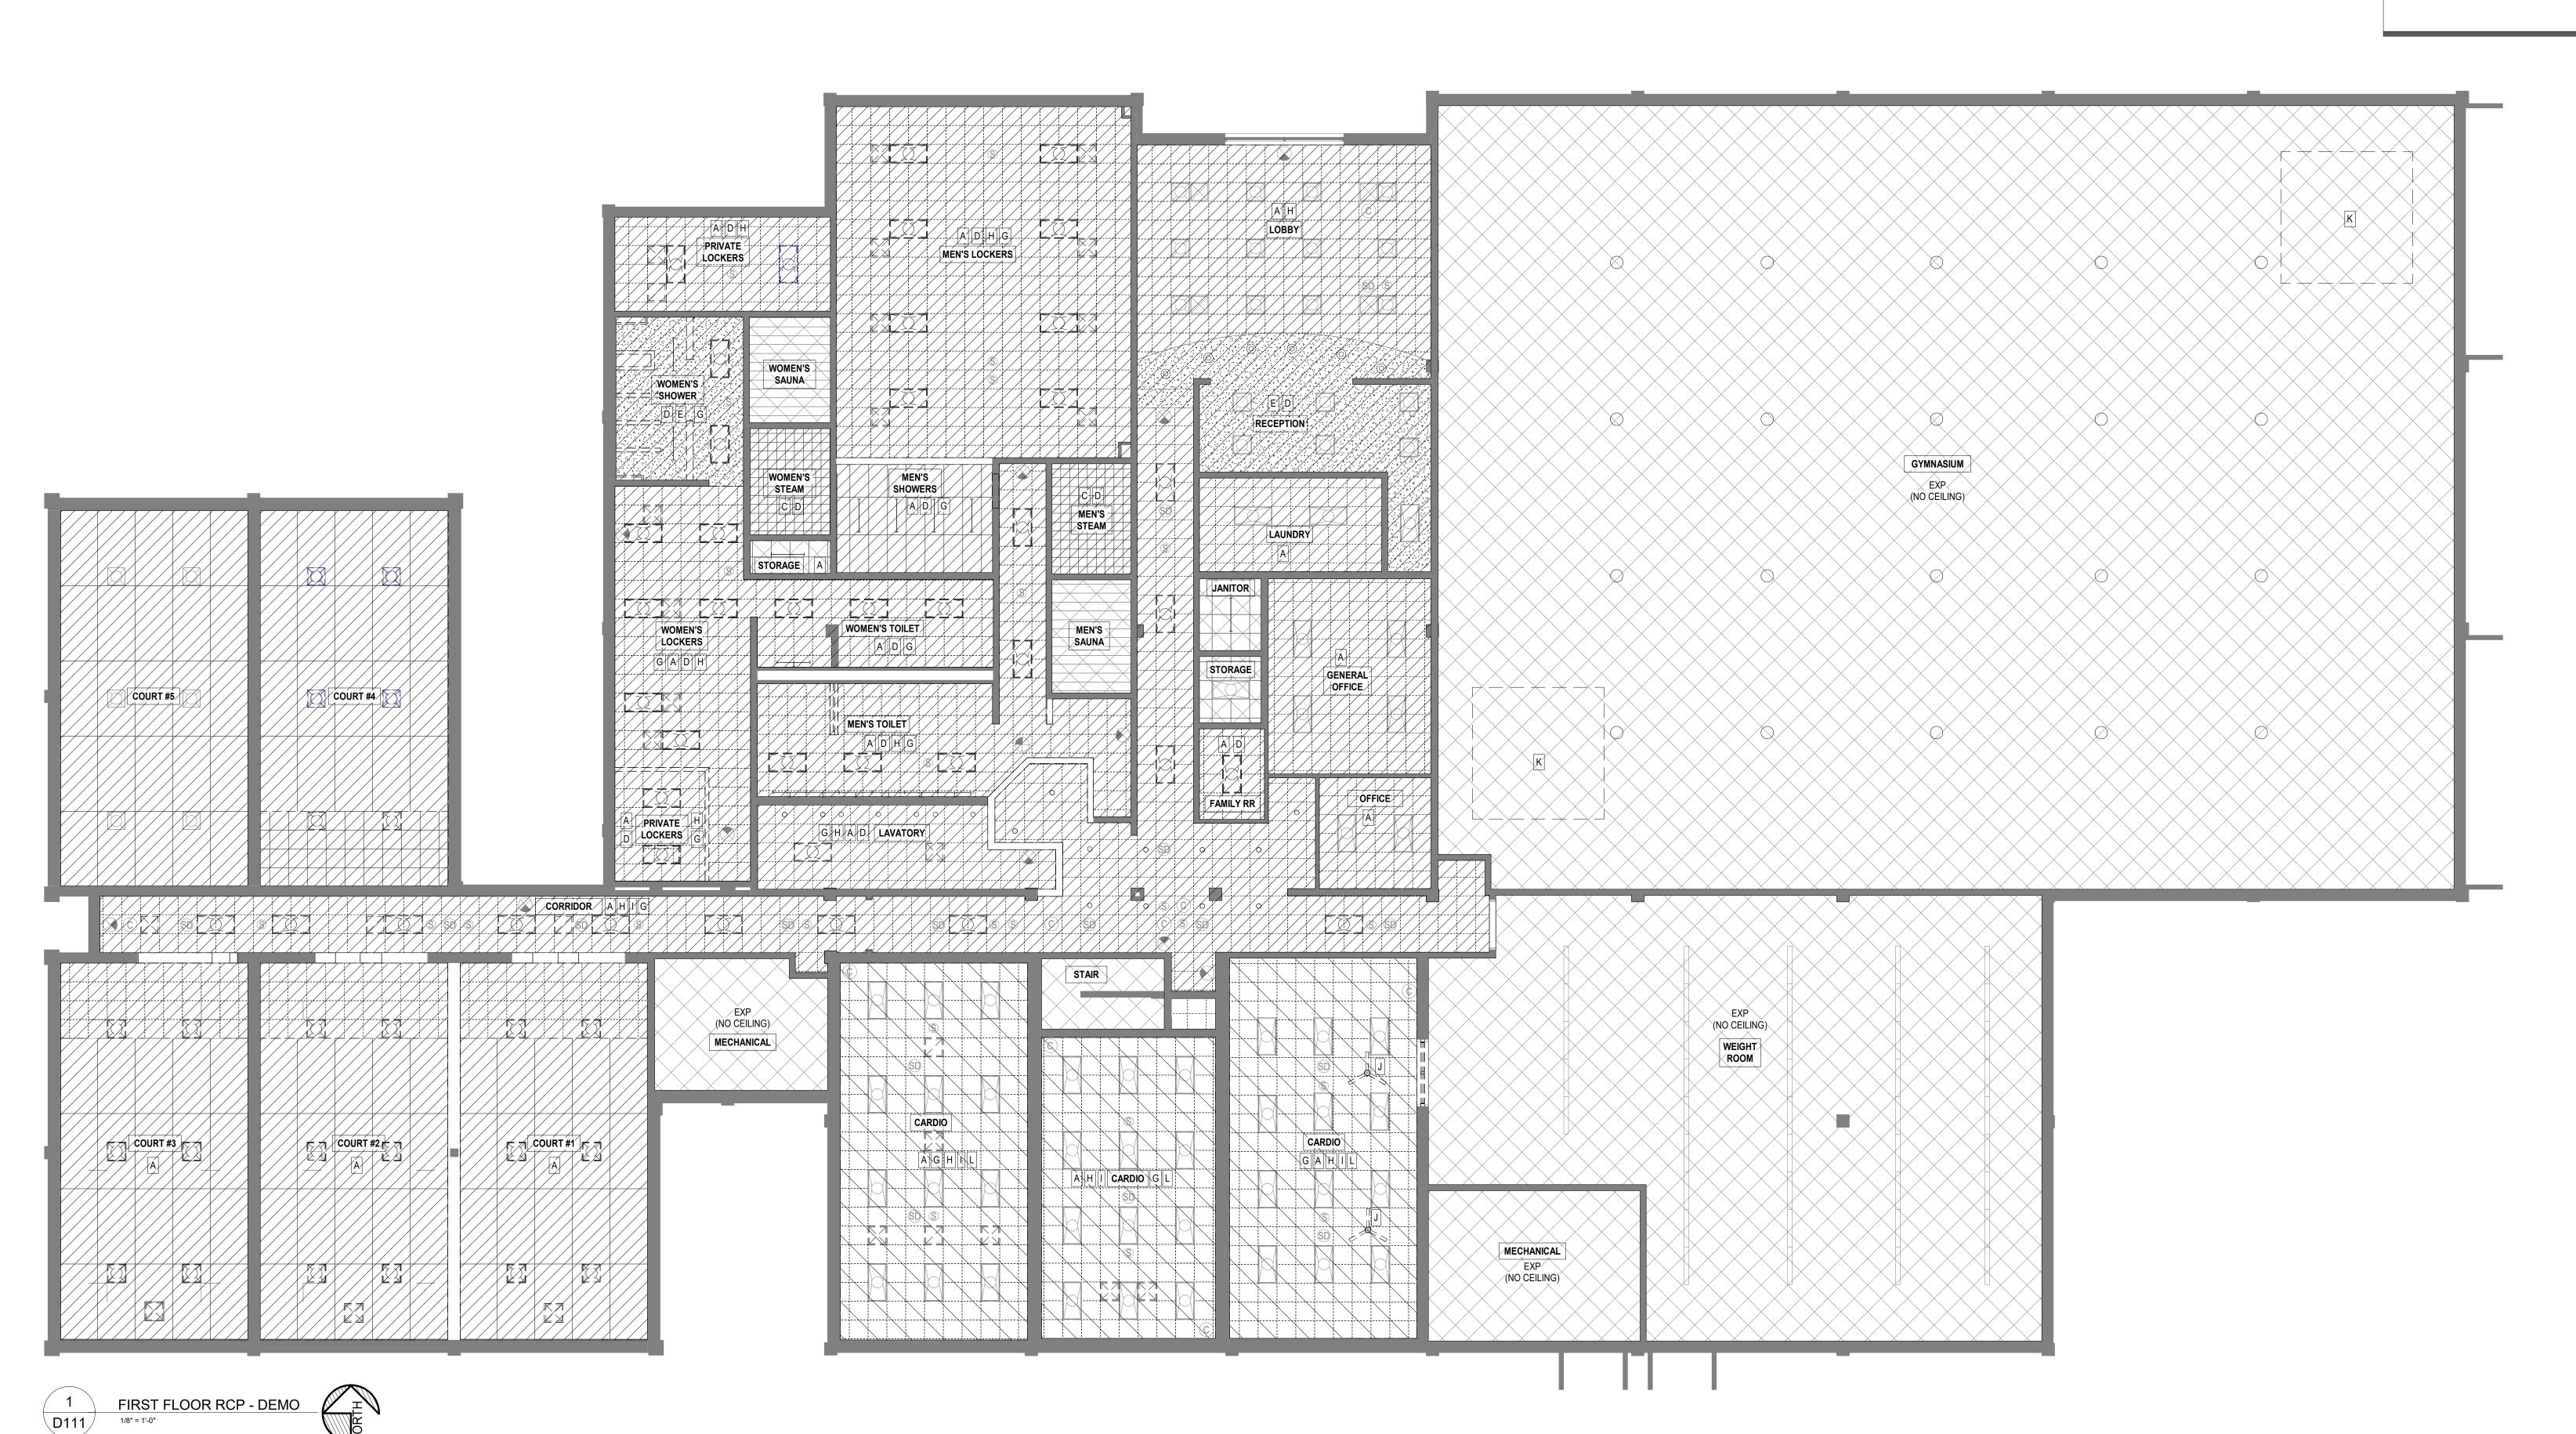
REMOVE. STORE AND INSTALL BACK IN PLACE ANY HVAC SUPPLY AND RETURN GRILLES IN THE WAY TO ACCESS AND COMPLETE WORK INCLUDED IN THIS AREA. ALL ASSOCIATED DUCT WORK, UNITS, POWER, CONDENSATE LINE AND CONTROL WIRING TO REMAIN IN TACT. SEE MECHANICAL DRAWINGS FOR ADDITIONAL REQUIREMENTS.

DEMOLISH HVAC SUPPLY AND RETURN GRILLES, ALL ASSOCIATED DUCT WORK, UNITS, POWER, CONDENSATE LINE AND CONTROL WIRING IN ITS ENTIRETY. SEE MECHANCIAL DRAWINGS FOR EXTENT AND AND DEMOLITION REQUIREMENTS.

REMOVE, UNINSTALL, STORE, AND INSTALL BACK IN PLACE ANY SPEAKERS, CAMERAS, EXIT SIGNS OR OTHER CEILING MOUNTED DEVICE IN THE WAY TO ACCESS AND COMPLETE WORK INCLUDED IN THIS AREA. SEE ELECTRICAL DWGS FOR ADDITIONAL INFORMATION.

DISCONNECT SMOKE DETECTORS AND REINSTALL PROMPTLY AFTER CEILING SYSTEM IS REMOVED. DISRUPTION OF THE SMOKE DETECTION SYSTEM AND LIFE SAFETY SYSTEM SHALL BE AT A MINIMUM, DISRUPTION OF THESE SYSTEM SHALL BE COORDINATED BY THE CONTRACTOR WITH THE OWNER AND THE CONTRACTOR SHALL RECEIVE APPROVAL FROM THE OWNER/ARCHITECT PRIOR DISRUPTION. SEE ELECTRICAL DWGS FOR ADDITIONAL REQUIREMENTS.

- DEMOLISH CEILING FAN IN ITS ENTIRETY.
- CONTRACTOR TO DEMOLISH STEEL MECHANICAL PLATFORM IN ITS ENTIRETY. SEE MECHANICAL DRAWINGS FOR ADDITIONAL INFORMATION.
- DEMOLISH EXISTING GYPSUM BOARD CEILING ABOVE LAY IN CEILING IN ITS ENTIRETY.





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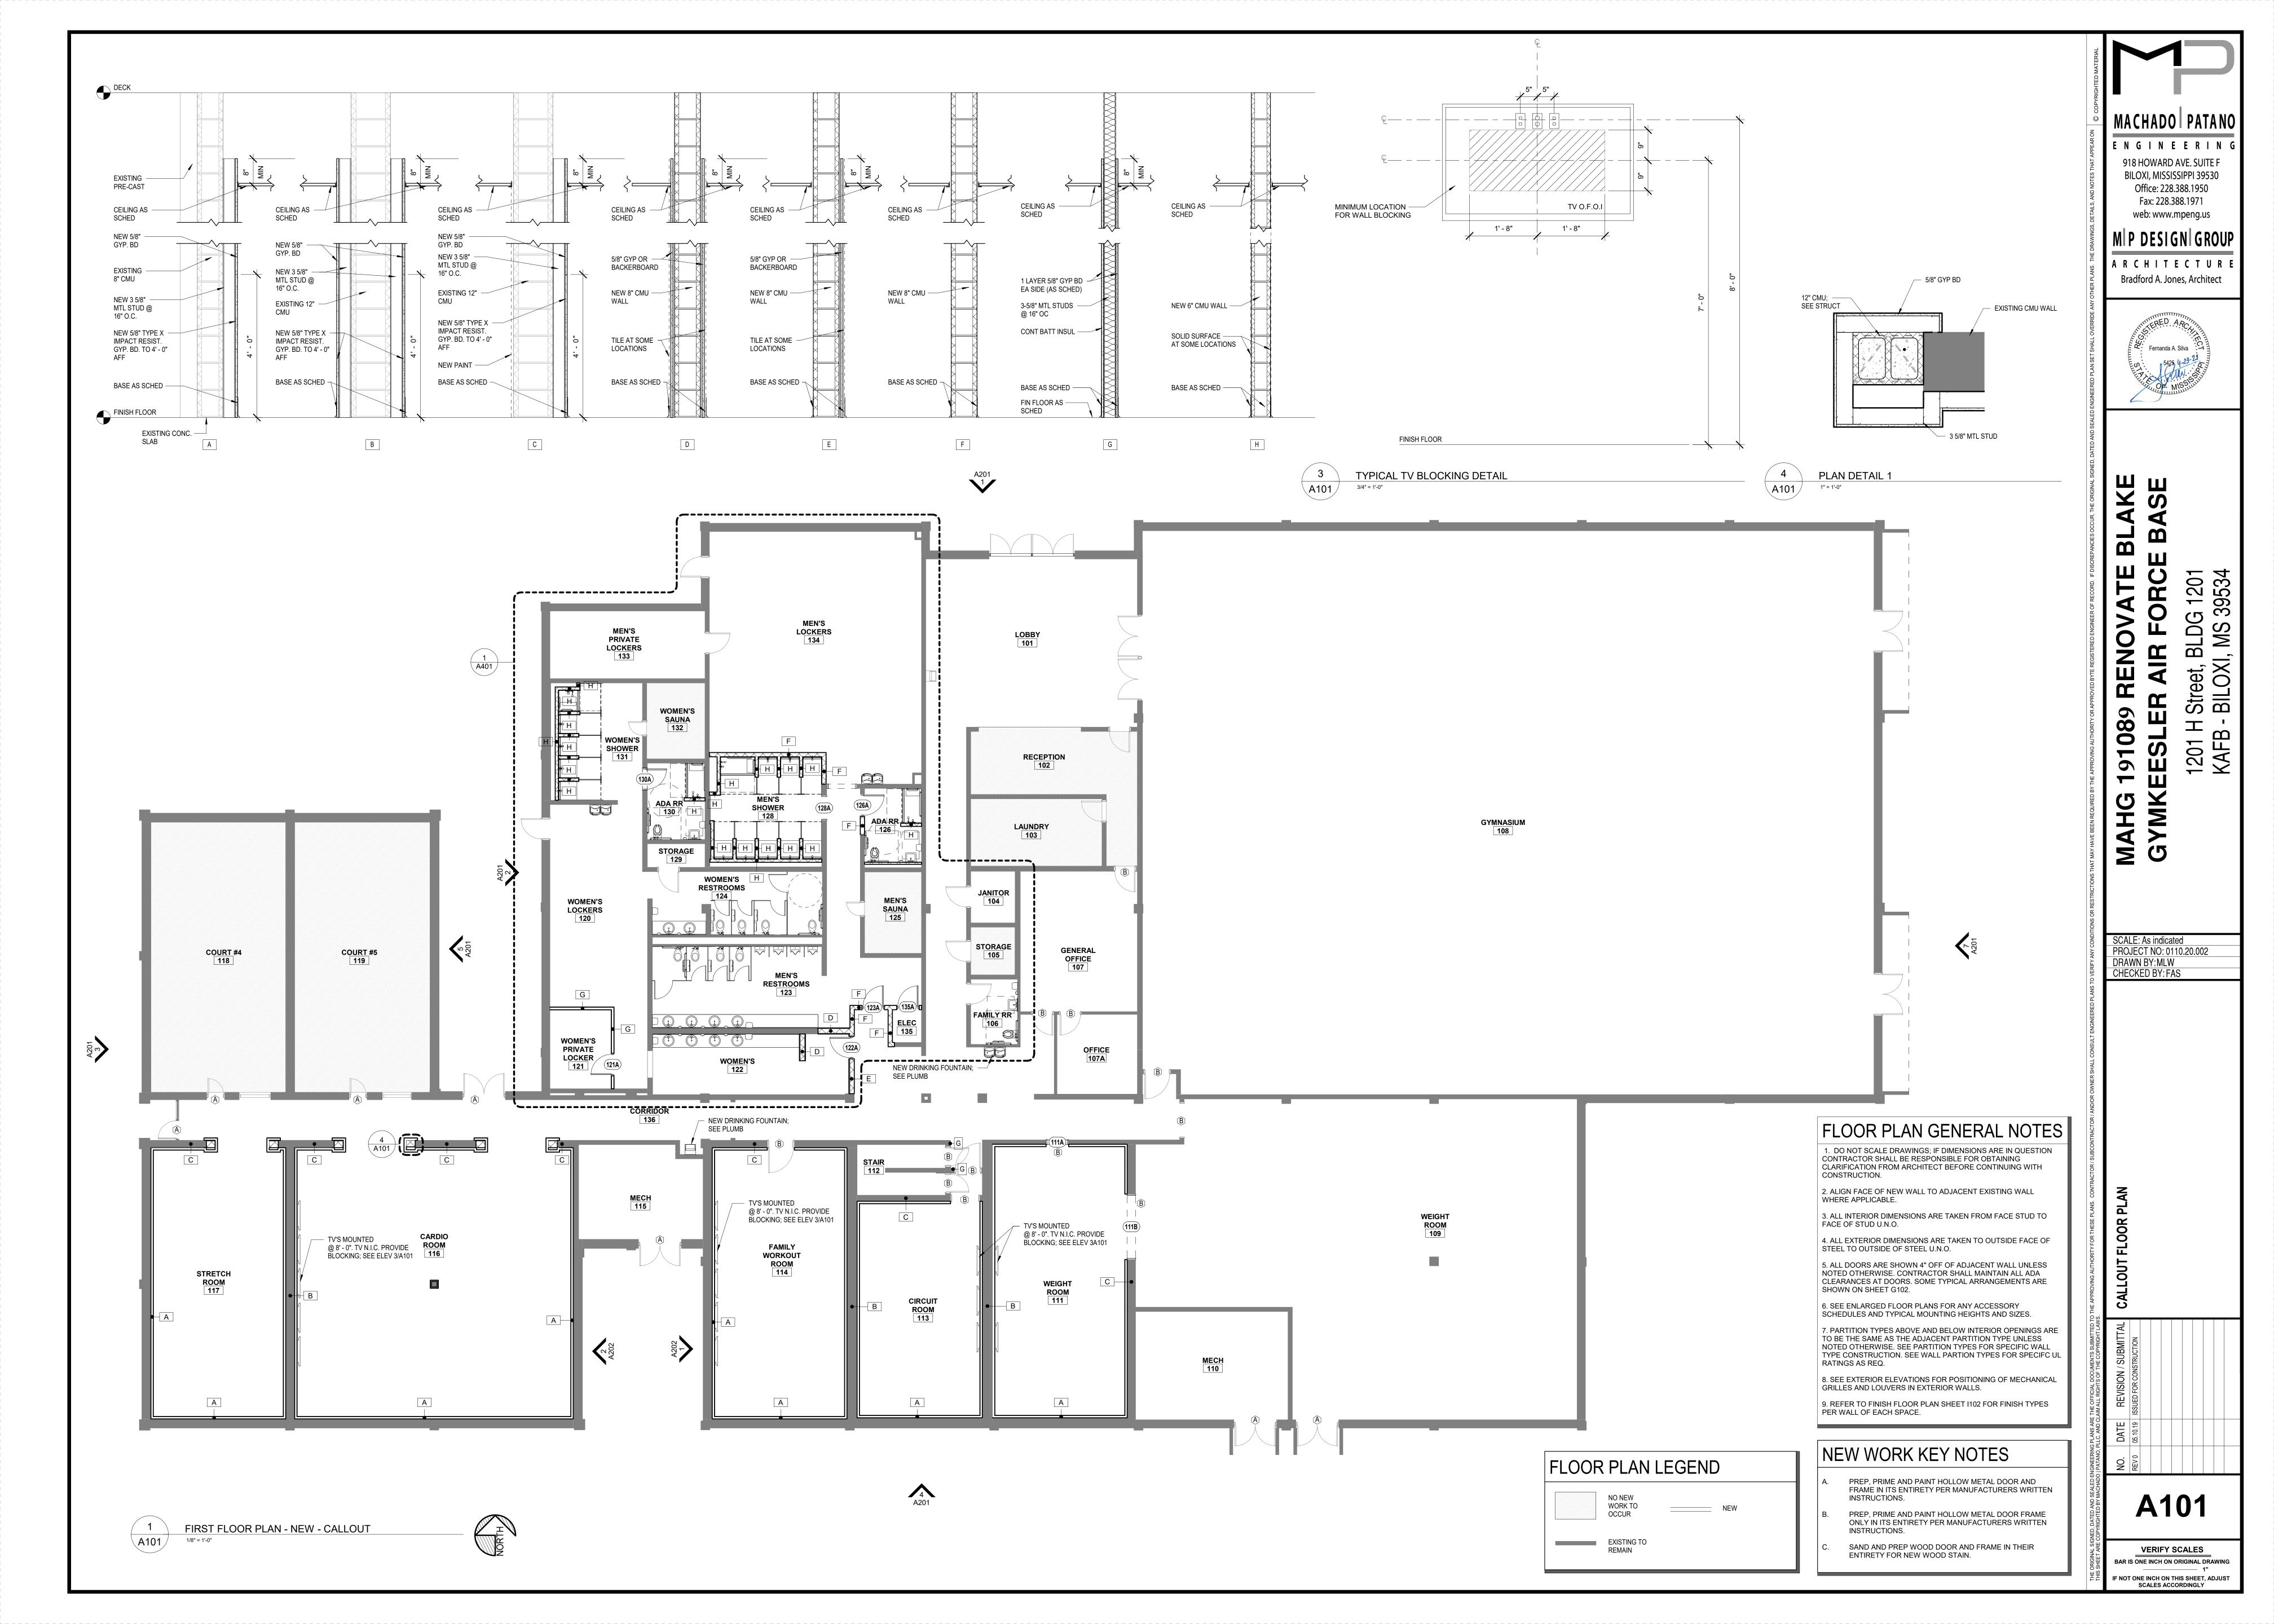
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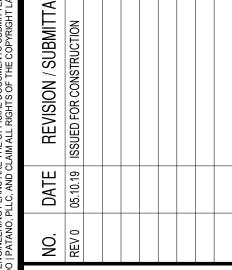
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ARCHITECTURE Bradford A. Jones, Architect




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PROJECT NO: 0110.20.002
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M|P DESIGN|GROUP

ARCHITECTUR Bradford A. Jones, Architect




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SCALE: As indicated PROJECT NO: 0110.20.002
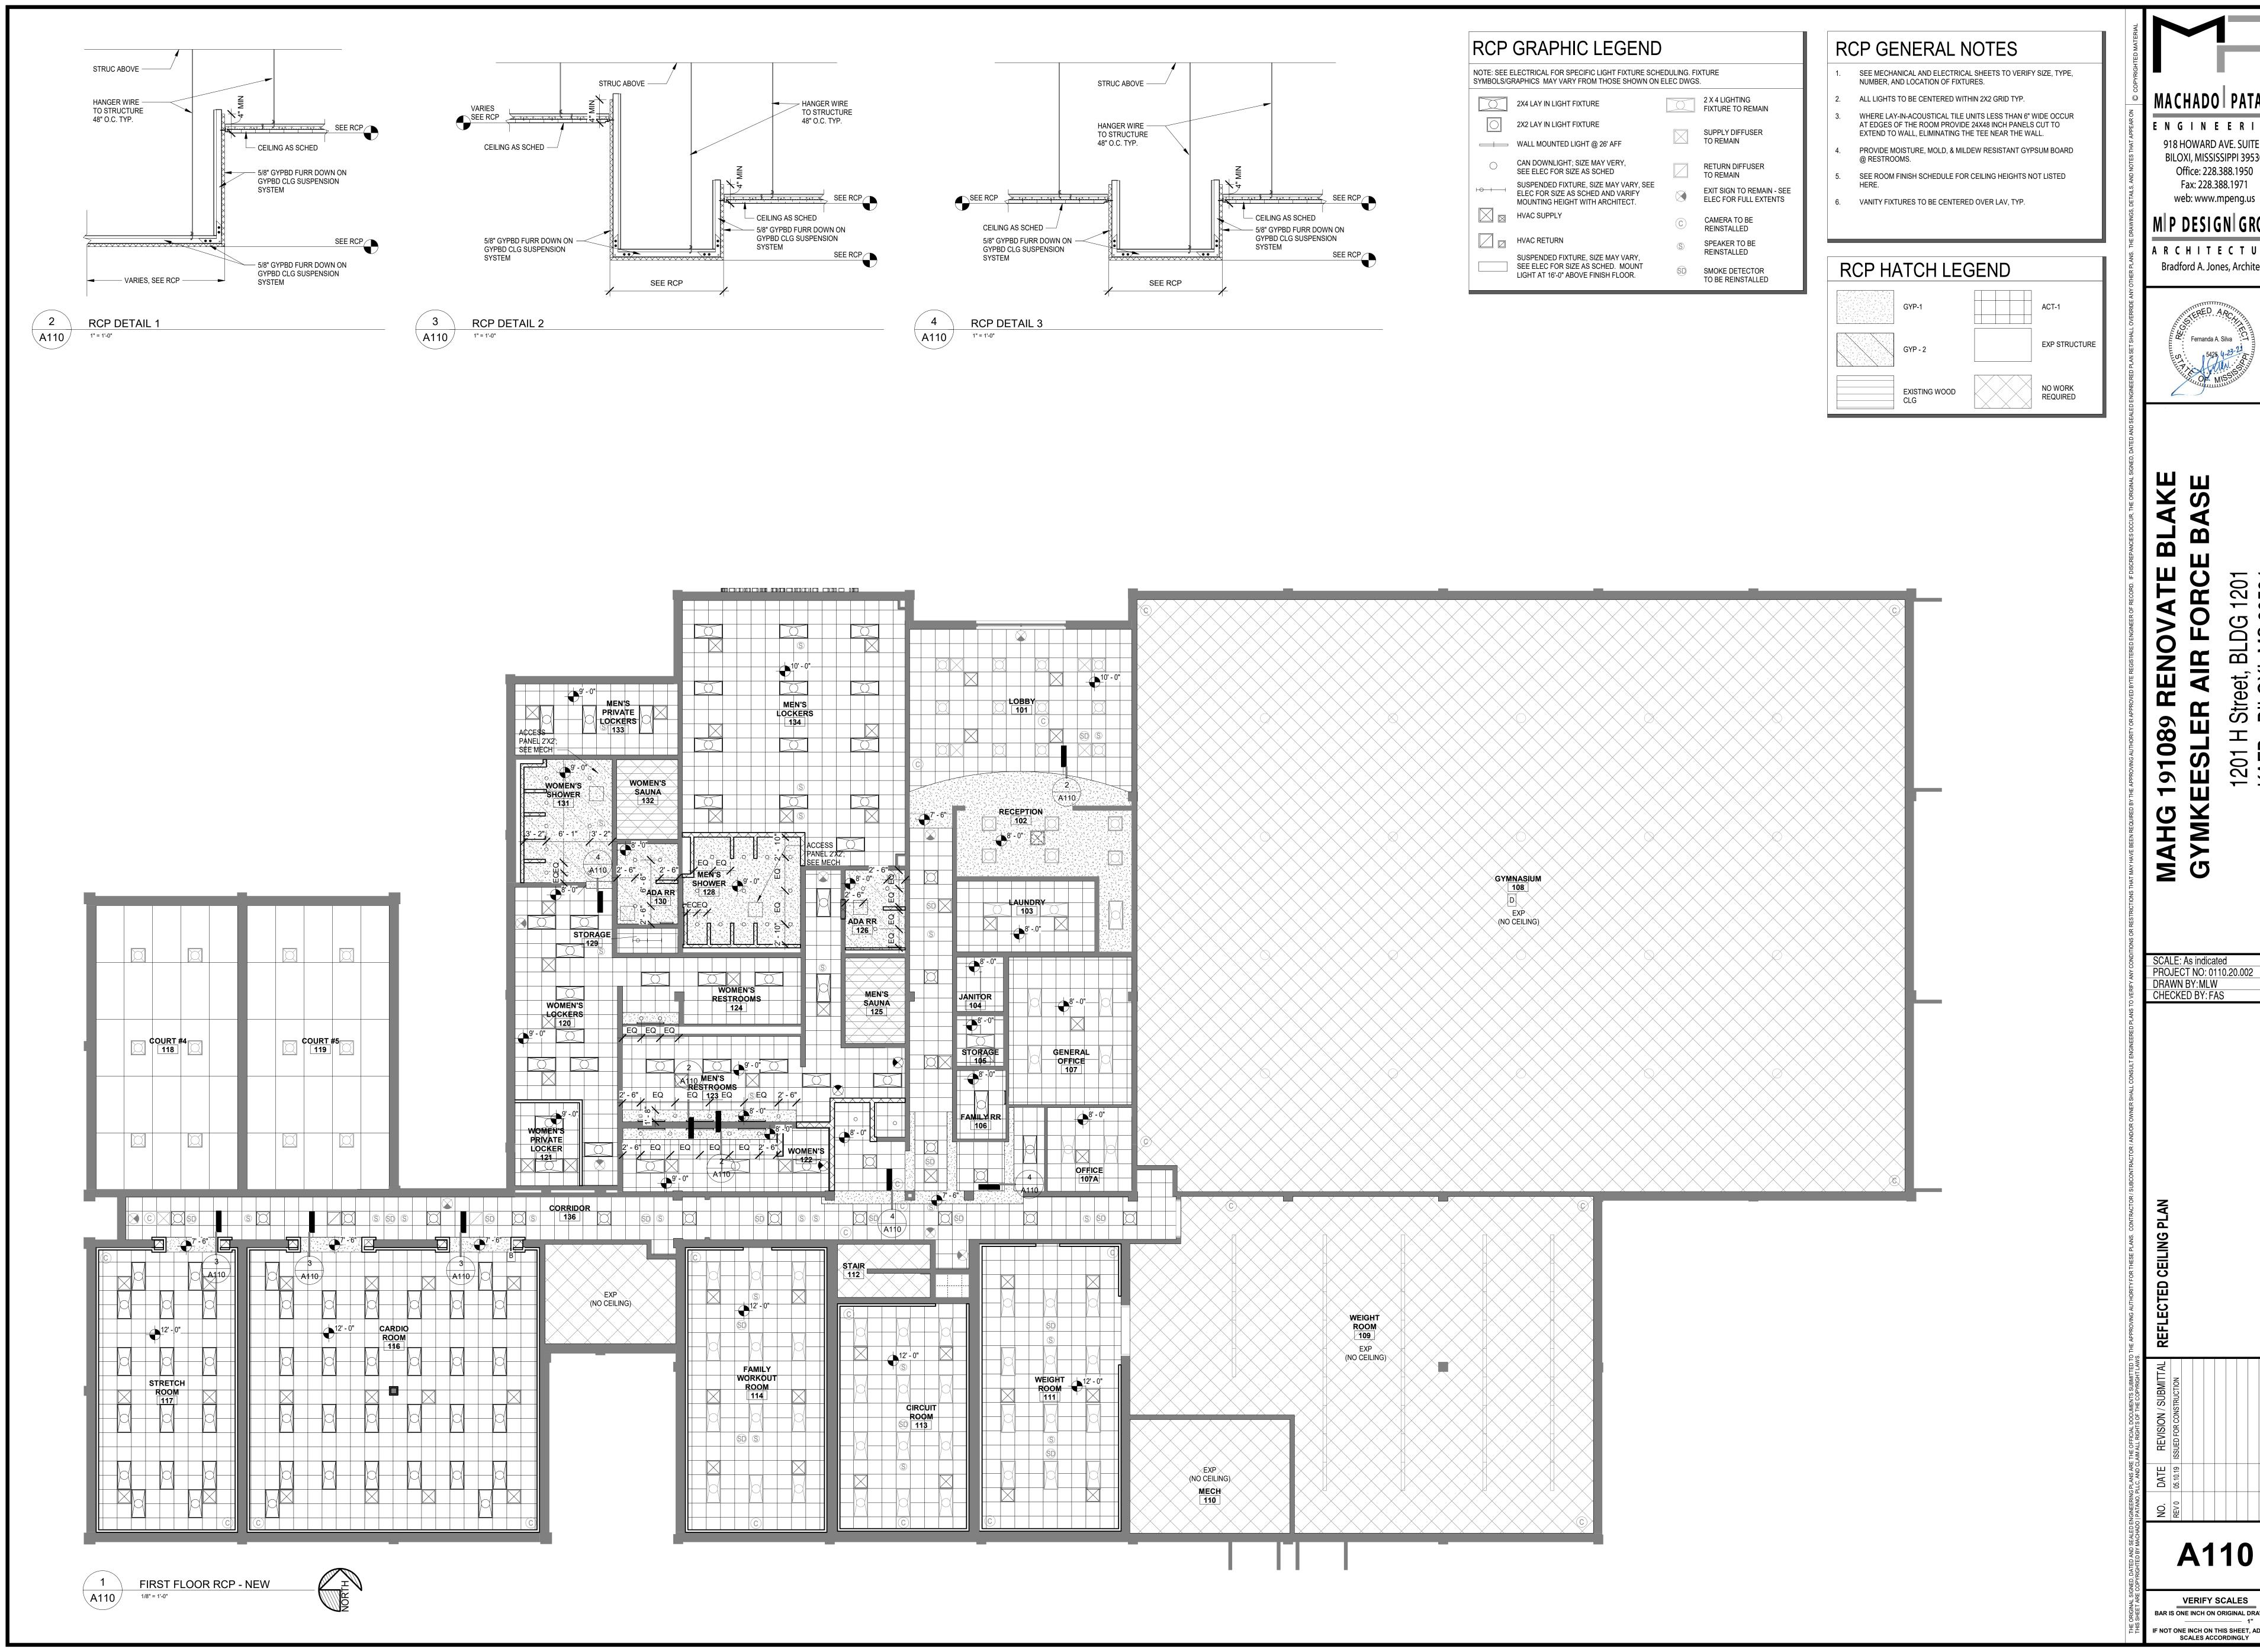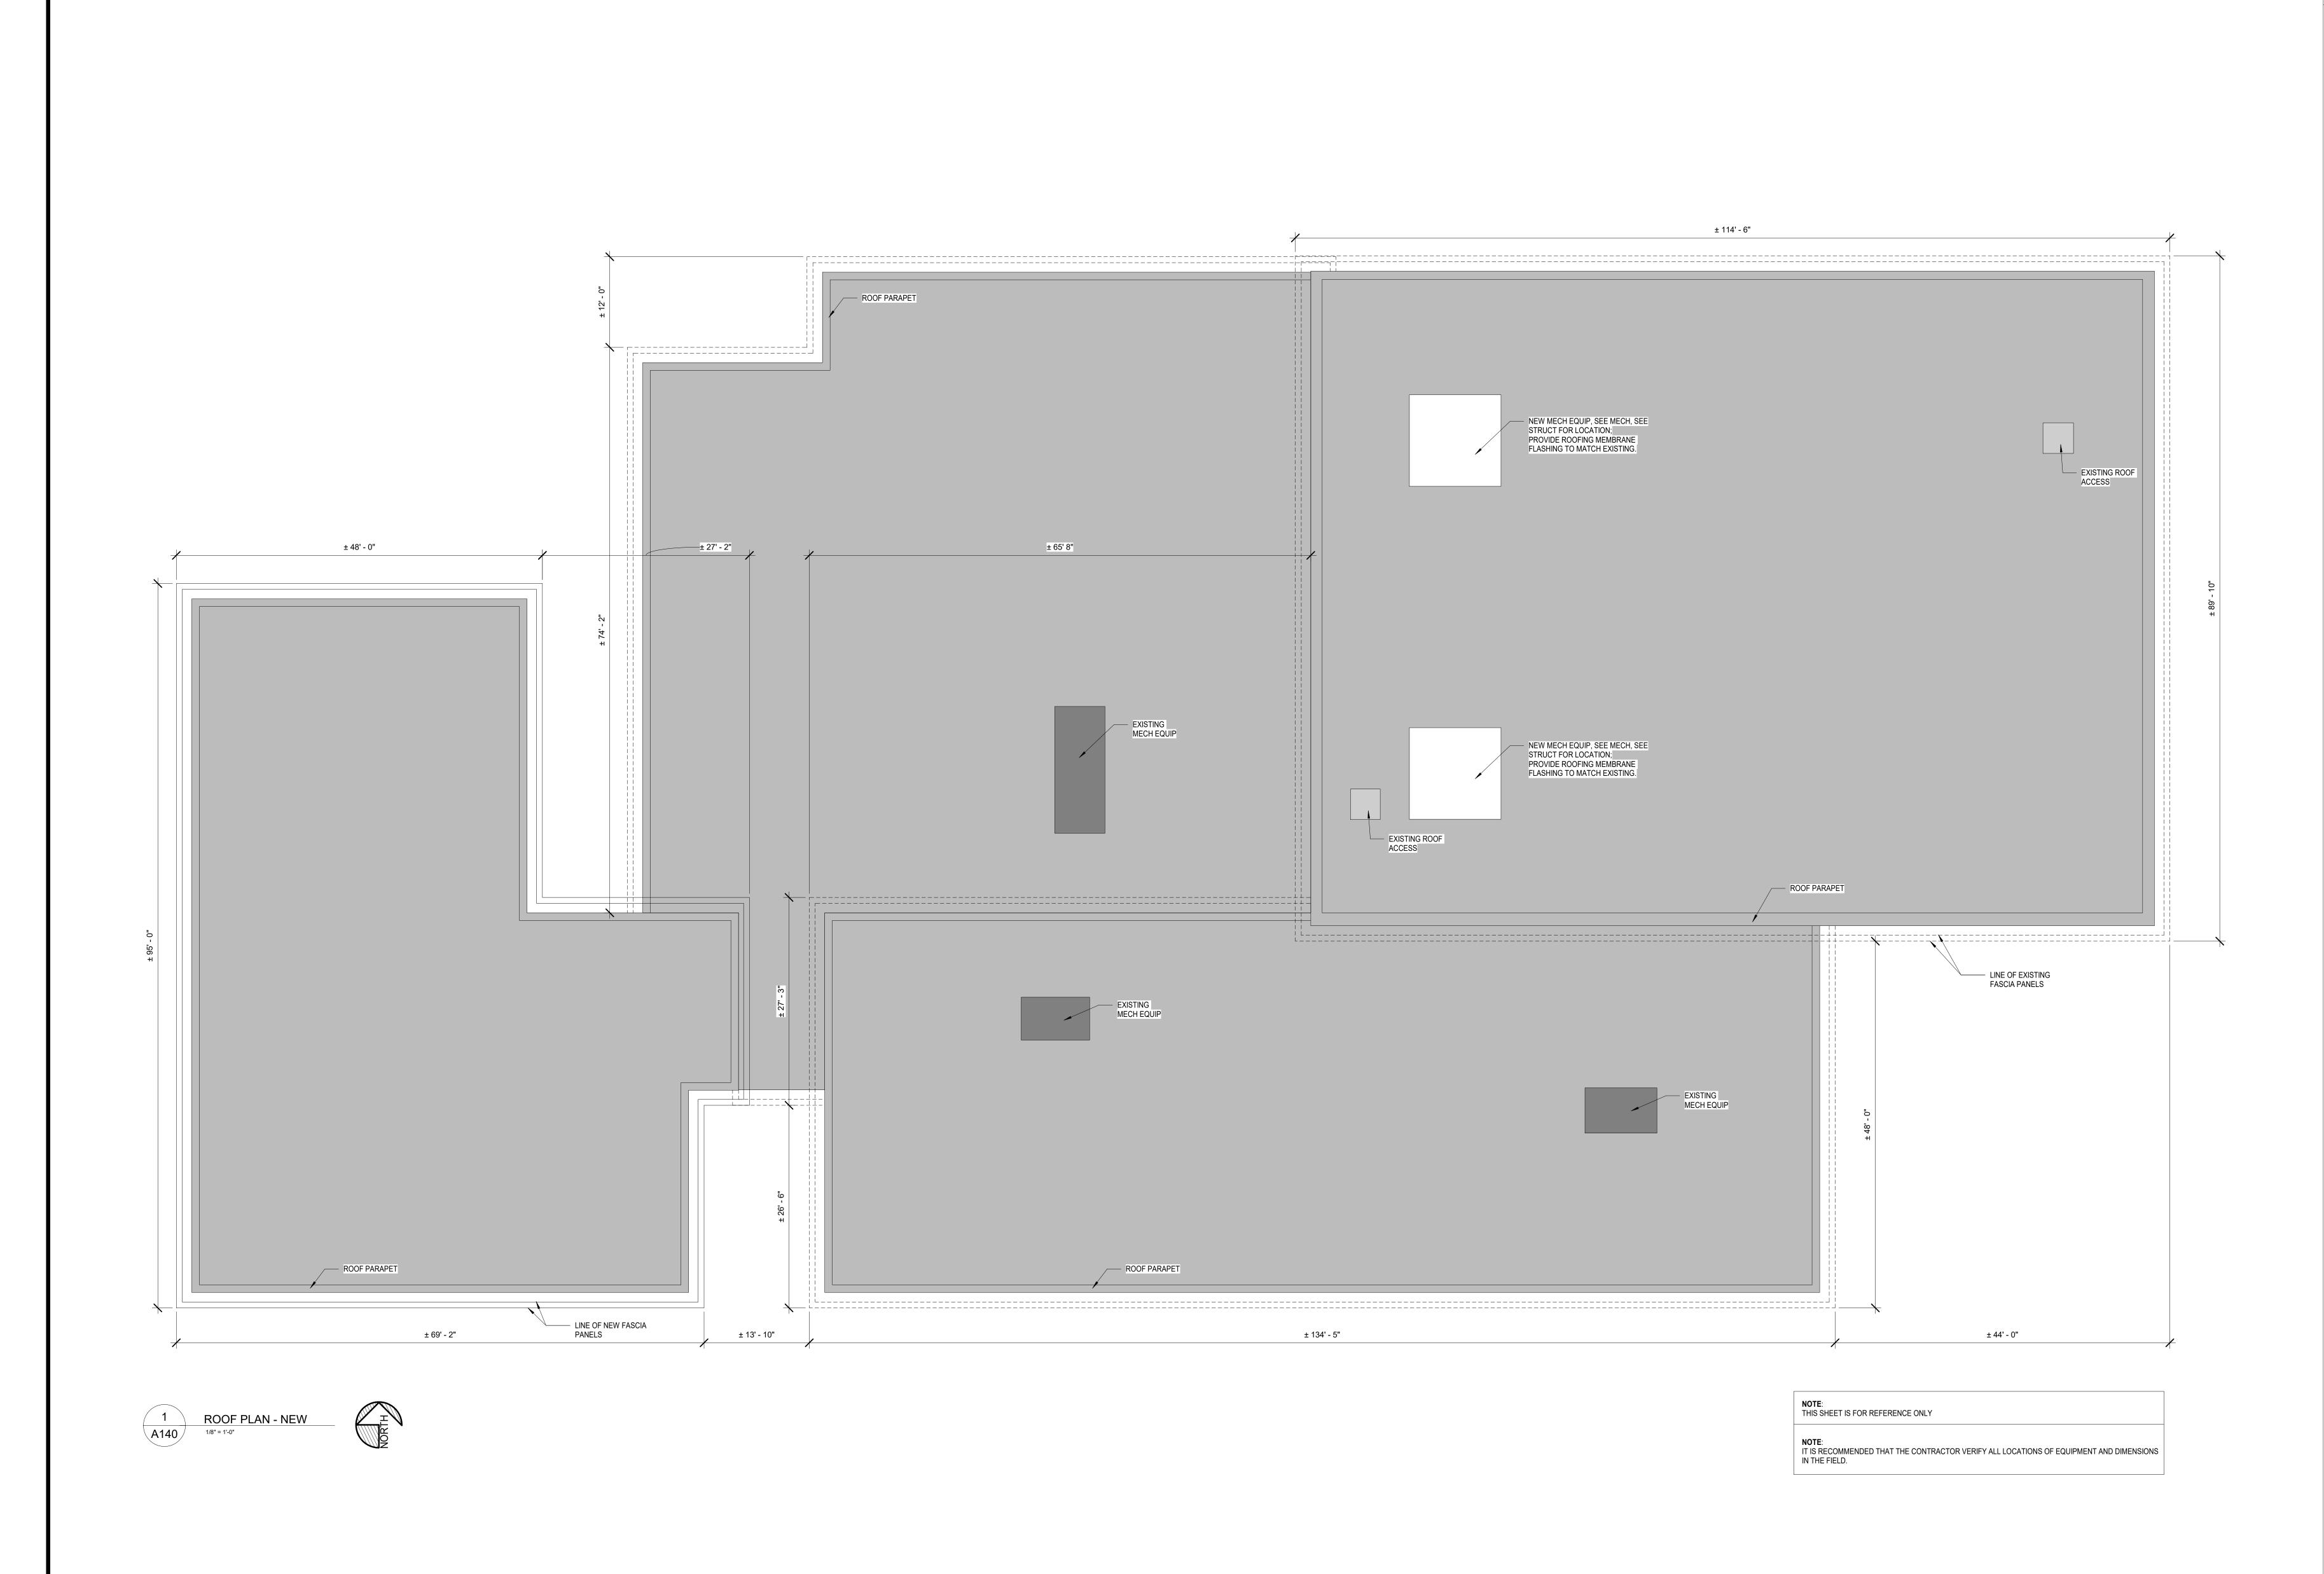
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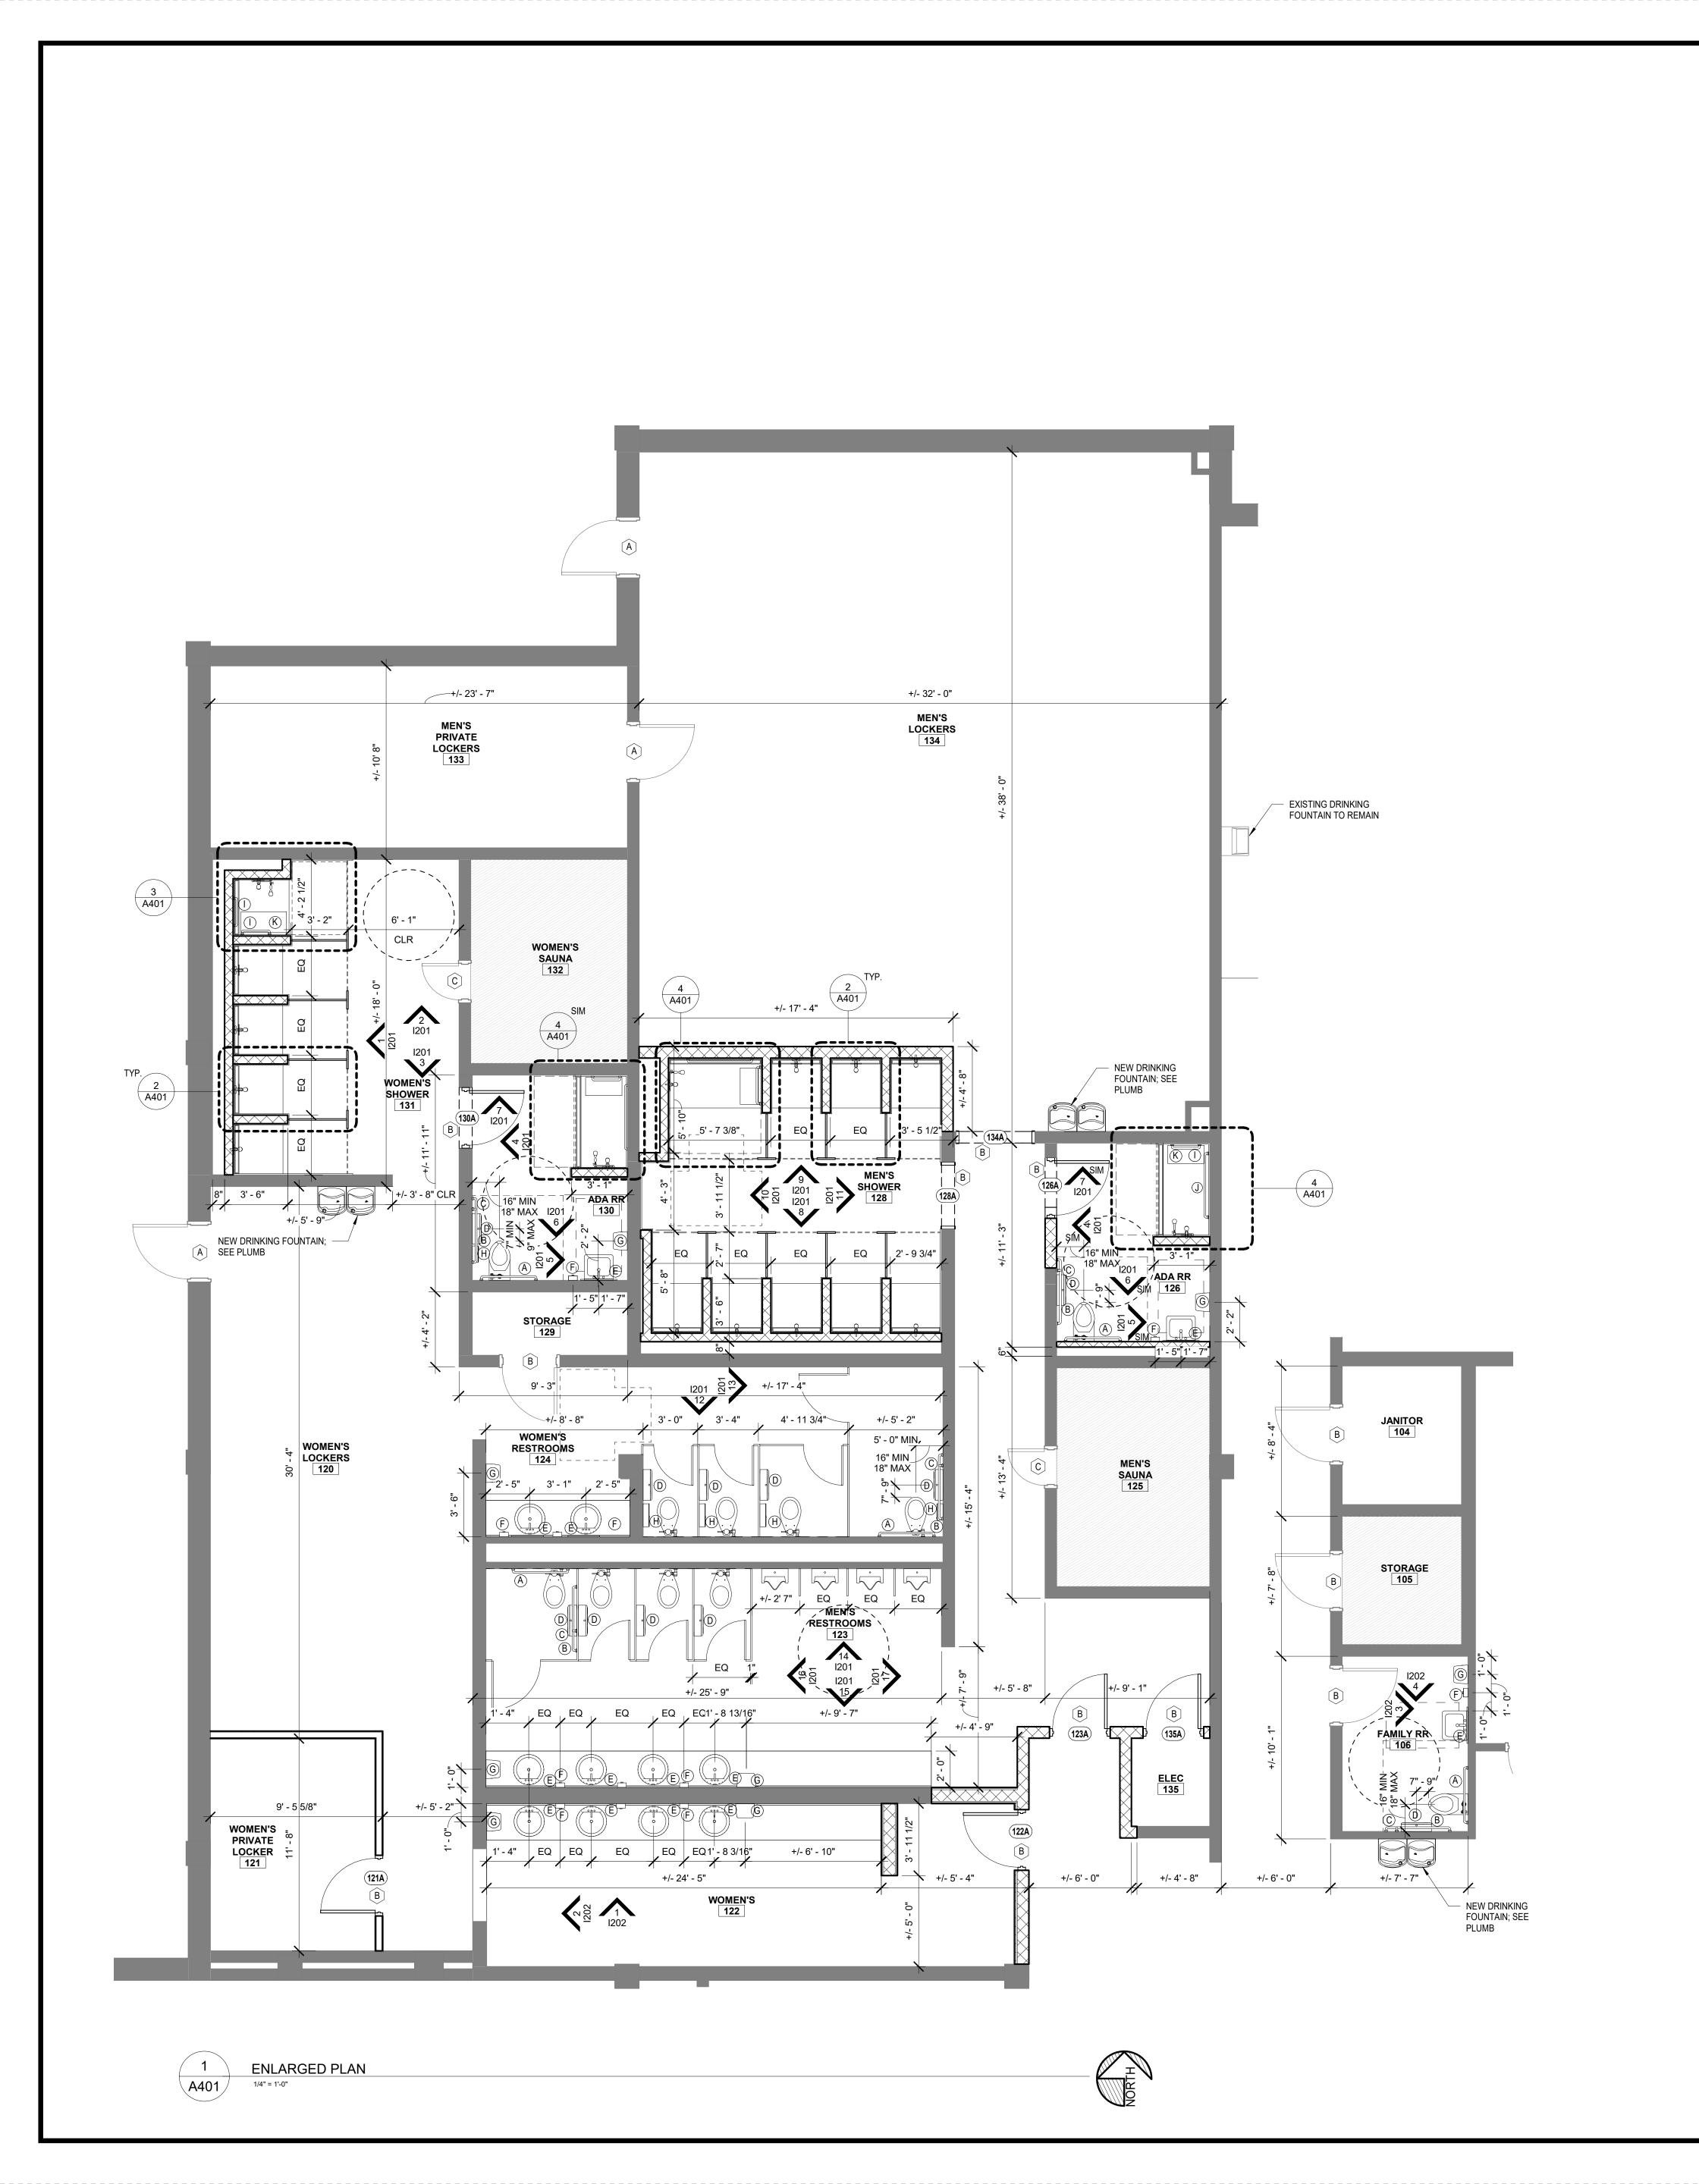


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ENLARGED RR NOTES


1. ALL DIMENSIONS ARE TAKEN FROM FINISHED SURFACE OF WALL TO CENTER OF FIXTURE UNLESS NOTED OTHERWISE. 2. ADA TOILET PARTITION STALL DOORS MUST HAVE CLEAR OPENING OF 32" MINIMUM. 3. SEE SHEET G102 FOR GENERAL ADA CLEARANCES AND REQUIREMENTS.

RESTROOM ACCESSORY SCHEDULE


TRECTITOOM / ROOLOGOTT COTTEDOLE					
SYMBOL	ACCESSORY	MOUNTING HEIGHT	NOTES		
A	36" GRAB BAR (REAR OF WC)	33" - 36" AFF	1		
B	42" GRAB BAR (SIDE OF WC)	33" - 36" AFF	1		
C	18" VERTICAL GRAB BAR	39" - 41" AFF TO CL OF ATTACHMENT	1, 3		
D	TOILET TISSUE DISPENSER	18" MIN AFF MAX TO BOTTOM OF TISSUE	1		
E	MIRROR 18" X 36"	40" AFF MAX TO REFLECTIVE SURFACE	2		
F	SOAP DISPENSER	44"-48" MAX TO OPERABLE PART	1		
G	PAPER TOWEL DISPENSER	WALL MOUNTED; 44"-48" MAX TO TOWEL DISPENSER	1		
H	SANITARY NAPKIN DISPOSAL	AS REQUIRED PER MANUFACTURER	1		
	18" SHOWER GRAB BAR	33" MIN - 36" MAX TO GRIPPING SURFACE	1		
J	42" SHOWER GRAB BAR	33" MIN - 36" MAX TO GRIPPING SURFACE	1		
K	32" x 16" ADA SHOWER BENCH	AS REQUIRED PER MANUFACTURER	1		
L	MIRROR 36" X 72"	40" AFF MAX TO REFLECTIVE SURFACE	1		

ACCESSORY NOTES

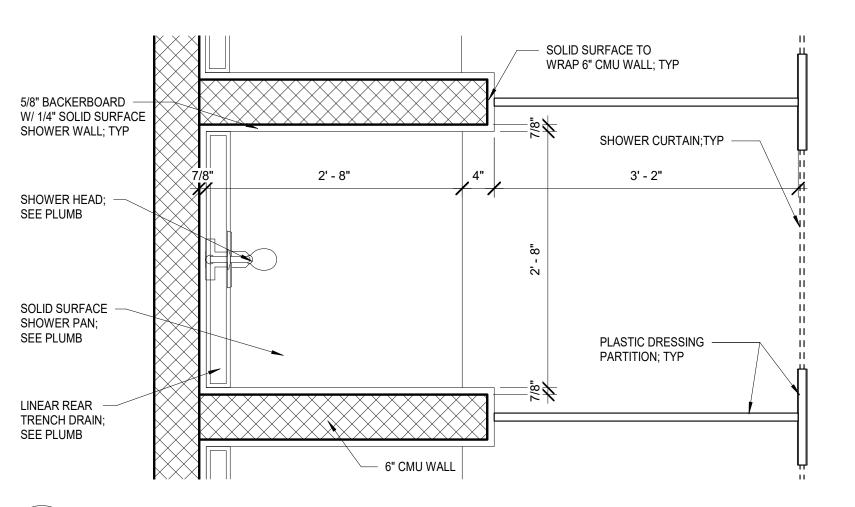
1. FIELD VERIFY MOUNTING HEIGHTS WITH ARCHITECT BEFORE INSTALLATION. ALL MOUNTING HEIGHTS SHALL COMPLY WITH ADA REQUIREMENTS & MANUFACTURER RECOMMENDATIONS. 2. ATTACH MIRROR PER MANUFACTURER RECOMMENDATIONS. CENTER MIRROR WITH LAVATORY OR LAVATORY UNIT BELOW. 3. MOUNTING HEIGHT DIMENSION IS TO THE CENTER LINE OF THE BOTTOM ATTACHMENT.



TYPICAL 32" SHOWER UNIT

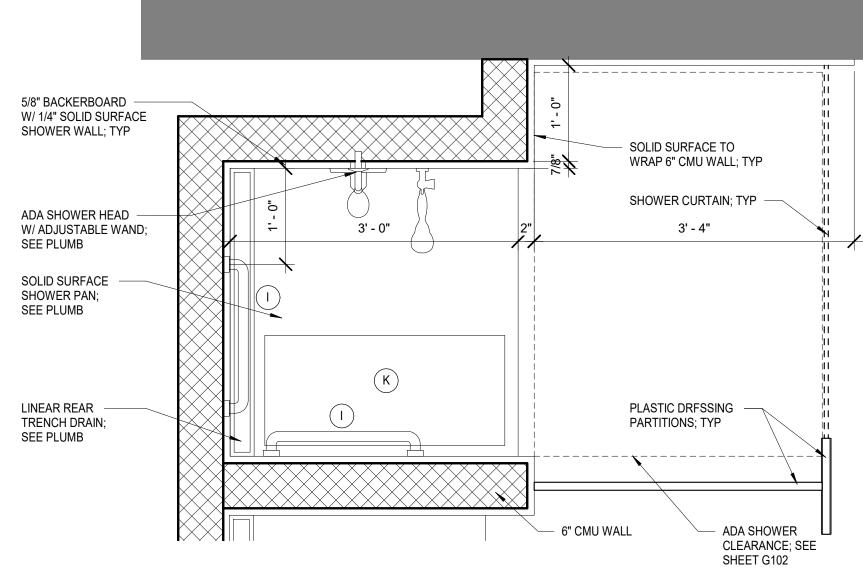

TYPICAL 36" ADA SHOWER UNIT

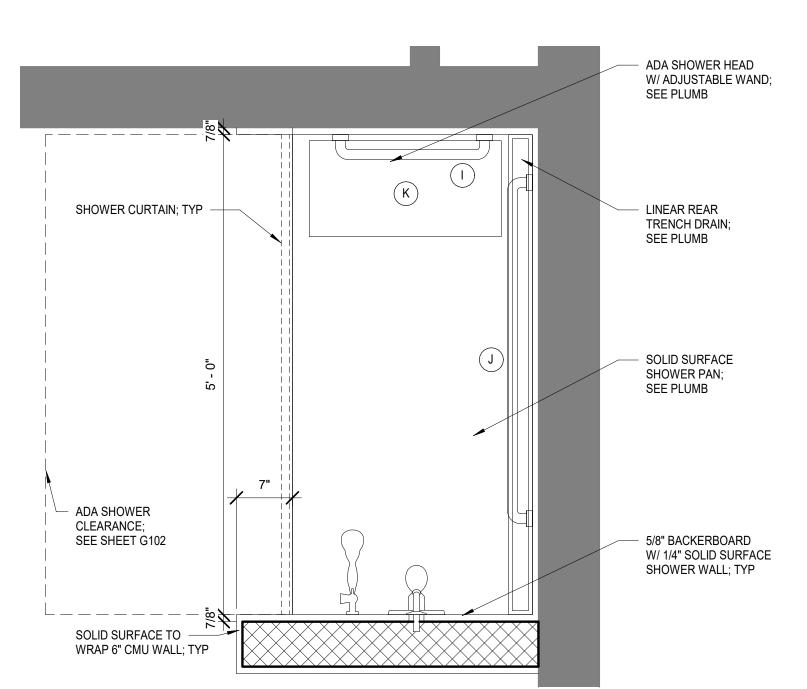

TYPICAL 30" X 60" ADA SHOWER UNIT

FLOOR PLAN GENERAL NOTES

1. DO NOT SCALE DRAWINGS; IF DIMENSIONS ARE IN QUESTION

CONTRACTOR SHALL BE RESPONSIBLE FOR OBTAINING CLARIFICATION FROM ARCHITECT BEFORE CONTINUING WITH CONSTRUCTION.

2. ALIGN FACE OF NEW WALL TO ADJACENT EXISTING WALL WHERE APPLICABLE.

3. ALL INTERIOR DIMENSIONS ARE TAKEN FROM FACE STUD TO

FACE OF STUD U.N.O. 4. ALL EXTERIOR DIMENSIONS ARE TAKEN TO OUTSIDE FACE OF STEEL TO OUTSIDE OF STEEL U.N.O.

5. ALL DOORS ARE SHOWN 4" OFF OF ADJACENT WALL UNLESS NOTED OTHERWISE. CONTRACTOR SHALL MAINTAIN ALL ADA CLEARANCES AT DOORS. SOME TYPICAL ARRANGEMENTS ARE SHOWN ON SHEET G102.

6. SEE ENLARGED FLOOR PLANS FOR ANY ACCESSORY SCHEDULES AND TYPICAL MOUNTING HEIGHTS AND SIZES. 7. PARTITION TYPES ABOVE AND BELOW INTERIOR OPENINGS ARE TO BE THE SAME AS THE ADJACENT PARTITION TYPE UNLESS NOTED OTHERWISE. SEE PARTITION TYPES FOR SPECIFIC WALL TYPE CONSTRUCTION. SEE WALL PARTION TYPES FOR SPECIFC UL

8. SEE EXTERIOR ELEVATIONS FOR POSITIONING OF MECHANICAL GRILLES AND LOUVERS IN EXTERIOR WALLS. 9. REFER TO FINISH FLOOR PLAN SHEET I102 FOR FINISH TYPES

NEW WORK KEY NOTES

RATINGS AS REQ.

PER WALL OF EACH SPACE.

PREP, PRIME AND PAINT HOLLOW METAL DOOR AND FRAME IN ITS ENTIRETY PER MANUFACTURERS WRITTEN INSTRUCTIONS.

PREP, PRIME AND PAINT HOLLOW METAL DOOR FRAME ONLY IN ITS ENTIRETY PER MANUFACTURERS WRITTEN INSTRUCTIONS.

SAND AND PREP WOOD DOOR AND FRAME IN THEIR ENTIRETY FOR NEW WOOD STAIN.



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ARCHITECTUR Bradford A. Jones, Architect



Stree BILO

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PROJECT NO: 0110.20.002 DRAWN BY:MLW
CHECKED BY:FAS

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N OR TIONS:
N : STEREO GREY VL73 : 12X24
N : STEREO GREY VL73 : 12X24
ORING; 3/8" THICK, BLACK W/ 10%
, 92 BLUE LAGOON
00; BLUE STONE 330
IEL STAR; MAPLE CONT STRIP XL
N : STEREO GREY VL73 : 12X24
ID; PAINT USED IN FUR DOWN
NEW DUCTS, STRUCT & PIPES
B1, 92 BLUE LAGOON
B1, 92 BLUE LAGOON
SSURED
ODANCE DEEL OO ACCESS
ORANGE PEEL; SS ACCESS.
<u> </u>

Gl	ENERAL FINISH NOTES
1	SEE INTERIOR ELEVATIONS 1101 SHEETS FOR INTERIOR EINIS

- SEE INTERIOR ELEVATIONS, I101 SHEETS FOR INTERIOR FINISH MATERIAL LOCATIONS. 2. SEE REFLECTED CEILING PLANS FOR CEILING HEIGHTS, SEEE A110.
- ALL EXPOSED (EXP) NEW STRUCTURE, NEW HVAC DUCTWORK, NEW FIRE PROTECTION PIPING, NEW CONDUIT, ETC SHALL RECEIVE PAINT (DRYFALL PER CONTRACTOR'S CHOICE) TO MATCH ADJACENT FINISH UNLESS NOTED OTHERWISE IN ROOM FINISH SCHEDULE. CONTRACTOR IS RESPONSIBLE FOR PROTECTING ALL ADJACENT AREAS NOT RECEIVING NEW FINISH.
- 4. ALL ROOMS TO RECEIVE SIGNAGE AS SPECIFIED.

FOR HEIGHTS.

GENERAL FINISH REMARKS

- A. CEILING HEIGHTS AND MATERIALS VARY, SEE REFLECTED CEILING PLANS FOR MORE INFORMATION.
- B. WALL TILE TO INTERSECT AT 90 DEGREE ANGLE WITH EPOXI FLOORING. NO TILE COVE BASE REQUIRED.
- SOLID SURFACE WALL PANEL TO INTERSECT AT 90 DEGREE ANGLE WITH EPOXI FLOORING. NO EPOXI COVE COVE BASE REQUIRED. ROOMS SCHEDULE AS 'EXP' CEILING FINISH ARE OPEN TO THE STRUCTURE/ DECK ABOVE. IT IS RECOMMENDED GC VERIFICATION
- TILE BACKER BOARD REQUIRED AT ALL LOCATIONS WHERE WALL TILE OCCURS. PROVIDE TILE BACKER BOARD IN LIEU OF GYPSUM BOARD.
- F. FINISHES VARIES. SEE I101, I201 AND I202 FOR DETAILS.

						WALL F	INISHES		CEILING	
	NO	ROOM NAME	FLOOR	BASE	WALL NORTH	WALL EAST	WALL SOUTH	WALL WEST	CEILING TYPE	REMARKS
			1	1						
	101	LOBBY	FT	RB	PT1	PT1	PT1	PT1	ACT/GYP1/PT2	Α
	102	RECEPTION	FT	RB	PT1	PT1	PT1	PT1	GYP1/PT2	Α
	103	LAUNDRY							ACT	
	104	JANITOR							ACT	
	105	STORAGE							ACT	
	106	FAMILY RR	FT	ТВ	PT1	PT1	PT1	PT1	ACT	
	107	GENERAL OFFICE	CPT	RB	PT1	PT1	PT1	PT1	ACT	
	107A	OFFICE	CPT	RB	PT1	PT1	PT1	PT1	ACT	
_	108	GYMNASIUM							EXP	A, D
_	109	WEIGHT ROOM	RBF	RB	PT1	PT1	PT1	PT1	EXP	A, D
	110	MECH	RBF	RB	PT1	PT1	PT1	PT1	EXP	
	111	WEIGHT ROOM	RBF	RB	PT1	PT1	PT1	PT1	ACT	
-	112	STAIR							ACT	
	113	CIRCUIT ROOM	RBF	RB	PT1	PT1	PT1	PT1	ACT	
	114	FAMILY WORKOUT ROOM	RBF	RB	PT1	PT1	PT1	PT1	ACT	
	115	MECH							EXP	
	116	CARDIO ROOM	RBF	RB	PT1	PT1	PT1	PT1	ACT	A
	117	STRETCH ROOM	RBF	RB	PT1	PT1	PT1	PT1	ACT	Α
	118	COURT #4							ACT	
	119	COURT #5							ACT	
	120	WOMEN'S LOCKERS	EPX	EPX	PT1	PT1	PT1	PT1	ACT	
	121	WOMEN'S PRIVATE LOCKER	EPX	EPX	PT1	PT1	PT1	PT1	ACT	
	122	WOMEN'S	EPX	EPX	TL1/PT1	PT1	PT1	PT1	ACT/GYP1/PT2	A, B, E, F
	123	MEN'S RESTROOMS	EPX	EPX	TL1	PT1	TL1/PT1	TL1/PT1	ACT/GYP1/PT2	A, B, F
	124	WOMEN'S RESTROOMS	EPX	EPX	TL1/PT1	TL1	TL1	TL1/PT1	ACT/GYP1/PT2	A, B, F
	125	MEN'S SAUNA								
	126	ADA RR	EPX		TL1	TL1	TL1	TL1	GYP2/PT2	В
	128	MEN'S SHOWER	EPX		SS/PT1	SS/PT1	SS/PT1	SS/PT1	GYP2/PT2	С
	129	STORAGE							ACT	
	130	ADA RR	EPX		TL1	TL1	TL1	TL1	GYP2/PT2	В
	131	WOMEN'S SHOWER	EPX	EPX @SOME	SS/PT1	PT1	SS/PT1	SS/PT1	GYP2/PT2	C, F
	132	WOMEN'S SAUNA								
	133	MEN'S PRIVATE LOCKERS	EPX	EPX	PT1	PT1	PT1	PT1	ACT	
	134	MEN'S LOCKERS	EPX	EPX	PT1	PT1	PT1	PT1	ACT	
	135	ELEC	EPX	EPX	PT1	PT1	PT1	PT1	ACT	
	136	CORRIDOR	FT	RB	PT1	PT1	PT1	PT1	ACT/GYP1/PT2	F

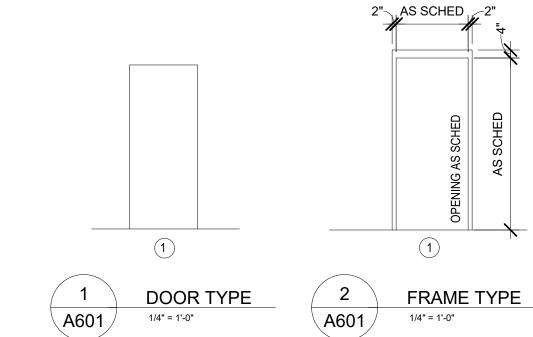
OPENING SCHED REMARKS

- OPENING IS SCHEDULED TO RECEIVE CASED OPENING FRAME WITHOUT AN INTEGRAL STOP. SEE DETAILS.
- NEW CMU INFILL AROUND ROUGH OPENING, SEE STRUCTURAL DRAWINGS FOR ADDITIONAL DETAIL.


HARDWARE SETS


- INTERIOR SINGLE DOOR WITH LEVER CYLINDRICAL LOCK OPENING #'S 121A
- 3 EA HINGES, BB, STD, 626 1 EA - KEYED LEVER CYLINDRICAL LOCK (CLASSROOM FUNCTION) 1 EA - CLOSER 689 1 EA - KICK PLATE 630


- INTERIOR SINGLE DOOR WITH PUSH/PULL
- OPENING #'S 122A, 123A 3 EA – HINGES, BB, STD, 626
- 1 EA PUSH/PULL SET 630 1 EA CLOSER, HD PA ARM WITH CUSHION STOP 689 1 EA - KICK PLATE 630
- INTERIOR SINGLE DOOR WITH LEVER CYLINDRICAL LOCK OPENING #'S 126A, 130A 3 EA – HINGES, BB, STD, 626
- 1 EA KEYED LEVER CYLINDRICAL LOCK (PRIVACY FUNCTION) 1 EA WALL OR FLOOR STOP AS REQUIRED INTERIOR SINGLE DOOR WITH RIM EXIT DEVICE OPENING #'S 135A
- 3 EA HINGES, BB, STD, NRP, 626 1 EA - RIM EXIT DEVICE, NIGHT LATCH FUNCTION, RIGID LEVER TRIM 630 1 EA - CLOSER, HD PA ARM WITH CUSHION STOP 689 1 EA - KICK PLATE 630



						OFL	NINGS SC	IILDULL						
DOOD			D	OOR					FRA	ME				
DOOR NO.	SINGLE /PAIR	W	Н	TYPE	MTL	GLAS S	MTL	TYPE	GLASS	HEAD	JAMB	SILL	RATING	REMARKS
111A		3' - 0"	7' - 2"				HM	1		5/A601	6/A601			Α
111B		9' - 4"	7' - 2"				HM	1		5/A601	6/A601			Α
121A	S	3' - 0"	7' - 0"	1	WD		HM	1		3/A601	4/A601			
122A	S	3' - 0"	7' - 0"	1	WD		HM	1		3/A601	4/A601			
123A	S	3' - 0"	7' - 0"	1	WD		HM	1		3/A601	4/A601			
126A	S	3' - 0"	7' - 0"	1	WD		НМ	1		3/A601	4/A601			В
128A		3' - 4"	7' - 2"				НМ	1		5/A601	6/A601			Α
130A	S	3' - 0"	7' - 0"	1	WD		НМ	1		3/A601	4/A601			В
135A	S	3' - 0"	7' - 0"	1	WD		НМ	1		3/A601	4/A601			

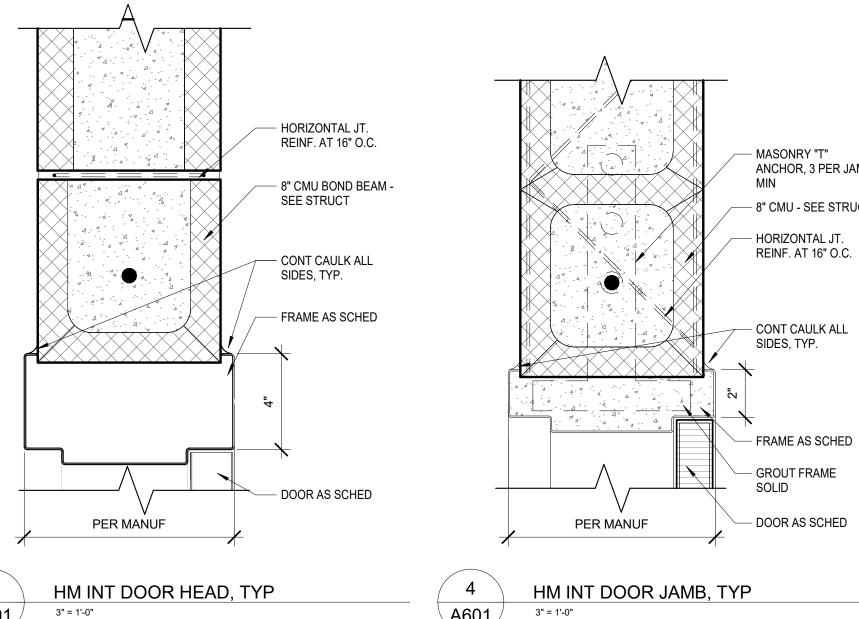

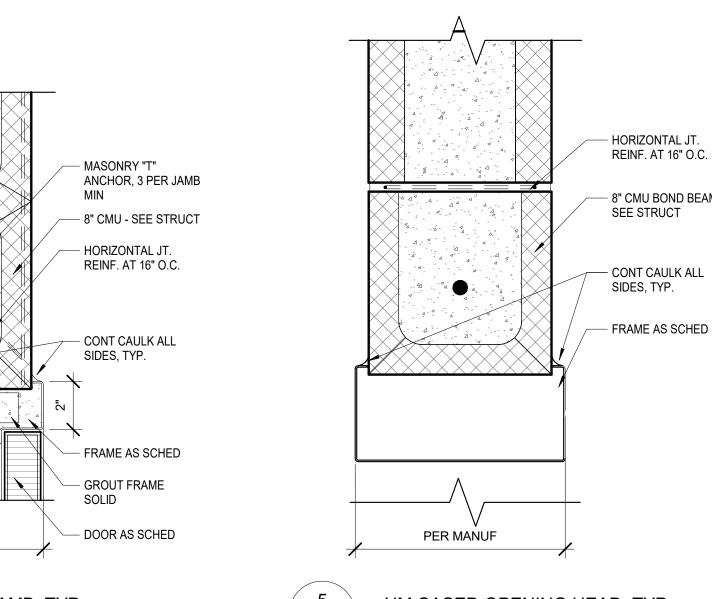

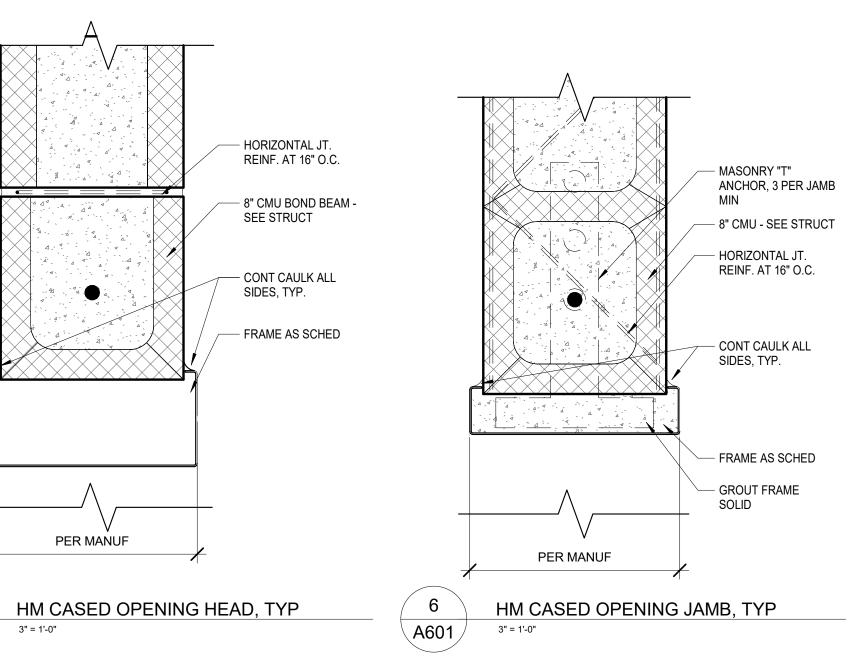

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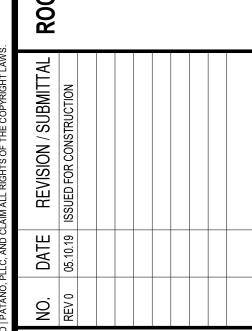


Stree BILO

SCALE: As indicated PROJECT NO: 0110.20.002 DRAWN BY:MLW
CHECKED BY:FAS

MAHG GYMK

089



A601

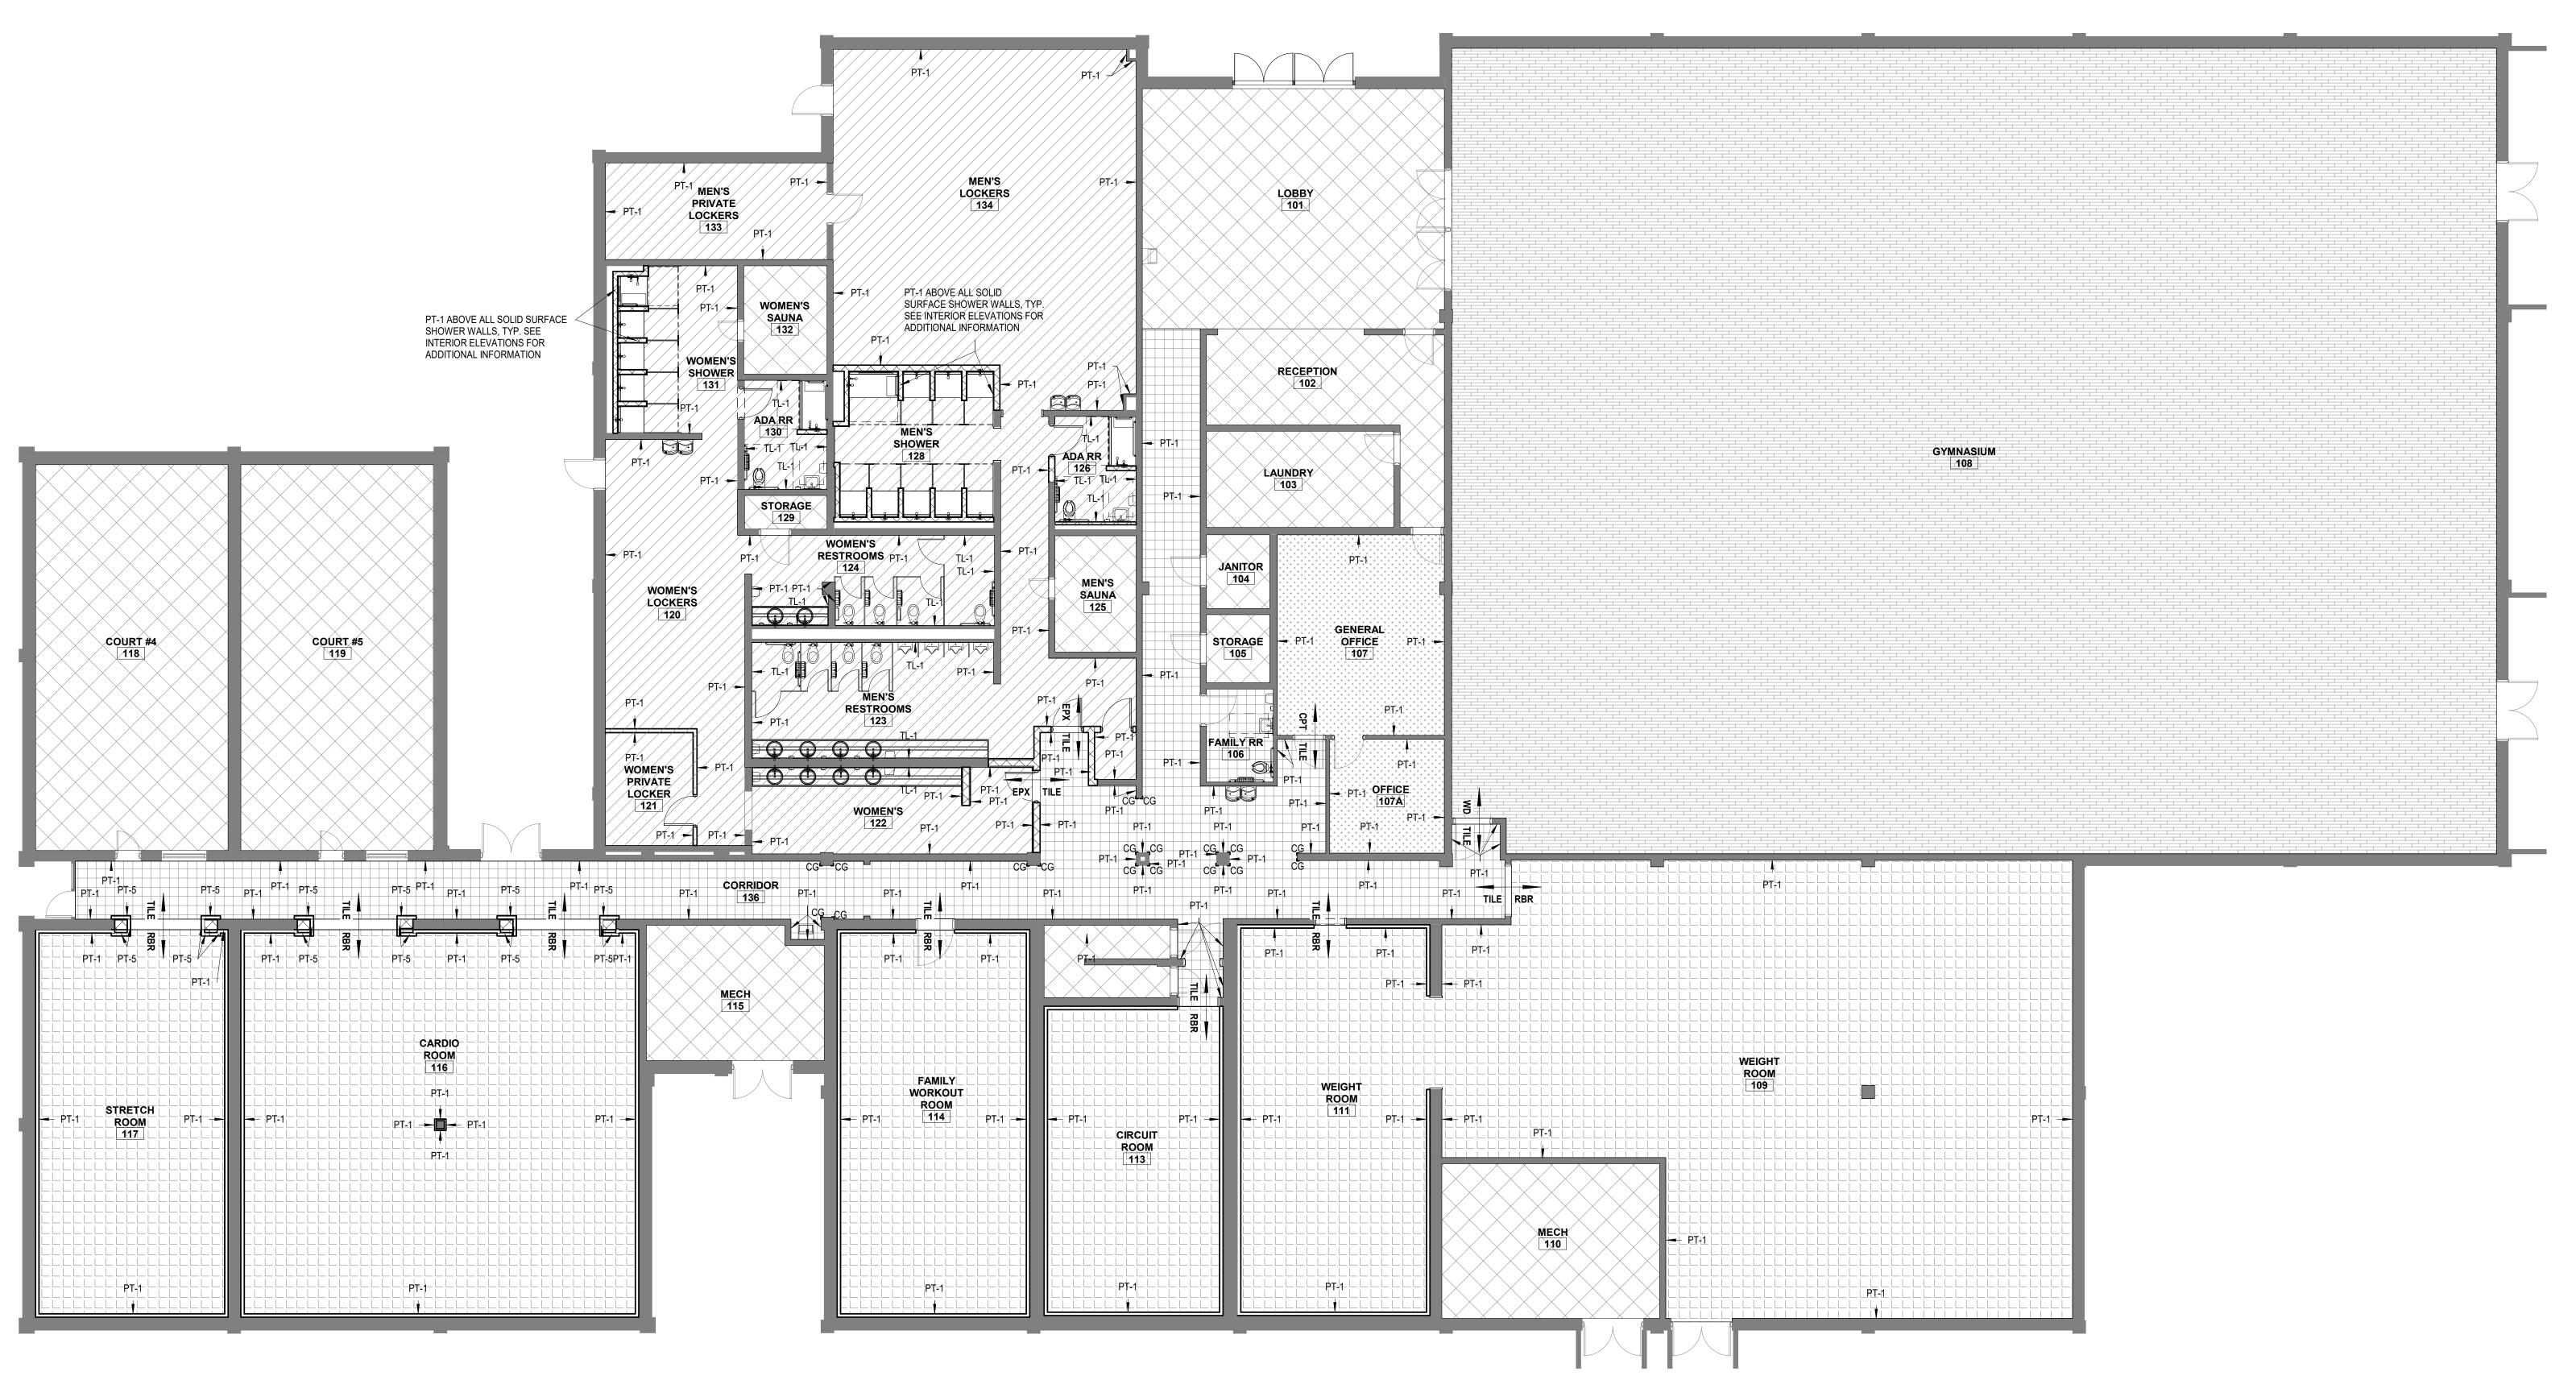
FINISH FLOOR GEN. NOTES

1. FINISH PLANS ARE SHOWN FOR REFERENCE OF FLOOR FINISH COLOR, FLOOR FINISH PATTERN, AND FLOOR FINISH GRAIN DIRECTION. 2. SEE FLOOR FINISH TRANSITION DETAILS FOR TRANSITION MATERIALS BETWEEN FINISHES. 3. SEE FINISH SCHEDULE FOR FINISHES NOT INDICATED ON FINISH FLOOR PLANS AND FOR FURTHER INFORMATION. 4. FOR ALL TILE PATTERNS NOT SHOWN THE TILE PATTERN SHALL BE CENTERED IN BOTH DIRECTIONS IN ROOM.

5. PROVIDE A RUBBER TRIM PIECE EQUAL TO JOHNSONITE FROM CARPET (CPT) TO TILE. SEE FLOOR TRANSITION DETAILS FOR SPECIFICS.

6. PROVIDE SLAB RECESSES FOR FLOORING MATERIALS AS INDICATED. COORDINATE WITH STRUCTURAL DRAWINGS FOR ALL SLAB RECESSES. 7. SEE FINISH KEY ON SHEET A601 FOR FURTHER FINISH MATERIAL

FINISH FLOOR PLAN LEGEND PORCELAIN TILE NO WORK REQUIRED ■ ●_{FD} FLOOR DRAINS FLOOR --- TRANSITION CORNER GUARD



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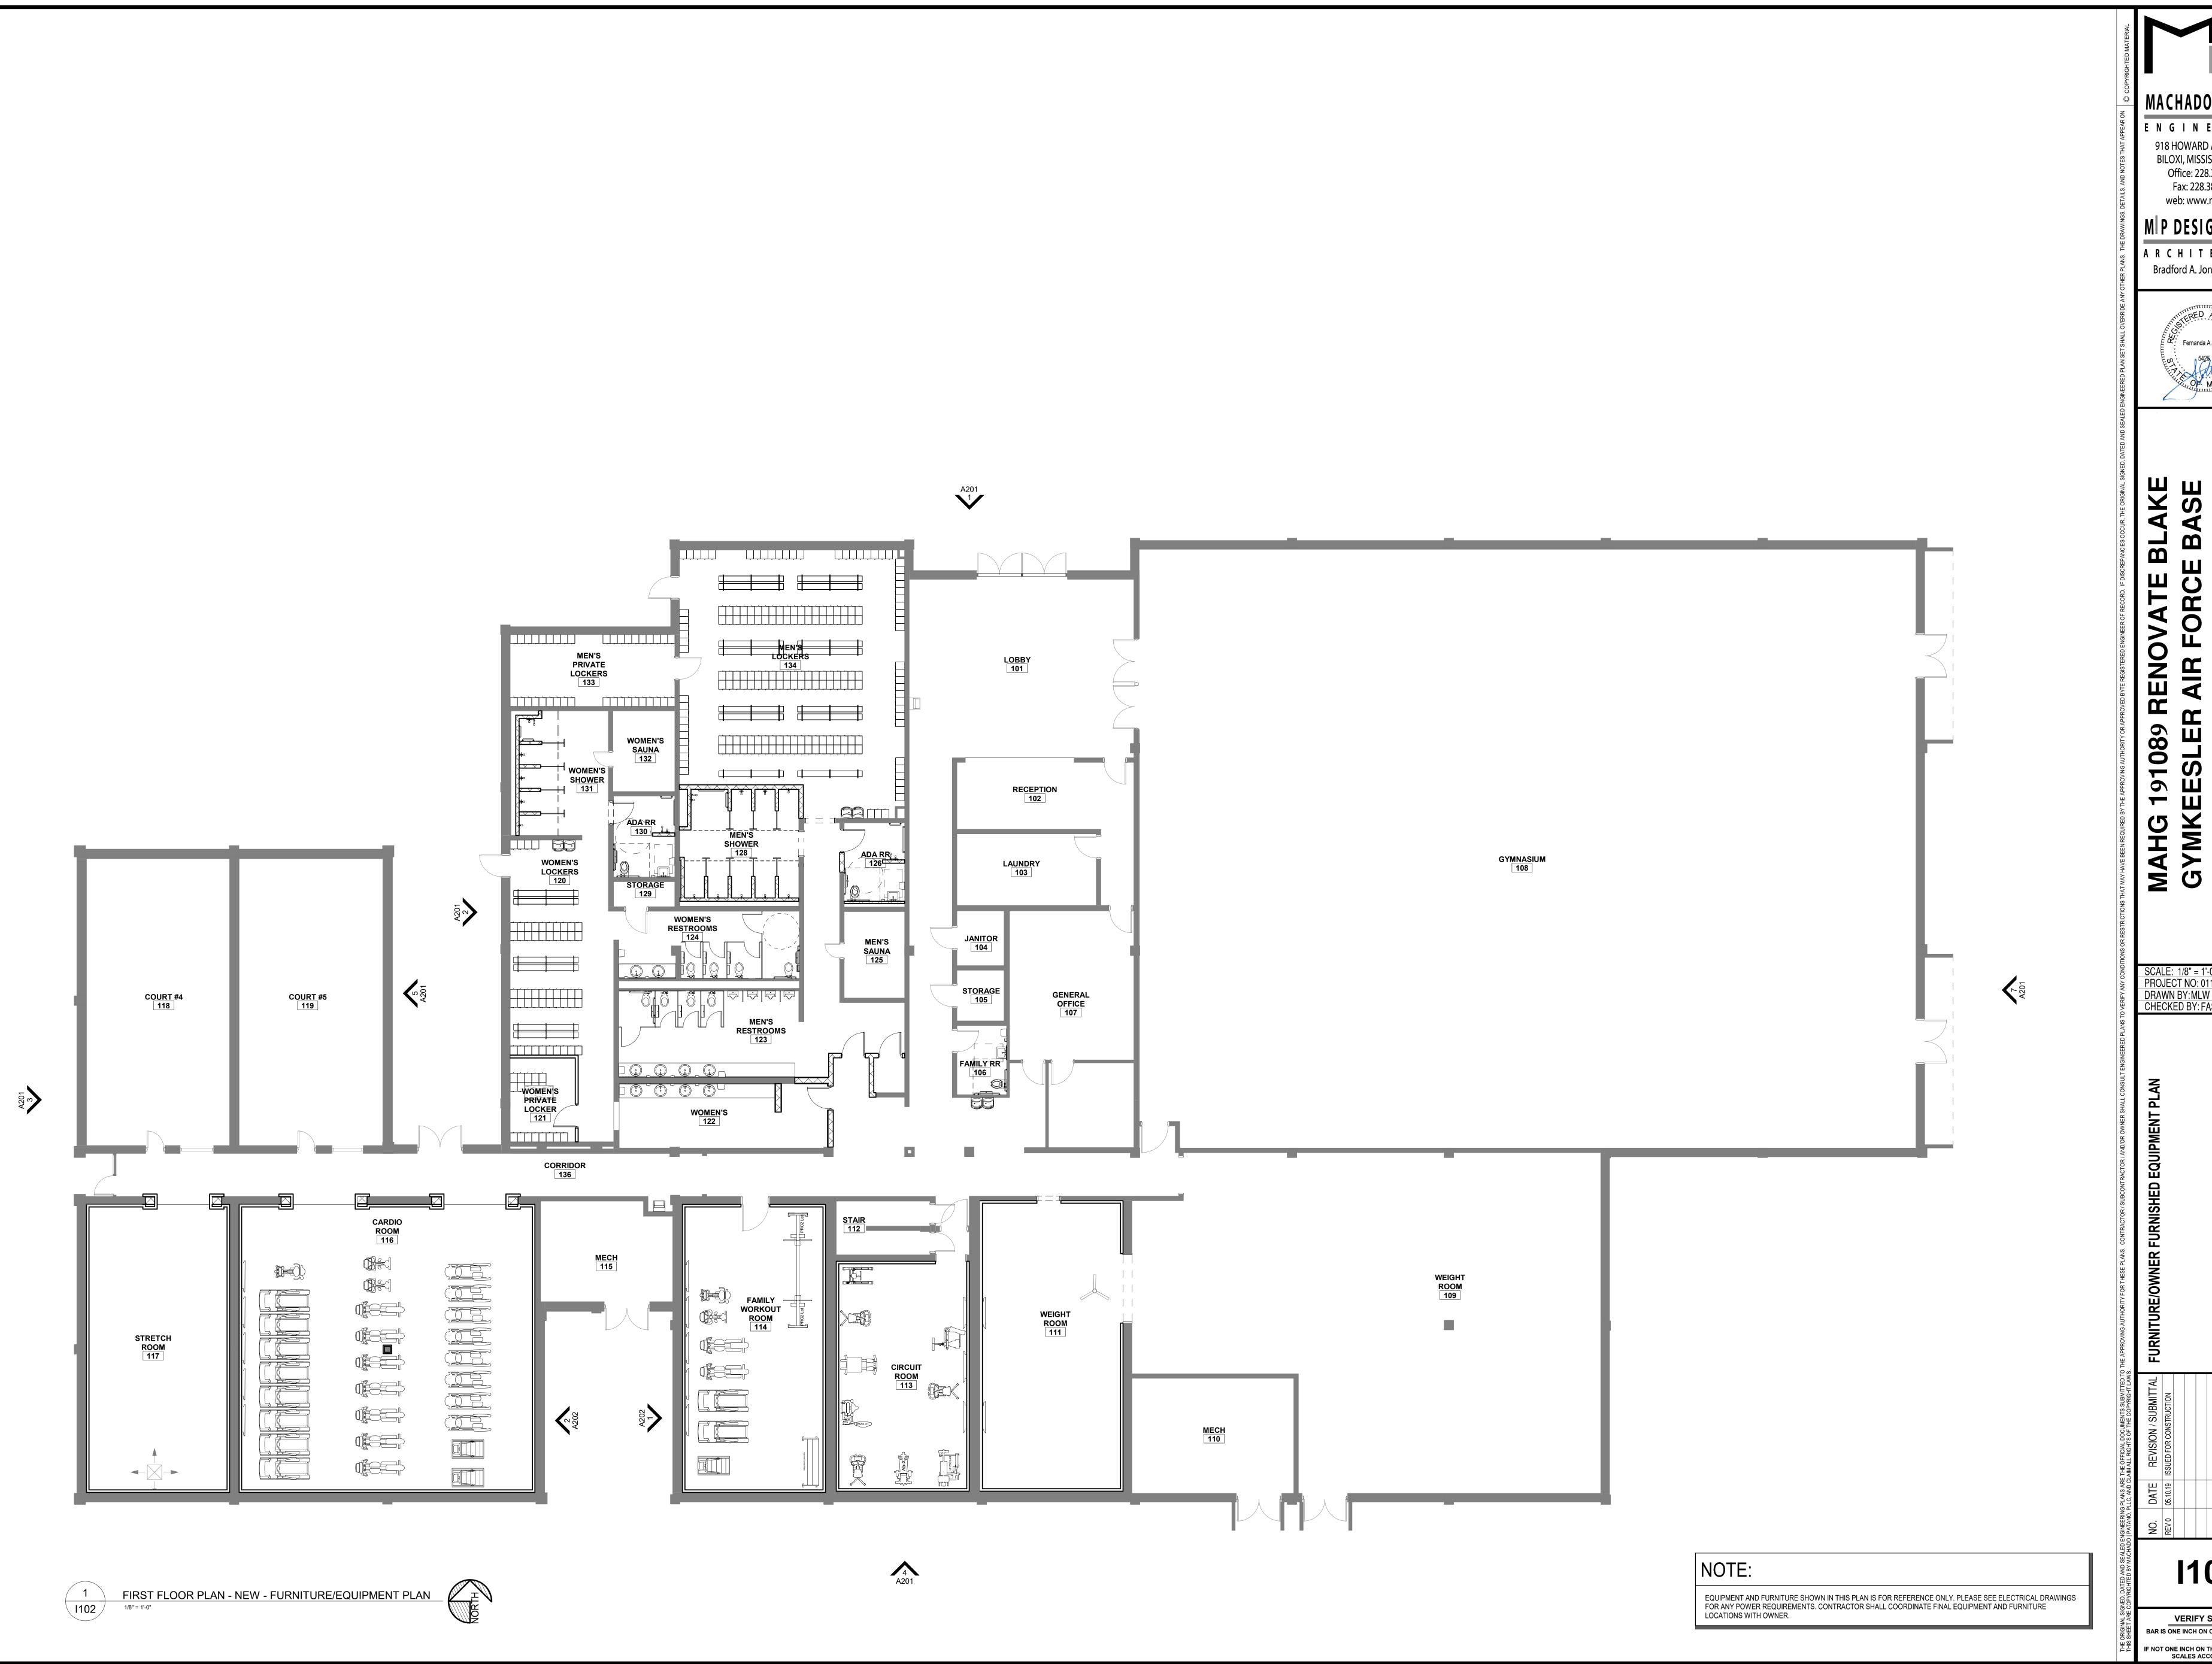
ARCHITECTURE Bradford A. Jones, Architect



MAHG GYMK

SCALE: 1/8" = 1'-0"
PROJECT NO: 0110.20.002
DRAWN BY:MLW
CHECKED BY: FAS

I101



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M P DESIGN GROUP

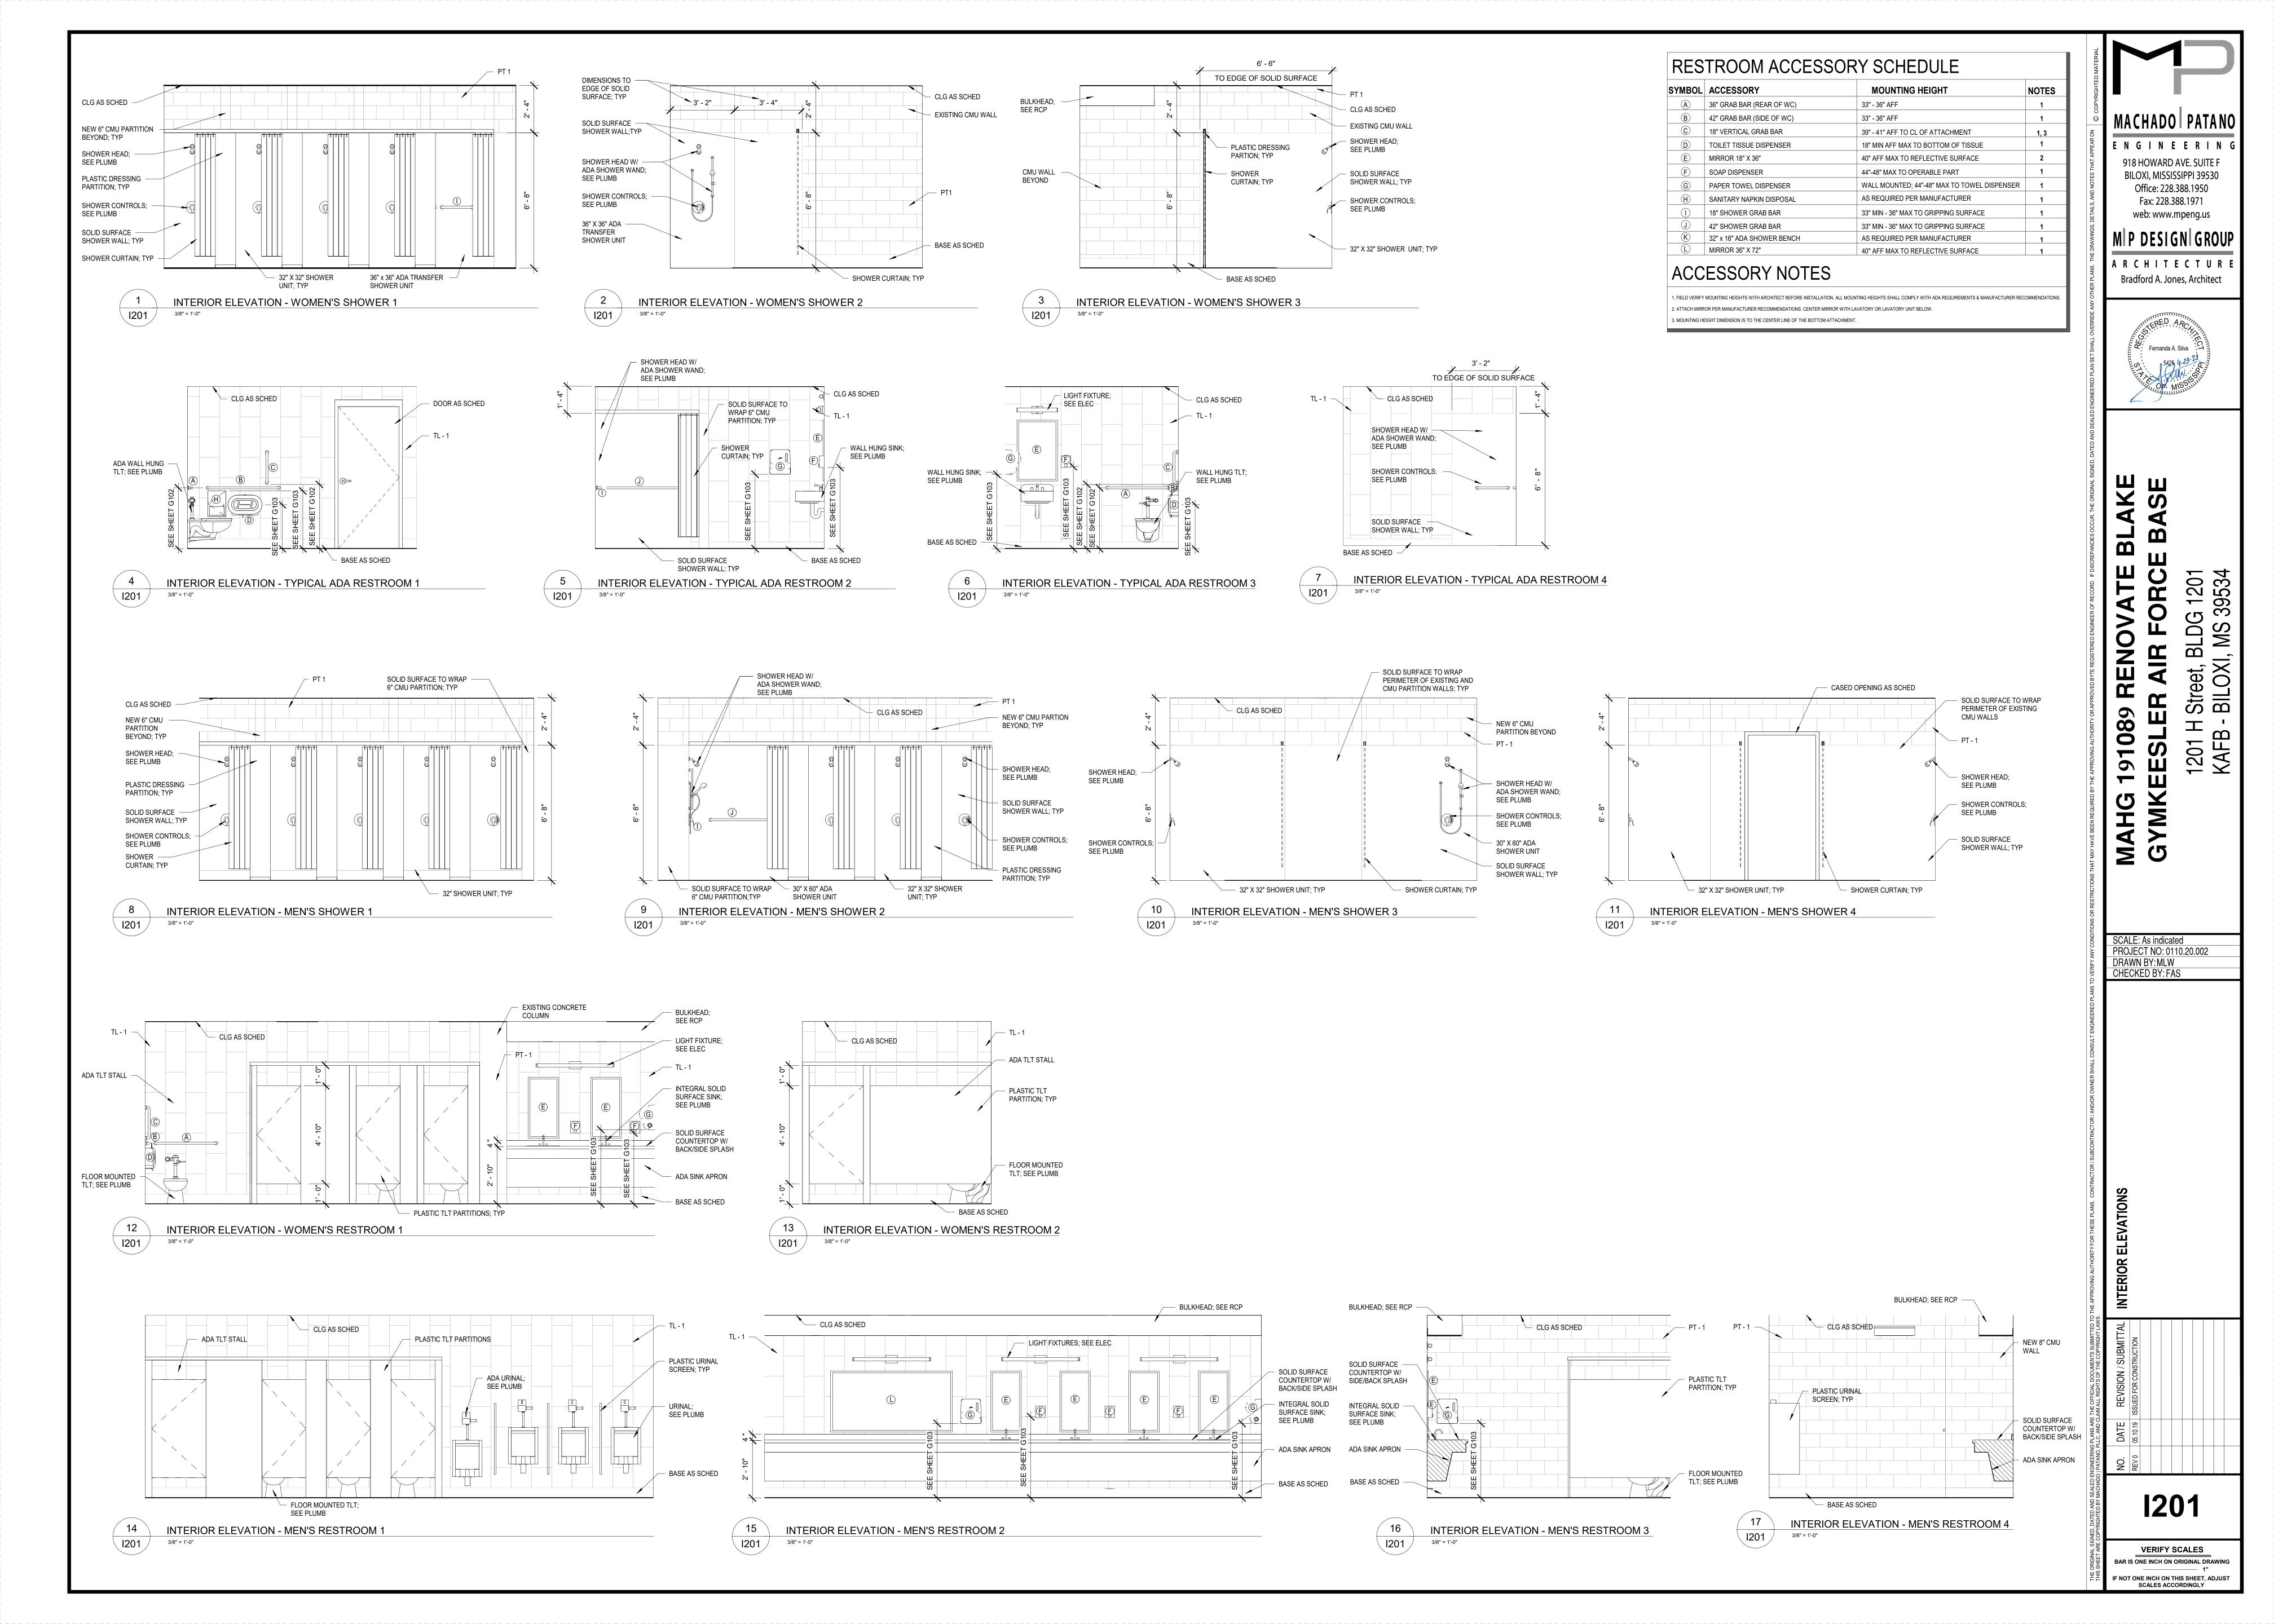
ARCHITECTUR Bradford A. Jones, Architect

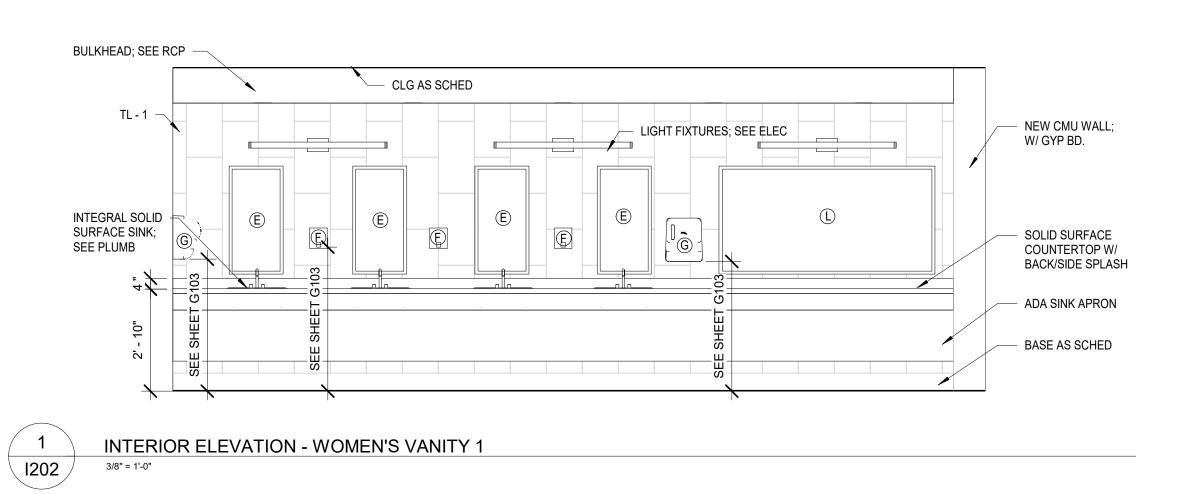


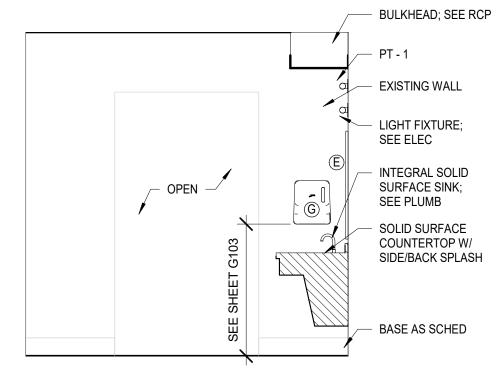
1201 H Street, BLDG ' KAFB - BILOXI, MS 39

SCALE: 1/8" = 1'-0"
PROJECT NO: 0110.20.002
DRAWN BY:MLW
CHECKED BY: FAS

I102











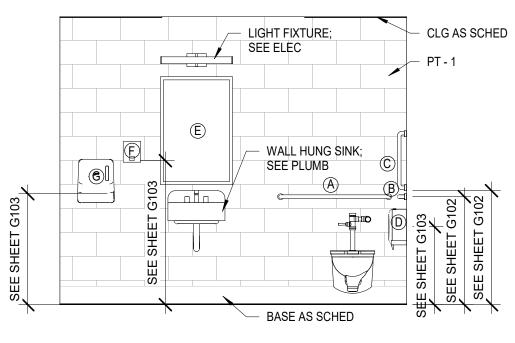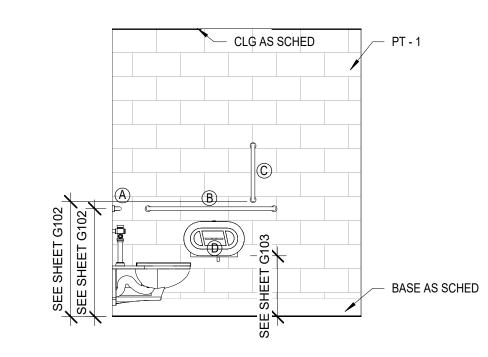INTERIOR ELEVATION - WOMEN'S VANITY 2
3/8" = 1'-0"









SYMBOL	ACCESSORY	MOUNTING HEIGHT	NOTES
A	36" GRAB BAR (REAR OF WC)	33" - 36" AFF	1
\bigcirc B	42" GRAB BAR (SIDE OF WC)	33" - 36" AFF	1
©	18" VERTICAL GRAB BAR	39" - 41" AFF TO CL OF ATTACHMENT	1, 3
(D)	TOILET TISSUE DISPENSER	18" MIN AFF MAX TO BOTTOM OF TISSUE	1
E	MIRROR 18" X 36"	40" AFF MAX TO REFLECTIVE SURFACE	2
F	SOAP DISPENSER	44"-48" MAX TO OPERABLE PART	1
G	PAPER TOWEL DISPENSER	WALL MOUNTED; 44"-48" MAX TO TOWEL DISPENSER	1
\overline{H}	SANITARY NAPKIN DISPOSAL	AS REQUIRED PER MANUFACTURER	1
	18" SHOWER GRAB BAR	33" MIN - 36" MAX TO GRIPPING SURFACE	1
J	42" SHOWER GRAB BAR	33" MIN - 36" MAX TO GRIPPING SURFACE	1
K	32" x 16" ADA SHOWER BENCH	AS REQUIRED PER MANUFACTURER	1
L	MIRROR 36" X 72"	40" AFF MAX TO REFLECTIVE SURFACE	1

ACCESSORY NOTES

1. FIELD VERIFY MOUNTING HEIGHTS WITH ARCHITECT BEFORE INSTALLATION. ALL MOUNTING HEIGHTS SHALL COMPLY WITH ADA REQUIREMENTS & MANUFACTURER RECOMMENDATIONS. 2. ATTACH MIRROR PER MANUFACTURER RECOMMENDATIONS. CENTER MIRROR WITH LAVATORY OR LAVATORY UNIT BELOW. 3. MOUNTING HEIGHT DIMENSION IS TO THE CENTER LINE OF THE BOTTOM ATTACHMENT.

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BL

MAHG 191089 RENO GYMKEESLER AIR F


1201 H Street KAFB - BILO)

SCALE: As indicated
PROJECT NO: 0110.20.002
DRAWN BY:MLW
CHECKED BY: FAS


FIRE PROTECTION NOTES

- THE FIRE SUPPRESSION WORK INDICATED ON THESE DOCUMENTS ARE FOR GENERAL PERFORMANCE, GUIDELINES, LAYOUT, AND COORDINATION PURPOSES ONLY AND DO NOT REPRESENT AN APPROVED DESIGN. THE BUILDING FIRE SUPPRESSION SYSTEM SHALL BE DESIGNED AND INSTALLED BY A QUALIFIED AND LICENSED FIRE SUPPRESSION SYSTEM CONTRACTOR IN ACCORDANCE WITH ALL APPLICABLE LOCAL CODES, ORDINANCES, UTILITY GUIDELINES, AND NFPA 13. ALL REQUIRED FINAL CALCULATIONS, LAYOUTS, DESIGN, COMPONENTS, ARRANGEMENTS, MATERIALS, ETC. SHALL BE DETERMINED BY THE FIRE SUPPRESSION CONTRACTOR.
- BUILDING SHALL BE FULLY PROTECTED BY AN AUTOMATIC FIRE SUPPRESSION SYSTEM INSTALLED IN ACCORDANCE WITH NFPA 13, STANDARD FIRE PREVENTION CODE AND LOCAL CODES. BUILDING SHALL BE PROTECTED BY A WET PIPE SYSTEM. MAXIMUM FLOOR AREA PROTECTED PER SYSTEM SHALL BE IN ACCORDACE WITH NFPA 13.
- THE FIRE SUPPRESSION SYSTEM SHALL BE DESIGNED, INSTALLED AND TESTED IN ACCORDANCE WITH THE FOLLOWING
- a. REGULATIONS OF THE APPROVING JURISDICTION
- b. NATIONAL FIRE PROTECTION ASSOCIATION STANDARDS; NO. 13 SPRINKLER SYSTEMS.
- ALL WORK SHOWN ON THESE DOCUMENTS IS INTENDED AS A GUIDE ONLY. THE CONTRACTOR SHALL BE RESPONSIBLE FOR PRODUCING COMPLETE SHOP DRAWINGS AND CALCULATIONS FOR REVIEW. THE SHOP DRAWINGS AND CALCULATIONS SHALL BE PREPARED IN ACCORDANCE WITH THE ABOVE REFERENCED NFPA STANDARDS.
- MAXIMUM AREA OF COVERAGE PER SPRINKLER SHALL BE IN ACCORDANCE WITH NFPA 13 FOR THE APPLICABLE HAZARD AND TYPE OF SPRINKLER, OR IN ACCORDANCE WITH MANUFACTURER'S LISTINGS.
- 6. PROVIDE A WET PIPE SPRINKLER SYSTEM FOR ENTIRE BUILDING.
- ALL FIRE PROTECTION SYSTEM CONTROL VALVES SHALL BE PROVIDED WITH VALVE SUPERVISORY SWITCHES BY THE SPRINKLER CONTRACTOR. WIRING TO VALVE SUPERVISORY SWITCHES AND WATER FLOW SWITCHES SHALL BE BY OTHERS. ALL ELECTRICAL DEVICES FOR THE FIRE PROTECTION SYSTEM SHALI BE COMPATIBLE WITH THE FIRE ALARM SYSTEM.
- PIPING SHALL BE INSTALLED SO THAT ALL PORTIONS OF THE SYSTEM CAN BE DRAINED BACK THROUGH VALVES IN ACCORDANCE WITH THE REFERENCED NFPA STANDARDS.
- THE CONTRACTOR SHALL SUBMIT SIGNED CERTIFIED TEST RESULTS FOR RECORD OF ALL ACCEPTANCE TEST REQUIRED BY THE APPLICABLE NFPA STANDARDS FOR THE INSTALLED FIRE PROTECTION PIPING SYSTEM. THE TEST RESULTS SHALL BE REPORTED UTILIZING NFPA STANDARD FORMS.
- 10. SPRINKLER CONTRACTOR SHALL COORDINATE SPRINKLER HEAD LOCATIONS WITH LIGHTS AND DIFFUSERS, AND OTHER MECHANICAL AND ELECTRICAL EQUIPMENT.
- 11. FULLY COORDINATE INSTALLATION OF PIPE WITH ALL OTHER TRADES, WITH PARTICULAR EMPHASIS ON COORDINATION WITH HVAC DUCTWORK. SPRINKLER PIPE SHALL NOT BE SUSPENDED FROM DUCT HANGERS UNLESS THESE SUPPORTS ARE SPECIFICALLY DESIGNED TO ACCOMMODATE SPRINKLER PIPE. HANGERS SHALL BE IN ACCORDANCE WITH NFPA 13.
- 12. CONTRACTOR SHALL CONDUCT FLOW TEST AND DETERMINE IF WATER SUPPLY IS ADEQUATE.
- 13. ALL DEVICES SHALL BE UL LISTED FOR FIRE PROTECTION SERVICE AND FM APPROVED.
- 14. ALL PIPING SHALL BE LABELED IN ACCORDANCE WITH ASTM STANDARD A13.1. LABELS SHALL INCLUDE PIPING SERVICE (FIRE WATER SUPPLY, FDC, ETC.), SIZE, AND DIRECTION OF FLOW.
- 15. ABOVE GRADE SPRINKLER PIPE SHALL BE SCHEDULE 10 BLACK STEEL. EXPOSED, EXTERIOR SPRINKLER PIPE SHALL BE PAINTED WITH A RUST PREVENTATIVE PRIMER AND TWO RUST PREVENTATIVE TOPCOATS. GALVANIZED STEEL PIPE SHALL NOT BE USED.
- 16. BELOW GRADE SPRINKLER PIPE SHALL BE AWWAC-900 PVC PIPE.
- 17. SPRINKLER HEADS IN CEILINGS SHALL BE FULLY CONCEALED TYPE. THE COVER PLATE SHALL BE FACTORY FINISHED (WHITE).
- 18. SPRINKLER HEADS IN LAY-IN, T-BAR CEILINGS SHALL BE CENTERED IN BOTH DIRECTIONS IN THE TILES. SPRINKLER HEADS IN ALL OTHER CEILINGS SHALL BE CENTERED BETWEEN THE NEAREST TWO LIGHTS. IF A CENTERED CONDITION IS NOT POSSIBLE FOR A PARTICULAR AREA, THE SPRINKLER HEADS SHALL BE INLINE WITH THE NEAREST TWO LIGHTS. IN OTHER CEILINGS, SPRINKLER HEADS SHALL BE CENTERED/INLINE WITH CEILING FEATURES. PROVIDE ADDITIONAL SPRINKLER HEADS AS NECESSARY TO ACCOMPLISH THIS EVEN IF THE COVERAGE CAN BE ACHIEVED WITH FEWER HEADS IN A NON-CENTERED/NON-INLINE LAYOUT.
- 19. SPRINKLER HEADS IN EXPOSED CEILING AREAS SHALL BE FACTORY FINISHED (BLACK).
- 20. PROVIDE AND INSTALL PIPE ESCUTCHEONS AROUND ALL WALL PENETRATIONS IN EXPOSED AREAS.
- 21. PROVIDE AND INSTALL FIRE RATED CAULKING AROUND ALL PIPE PENETRATIONS OF FIRE RATED WALLS.
- 22. FIRE SPRINKLERS INSTALLED IN RACQUET BALL COURTS SHALL BE IMPACT RATED.
- 23. ALL FIRE SPRINKLER HEADS SHALL MATCH CEILING COLOR.
- 24. CONTRACTOR SHALL REFER TO ARCHITECTURAL DRAWINGS FOR PHASING PLAN. INITIAL PHASE SHALL REQUIRE CALCULATIONS TO BE PREFORMED ON ENTIRE BUILDING. CONTRACTOR SHALL SIZE RISER AND MAIN RUNS FOR COMPLETED SCOPE. BRANCH LINES WITH VALVES AND CAPS SHALL BE INSTALLED IN INITIAL SCOPE FORE FUTURE INSTALLATION. FIRE PIPING FROM MAIN SHALL BE COMPLETED DURING EACH ASSOCIATED PHASE.


FIRE PRO	TECTION ABBREVIATIONS
	Α
AFF	ABOVE FINISHED FLOOR
, , ,	C
CUC	COVERED UNIT CONSTRUCTION
000	F
EC	ELECTRICAL CONTRACTOR
	F
FC	FIRE PROTECTION CONTRACTOR
FDC	FIRE DEPARTMENT CONNECTION
	FACTORY MUTUAL INSURANCE COMPANY OR
FM	FLOW METER
FP	FIRE PROTECTION
FT	FOOT/FEET
FW	FIRE WATER
	G
GC	GENERAL CONTRACTOR
	Н
HPFW	HIGH PRESSURE FIRE WATER
IPD	INDUSTRIAL PRODUCTS DEPARTMENT
	M
MAX	MAXIMUM
MC	MECHANICAL CONTRACTOR
MIN	MINIMUM
MPFW	MEDIUM PRESSURE FIRE WATER
	N
NTS	NOT TO SCALE
	0
OS&Y	OUTSIDE YOKE AND STEM
	Р
PC	PLUMBING CONTRACTOR
PI	PRESSURE INDICATOR
PIV	POST INDICATOR VALVE
	T
TYP	TYPICAL
	S
SW	SERVICE WATER
	U
UL	UNDERWRITERS LABORATORIES
<u>-</u>	

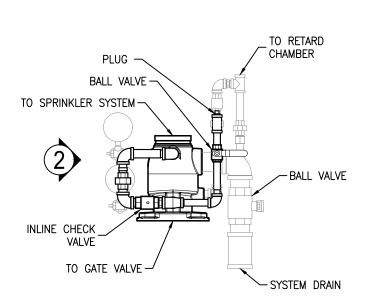



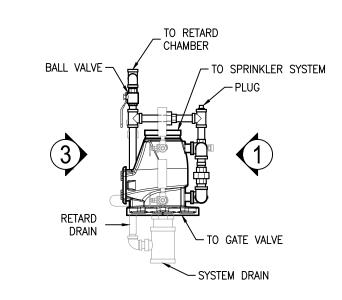

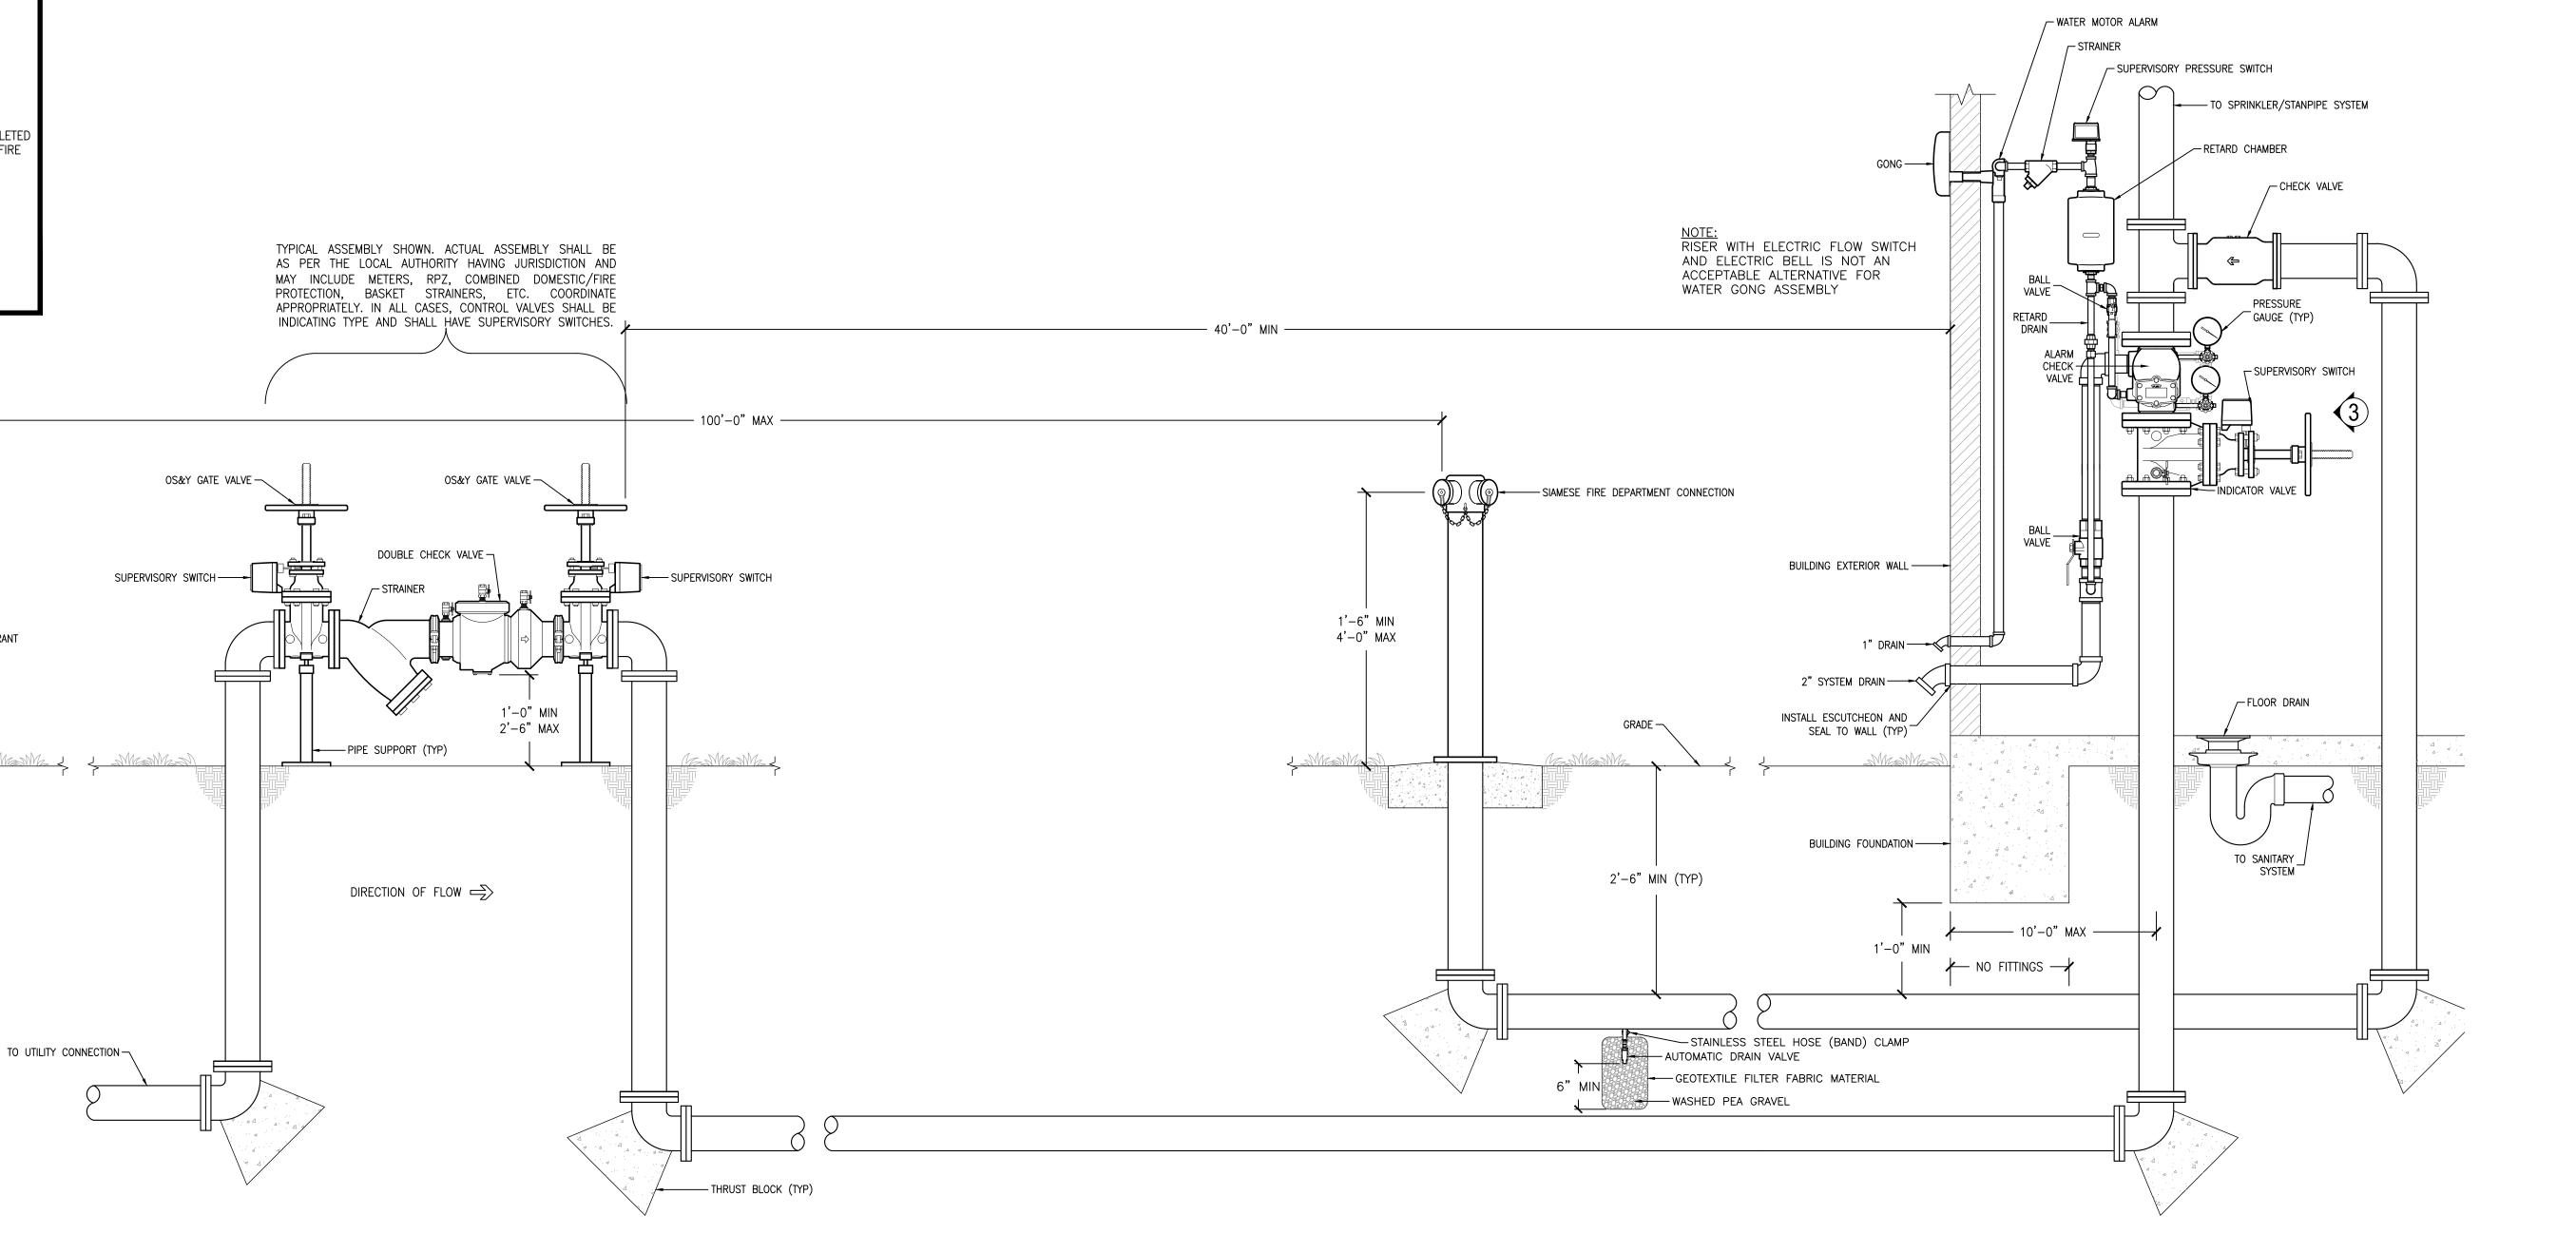2 ALARM CHECK VALVE AND TRIM-SIDE ELEVATION AND DETAIL
NTS




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MIP DESIGNIGROUP ARCHITECTURE Bradford A. Jones, Architect



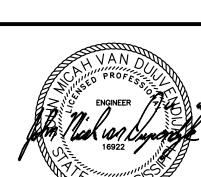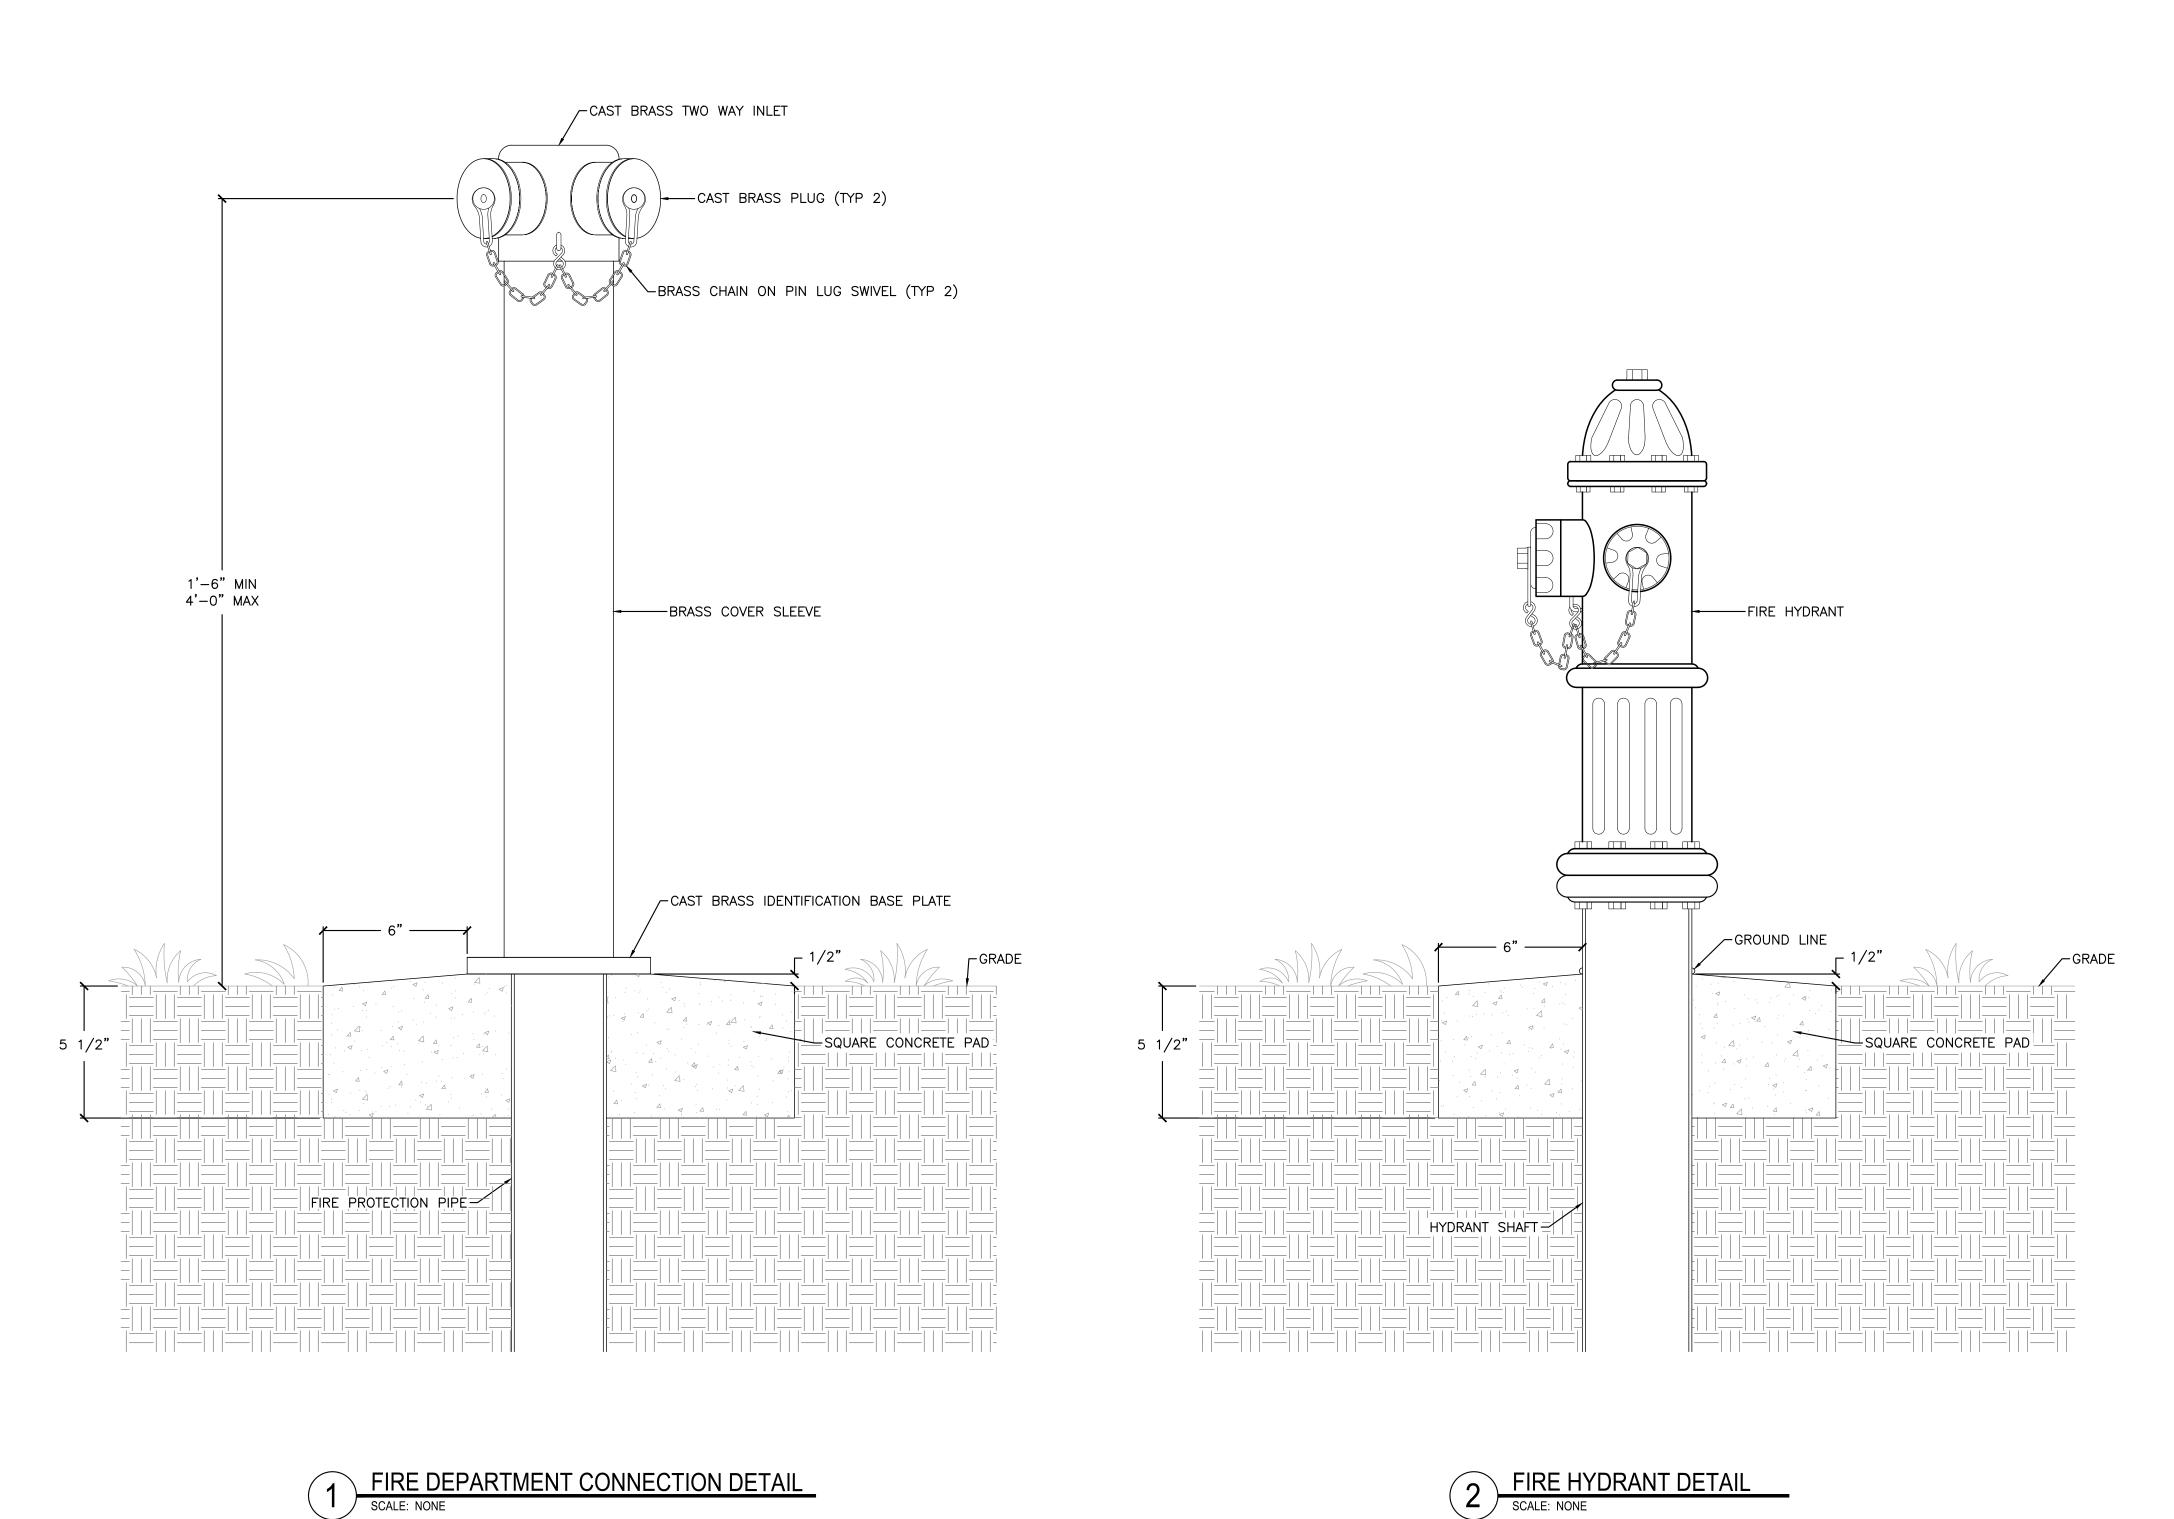
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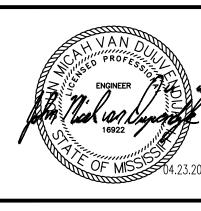


2 FIRE HYDRANT DETAIL
SCALE: NONE

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MAHG 191089 REPAIR BLAKE GYM
KEESLER AIR FORCE BASE
1201 H STREET, BLDG 1201
KAFB - BILOXI, MS 39534

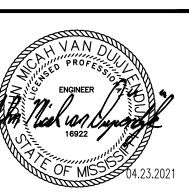
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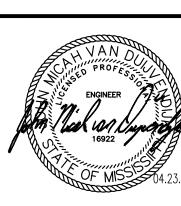
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MAHG 191089 REPAIR BLAKE GYM KEESLER AIR FORCE BASE 1201 H STREET, BLDG 1201 KAFB - BILOXI, MS 39534