

PLUMBING NOTES

- A. GENERAL
1. ALL WORK SHALL CONFORM TO THE LATEST EDITIONS OF THE INTERNATIONAL CODE AND ALL LOCAL ORDINANCES AS ADOPTED BY THE LOCAL JURISDICTION.
2. CONTRACTOR SHALL PROVIDE ALL MATERIALS AND LABOR NECESSARY FOR THE COMPLETE INSTALLATION AND OPERATION OF THE SYSTEMS INDICATED ON THE CONTRACT DOCUMENTS AND DRAWINGS EVEN IF NOT SPECIFICALLY SHOWN.
3. THE DRAWINGS ARE, IN PART, DIAGRAMMATIC AND DO NOT ALWAYS SHOW ALL NECESSARY MATERIALS AND EQUIPMENT TO SCALE OR IN EXACT LOCATIONS. IT IS THE CONTRACTOR'S RESPONSIBILITY TO CHECK ALL MEASUREMENTS, COORDINATE ALL WORK WITH OTHER TRADES, REVIEW ALL ARCHITECTURAL AND STRUCTURAL DRAWINGS, AND VISIT THE JOBSITE TO MAKE APPROPRIATE MEASUREMENTS.
4. CONTRACTOR SHALL OBTAIN ALL NECESSARY PERMITS AND INSPECTIONS AND SHALL PAY ALL ASSOCIATED FEES FOR SCOPE OF WORK.
5. WHEN THE SPECIFICATIONS OR DRAWINGS ARE UNCLEAR OR IN CONFLICT WITH CODES OR OTHER TRADES, THE CONTRACTOR SHALL BRING THIS TO THE ATTENTION OF THE ENGINEER FOR CLARIFICATION BEFORE SUBMITTING A BID.
6. SUBMITTALS AND SHOP DRAWINGS FOR ALL EQUIPMENT, MATERIALS, AND ACCESSORIES SHALL BE PROVIDED TO THE OWNER AND ENGINEER FOR REVIEW AND COMMENT PRIOR TO ORDER, MANUFACTURE, FABRICATION, AND INSTALLATION. FAILURE TO DO SO SHALL NOT RELIEVE THIS CONTRACTOR OF THE RESPONSIBILITY, CONSEQUENCES, AND POSSIBLE COSTS OF SUCH ACTION OR LACK OF ACTION REGARDLESS OF ANY AND ALL ERRORS OR OMISSIONS ON THESE DOCUMENTS. THIS ENGINEER SHALL NOT BE HELD LIABLE FOR ANY COSTS ASSOCIATED WITH THIS CONTRACTOR'S FAILURE TO COMPLY WITH THIS ITEM. IF SUBSTITUTIONS FOR SPECIFIED ITEMS ARE MADE, IT IS THIS CONTRACTOR'S RESPONSIBILITY TO PROVE PERFORMANCE, COMPATIBILITY, AND CONFORMANCE WITH THE ORIGINAL DESIGN AND SPECIFICATIONS. RE-DESIGN BY THIS ENGINEER TO ACCOMMODATE SUBSTITUTIONS SHALL NOT BE PERFORMED, OTHERWISE, IT WILL BE CONSIDERED ADDITIONAL WORK FOR WHICH COMPENSATION WILL BE REQUIRED.
7. ALL ACTUAL EQUIPMENT, MATERIALS, AND ACCESSORIES TO BE INSTALLED SHALL BE FULLY COORDINATED WITH THE ELECTRICAL, MECHANICAL, CIVIL, STRUCTURAL AND ARCHITECTURAL CONTRACTORS PRIOR TO ORDER, MANUFACTURE, FABRICATION, AND INSTALLATION. THIS INCLUDES BUT IS NOT LIMITED TO ELECTRICAL DATA, WEIGHTS, PLUMBING REQUIREMENTS, DIMENSIONS, PENETRATIONS, ETC. FAILURE TO DO SO SHALL NOT RELIEVE THIS CONTRACTOR OF THE RESPONSIBILITY, CONSEQUENCES, AND POSSIBLE COSTS OF SUCH ACTION OR LACK OF ACTION REGARDLESS OF ANY AND ALL ERRORS OR OMISSIONS ON THESE DOCUMENTS. THIS ENGINEER SHALL NOT BE HELD LIABLE FOR ANY COSTS ASSOCIATED WITH THIS CONTRACTOR'S FAILURE TO COMPLY WITH THIS ITEM.
8. ANY AND ALL DEVIATIONS FROM THE DESIGN DOCUMENTS WITHOUT THIS ENGINEER'S APPROVAL INDICATES ACCEPTANCE BY THIS CONTRACTOR AND/OR OWNER FOR ANY COSTS ASSOCIATED WITH THIS CONTRACTOR'S FAILURE TO FOLLOW THE DESIGN DOCUMENTS. IF MODIFICATIONS TO THE SPECIFIED DESIGN ARE MADE, IT IS THIS CONTRACTOR'S RESPONSIBILITY TO PROVE PERFORMANCE, COMPATIBILITY, AND CONFORMANCE WITH THE ORIGINAL DESIGN AND SPECIFICATIONS. RE-DESIGN BY THIS ENGINEER TO ACCOMMODATE MODIFICATIONS SHALL NOT BE PERFORMED, OTHERWISE, IT WILL BE CONSIDERED ADDITIONAL WORK FOR WHICH COMPENSATION WILL BE REQUIRED. SITE VISITS, INSPECTIONS, CALCULATIONS, COORDINATION, ETC. PERFORMED BY THIS ENGINEER TO INVESTIGATE PROBLEMS OR ASSOCIATED WITH DESIGN DEVIATIONS WILL ALSO BE CONSIDERED ADDITIONAL WORK FOR WHICH COMPENSATION WILL BE REQUIRED.
9. ANY ERRORS OR OMISSIONS ON THESE DOCUMENTS SHALL BE IMMEDIATELY BROUGHT TO THE ATTENTION OF THE ENGINEER FOR REVIEW AND CORRECTION.
10. THE CONSTRUCTION DOCUMENTS ARE COMPRISED OF BOTH DRAWINGS AND SPECIFICATIONS (PROJECT MANUAL). THE GENERAL CONTRACTOR SHALL NOT BREAK OUT SECTIONS TO SUB-CONTRACTORS OR VENDORS.
11. THE CONTRACTOR IS RESPONSIBLE FOR COORDINATING WORK OF ALL TRADES TO INSURE A USABLE & FUNCTIONAL END PRODUCT. ANY CONFLICTS BETWEEN THE DRAWINGS AND SPECIFICATIONS SHALL BE CLARIFIED BY THE ARCHITECT/ENGINEER. IF NO CLARIFICATION IS ISSUED THE BIDDER SHALL BID THE MOST STRINGENT PRODUCT OR APPLICATION.
12. IF DISCREPANCIES ARE ENCOUNTERED BETWEEN THE DRAWINGS, DIAGRAMS, DESCRIPTIONS, NOTES, SYMBOLS, AND/OR SPECIFICATIONS, THE MOST STRINGENT PRODUCT OR APPLICATION APPLIES IN ALL CASES. IF A COMPONENT, SYSTEM, EQUIPMENT, POINT, PROGRAM, ETC. IS LISTED IN ONE DOCUMENT BUT NOT ANOTHER, OR IF IT IS NECESSARY FOR THE OPERATION, IT SHALL BE PROVIDED AND INSTALLED.
13. THIS ENGINEER SHALL NOT BE HELD LIABLE FOR COSTS ASSOCIATED WITH ERRORS AND/OR OMISSIONS ON THESE DOCUMENTS IN EXCESS OF THE COST AND/OR TIME FOR THIS ENGINEER TO CORRECT THE DOCUMENTS, IN ANY CASE, THE LIMIT OF LIABILITY FOR THIS ENGINEER SHALL BE NO MORE THAN THE COST OF THIS ENGINEER'S INDIVIDUAL FEE, REGARDLESS OF THE TOTAL DESIGN FEE CHARGED FOR THE SET OF CONSTRUCTION DOCUMENTS.
14. TO THE FULLEST EXTENT PERMITTED BY LAW, THE TOTAL LIABILITY IN THE AGGREGATE, OF THIS ENGINEER AND THIS ENGINEER'S OFFICERS, DIRECTORS, EMPLOYEES, AGENTS, AND INDEPENDENT PROFESSIONAL ASSOCIATES, AND ANY OF THEM, TO OWNER AND ANY ONE CLAIMING BY, THROUGH OR UNDER OWNER, FOR ANY AND ALL INJURIES, CLAIMS, LOSSES, EXPENSES OR DAMAGES WHATSOEVER ARISING OUT OF OR IN ANY WAY RELATED TO THIS ENGINEER'S SERVICES, THE PROJECT OR THESE DOCUMENTS, FROM ANY CAUSE OR CAUSES WHATSOEVER, INCLUDING BUT NOT LIMITED TO, THE NEGLIGENCE, ERRORS, OMISSIONS, STRICT LIABILITY, BREACH OF CONTRACT, MISREPRESENTATION, OR BREACH OF WARRANTY OF THIS ENGINEER OR THIS ENGINEER'S OFFICERS, DIRECTORS, EMPLOYEES, AGENTS OR INDEPENDENT PROFESSIONAL ASSOCIATES OR ANY OF THEM, SHALL NOT EXCEED THE TOTAL COMPENSATION RECEIVED BY THIS ENGINEER FOR SERVICES PROVIDED.
15. THE USE OF THESE DOCUMENTS FOR CONSTRUCTION SIGNIFIES THIS OWNER, TENANT, AND CONTRACTOR'S AGREEMENT WITH THE ABOVE REQUIREMENTS REGARDLESS OF ANY OTHER PRIOR, CURRENT, OR FUTURE AGREEMENT AND/OR CONTRACT.
B. CODES, FEES, PERMITS, ETC.: THE PLUMBING CONTRACTOR SHALL BE PROPERLY LICENSED AND SHALL SECURE ALL PERMITS AND PAY ALL FEES AS REQUIRED FOR THE COMPLETE PLUMBING INSTALLATION, INCLUDING SANITARY SEWER AND POTABLE WATER TIE-INS TO THE SERVING UTILITIES. ALL WORK SHALL BE IN STRICT ACCORDANCE WITH THE INTERNATIONAL PLUMBING CODE AS AMENDED BY STATE AND COUNTY AUTHORITIES.
C. SCOPE OF WORK: THE WORK CONSISTS OF MATERIALS AND LABOR FOR A COMPLETE, OPERABLE PLUMBING SYSTEM INCLUDING, BUT NOT LIMITED TO THE FOLLOWING:
1. SANITARY SEWER SYSTEM, SOIL AND WASTE DRAIN AND VENT PIPING AND FIXTURE CONNECTIONS.
2. DOMESTIC COLD AND HOT WATER SYSTEM TO ALL SINKS & LAVATORIES. VERIFY W/ OWNER. PIPING SHALL BE DISINFECTED I.A.W. THE PLUMBING CODE.
3. ALL PLUMBING FIXTURES AND EQUIPMENT INCLUDING FLOOR DRAINS, ETC. AS REQUIRED. VERIFY LOCATIONS WITH OWNER.
4. WATER AND DRAIN PIPING SHALL BE PRESSURE TESTED I.A.W. THE PLUMBING CODE.
D. MATERIALS
1. FIXTURES AND EQUIPMENT ALL FIXTURES AND EQUIPMENT SHALL BE STANDARD, FIRST QUALITY COMPLETE WITH ALL TRIM, TRAPS, ETC. AS REQUIRED OR AS SPECIFIED BY OWNER. TOILETS, URINALS, AND LAVATORIES SHALL BE INSTALLED I.A.W. THE ACCESSIBILITY CODE FOR BUILDING CONSTRUCTION.
2. PIPING
a. DRAIN, WASTE, VENT, AND SANITARY SEWER PIPING
o.1. BELOW GRADE
o.1.A. POLYVINYL CHLORIDE (PVC)
o.1.A.A. BELOW GRADE DRAIN, WASTE, VENT, AND SANITARY SEWER PIPING SHALL BE DWV SCHEDULE 40 PVC WITH PVC-DWV FITTINGS AND SOLVENT CEMENT JOINTS.
o.2. ABOVE GRADE
o.2.A. POLYVINYL CHLORIDE (PVC)
o.2.A.A. DRAIN, WASTE, VENT, ROOF/STORM DRAINAGE, AND SANITARY SEWER PIPING SHALL BE DWV SCHEDULE 40 PVC WITH PVC-DWV FITTINGS AND SOLVENT CEMENT JOINTS.
o.4.B. BRASS
o.4.A.A. EXPOSED DRAIN AND WASTE PIPING SHALL BE 17 GAUGE CHROME PLATED BRASS. TRAP JOINTS SHALL BE SLIP TYPE WITH CHROME PLATED BRASS NUTS AND COMPRESSION GASKETS. CHROME PLATED BRASS ESCUTCHEON PLATES SHALL BE INSTALLED AT WALL PENETRATIONS.


- o.4.A.B. EXPOSED DRAIN AND WASTE PIPING IN ADA INSTALLATIONS SHALL BE COVERED WITH ADA COMPLIANT MOLDED VINYL JACKET COVERS PRECISELY FITTED TO INSTALLED PIPING.
b. DOMESTIC WATER
b.1. ABOVE GRADE-ALL PIPING 2" OR SMALLER SHALL BE ZURNPEX STICKS WITH ZURN EXPANSION FITTINGS OR APPROVED EQUAL. ALL PIPING 2-1/2" OR LARGER SHALL BE SCHEDULE 40 CPVC WITH CPVC FITTINGS AND SOLVENT CEMENT JOINTS. ALL PEX PIPING SHALL BE INSTALLED WITH GALVANIZED PIPE SUPPORTS SIMILAR TO UPONOR PEX-A PIPE SUPPORTS.
b.2. BELOW GRADE, INSIDE STRUCTURE-SCHEDULE 40 CPVC WITH CPVC FITTINGS AND SOLVENT CEMENT JOINTS. CPVC PIPE SHALL EXTEND THROUGH THE BUILDING SLAB IF PRESENT.
b.3. BELOW GRADE, OUTSIDE STRUCTURE-SCHEDULE 40 PVC WITH PVC FITTINGS AND SOLVENT CEMENT JOINTS.
b.4. INSULATION
b.4.A. COLD WATER: INSULATE ALL PIPING ABOVE SLAB OR GRADE (INCLUDING TRAP PRIMERS) WITH 1/2" THICK FIBERGLASS WITH VAPOR SEAL. ALL PIPING IN PLenum AREAS SHALL BE INSULATED WITH INSULATION WITH A FLAME SPREAD INDEX OF NOT MORE THAN 25 AND A SMOKE-DEVELOPED INDEX OF NOT MORE THAN 50.
b.4.B. HOT WATER: INSULATE ALL PIPING 1-1/4" OR SMALLER WITH 1" THICK FIBERGLASS. INSULATE ALL PIPING 1-1/2" OR LARGER WITH 1-1/2" THICK FIBERGLASS.
b.4.C. EXPOSED PIPE AND FITTING INSULATION IN FINISHED AREAS SHALL BE JACKETED WITH FACTORY COLORED PVC INSULATION JACKETING. SUBMIT COLORS FOR APPROVAL.
b.5. ALL HOT WATER SUPPLIES SHALL BE EQUIPPED WITH ANTI-SCALD/TEMPERING DEVICES CONFORMING TO ASSE 1070. LAVATORY AND HAND WASH DEVICES SHALL LIMIT THE TEMPERATURE TO NO MORE THAN 110F. THE WATER HEATER SHALL BE SET TO NO MORE THAN 120F.
b.6. PROVIDE WATER HAMMER ARRESTORS FOR HOT AND COLD WATER SUPPLY AT ALL HARD SHUTOFF DEVICES (LAVATORIES, SINKS, DRINKING FOUNTAINS, DISHWASHERS, CLOTHES WASHERS, ETC.).
c. DIELECTRIC UNIONS SHALL BE INSTALLED AT ALL DIS-SIMILAR METAL CONNECTIONS. DIS-SIMILAR HANGER TO PIPE, HANGER TO STRUCTURE, PIPE TO STRUCTURE CONTACT SHALL BE ISOLATED. THIS INCLUDES BUT IS NOT LIMITED TO THE FOLLOWING:
c.1. COPPER TO STEEL
c.2. CAST IRON TO STAINLESS STEEL
c.3. STAINLESS STEEL TO STEEL
c.4. BRASS TO STEEL
c.5. BRONZE TO STEEL
E. PRESSURE TESTING
1. SANITARY, DRAIN, WASTE, AND VENT
a. PLUG ALL OPENINGS EXCEPT THOSE AT THE UPPERMOST 10 FT OF THE SYSTEM.
b. FILL SYSTEM WITH WATER TO MAINTAIN NO LESS THAN 10 FT HEAD ON ALL JOINTS AND PIPES BELOW THE UPPERMOST 10 FT OF THE SYSTEM. MAINTAIN PRESSURE FOR 12 HOURS.
c. IF LOSS OF PRESSURE OCCURS, LOCATE AND REPAIR LEAKS AND REPEAT TEST PROCEDURE.
d. DOCUMENT TEST AND PROVIDE TO OWNER. INSPECTION BY LOCAL AUTHORITY MAY BE REQUIRED.
2. WATER SUPPLY
a. ALL SYSTEM PIPES AND JOINTS SHALL BE TESTED.
b. ISOLATE PORTION OF SYSTEM TO BE TESTED WITH SHUTOFF VALVES AND/OR CAPS.
c. FILL SYSTEM WITH AIR (FOR PIPE OTHER THAN PLASTIC) OR WATER (FOR PLASTIC PIPE) TO A PRESSURE OF 100 PSI. MAINTAIN PRESSURE FOR 12 HOURS.
d. IF LOSS OF PRESSURE OCCURS, LOCATE AND REPAIR LEAKS AND REPEAT TEST PROCEDURE.
e. DOCUMENT TEST AND PROVIDE TO OWNER. INSPECTION BY LOCAL AUTHORITY MAY BE REQUIRED.
F. DISINFECTION OF DOMESTIC WATER PIPING SYSTEM
1. PRIOR TO STARTING WORK, VERIFY SYSTEM IS COMPLETE, FLUSHED, AND CLEAN.
2. ENSURE PH OF WATER TO BE TREATED IS BETWEEN 7.4 AND 7.6 BY ADDING ALKALI (CAUSTIC SODA OR SODA ASH) OR ACID (HYDROCHLORIC).
3. INJECT DISINFECTANT (FREE CHLORINE IN LIQUID, POWDER, TABLET OR GAS FORM) THROUGHOUT SYSTEM TO OBTAIN 50 TO 80 MG/L RESIDUAL.
4. BLEED WATER FROM OUTLETS TO ENSURE DISTRIBUTION AND TEST FOR DISINFECTANT RESIDUAL AT MINIMUM 15 PERCENT OF OUTLETS.
5. MAINTAIN DISINFECTANT IN SYSTEM FOR 24 HOURS.
6. TEST FOR DISINFECTANT RESIDUAL. IF FINAL DISINFECTANT RESIDUAL TESTS LESS THAN 25 MG/L, REPEAT TREATMENT.
7. FLUSH DISINFECTANT FROM SYSTEM UNTIL RESIDUAL IS EQUAL TO THAT OF INCOMING WATER OR 1.0 MG/L.
8. TAKE SAMPLES NO SOONER THAN 24 HOURS AFTER FLUSHING FROM 10 PERCENT OF OUTLETS AND FROM WATER ENTRY. ANALYZE IN ACCORDANCE WITH ANWA G611. REPEAT ENTIRE PROCEDURE IF CONTAMINATION REMAINS.
9. DOCUMENT DISINFECTION AND PROVIDE TO OWNER. INSPECTION BY LOCAL AUTHORITY MAY BE REQUIRED.
G. ALL PIPING SHALL BE LABELED IN ACCORDANCE WITH ASTM STANDARD A134. LABELS SHALL INCLUDE PIPING SERVICE (COLD WATER, HOT WATER, HOT WATER RETURN, VENT, ETC.), SIZE, AND DIRECTION OF FLOW.
H. THE FINISHED FLOOR OF ALL AREAS SERVED BY A FLOOR DRAIN SHALL BE SLOPED A MINIMUM OF 1/16" PER FOOT DOWNWARD TOWARD THE FLOOR DRAIN. THE SLOPE SHALL BE CONTINUOUS AND CONSISTENT FOR THE ENTIRE AREA BOUND BY THE ENCLOSING WALLS UNLESS OTHERWISE INDICATED IN THE ARCHITECTURAL OR FOUNDATION PLANS. THE TOP OF THE FLOOR DRAIN STRAINER SHALL BE THE LOWEST POINT IN THE SLOPED AREA. SHALL BE INSTALLED LEVEL, AND SHALL BE INSTALLED FLUSH WITH THE SURROUNDING FINISHED FLOOR. COORDINATE WITH GC.
I. COORDINATE ALL REQUIRED WALL, FLOOR, CEILING, AND ROOF PENETRATION LOCATIONS AND SIZES WITH THE GC PRIOR TO CONSTRUCTION. GC SHALL PROVIDE ALL REQUIRED FRAMED OPENINGS, HEADERS, MASONRY OPENINGS, LINTELS, ETC. AS NECESSARY.
J. COORDINATE ALL PIPE & FIXTURE LOCATIONS, SIZES, AND ROUTING WITH GC PRIOR TO CONSTRUCTION. GC SHALL PROVIDE A CLEAR PATH THROUGH FRAMING AND MASONRY COMPONENTS TO ACCOMMODATE PIPE ROUTING.
K. CONTRACTOR SHALL REFER TO ARCHITECTURAL PLANS FOR PHASING PLAN.

PLUMBING ABBREVIATIONS

Table with columns for Abbreviation and Description. Includes categories A (AMPS, AFF, ASSE), C (CFH, CO, CW), D (DRAIN, DCW, DHW, DR), E (EC), F (Fahrenheit, FCO, FT), G (GAS, GAL, GC, GCO), H (HB, HDPE, HP, HW, HWR, HWS), K (KW), L (LBS, LNG, LP, LPG, LW), M (MAX, MBH, MC, MCA, MDE, MIN, MOC), N (NIC, NRS, NTS), P (PC, PH, PRV, PSIA, PSIG, PSI), R (RPM, RPZ), S (S, SGFT), T (TW, T&P, TYP), U (UV), V (V, VTR), W (W, WCO, WH).

PLUMBING SYMBOLS

Table mapping symbols to plumbing components. Symbols include dashed lines for cold/hot water, solid lines for hot water return, dashed lines with arrows for sanitary/existing sanitary, and various valve symbols (lever ball, hose bib, connect to existing, cap and seal).

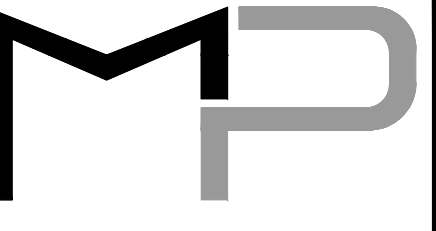

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ARCHITECTURE Bradford A. Jones, Architect



MAHG 191089 REPAIR BLAKE GYM KEESLER AIR FORCE BASE 1201 H STREET, BLDG 1201 KAFB - BILOXI, MS 39534

SCALE: AS INDICATED PROJECT NO: 0110.20.002 DRAWN BY: TJA CHECKED BY: JMV

PLUMBING NOTES, ABBREVIATIONS, & SYMBOLS

Table for revision tracking with columns for No., Date, Revision, and Description.


P001

VERIFY SCALES BAR IS ONE INCH ON ORIGINAL DRAWING IF NOT ONE INCH ON THIS SHEET, ADJUST SCALES ACCORDINGLY

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FA301024R0003 3 April 2024

PRINTED: 4/23/2021 3:32 PM BY: Tyler Abell LAST SAVED: 4/23/2021 1:42 PM BY: Tobell  
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- PLUMBING DEMOLITION KEY NOTES**
- 1 CONTRACTOR SHALL DEMOLISH EXISTING WATER CLOSET. PRESERVE SANITARY AND DOMESTIC WATER CONNECTIONS FOR NEW WATER CLOSET.
  - 2 CONTRACTOR SHALL DEMOLISH EXISTING WATER CLOSET. CAP SANITARY SEWER BELOW FINISH FLOOR AND PATCH TO MATCH EXISTING. DEMOLISH EXISTING DOMESTIC WATER LINE BACK TO MAIN AND CAP AT BRANCH CONNECTION. PATCH WALL TO LIKE NEW CONDITION.
  - 3 CONTRACTOR SHALL DEMOLISH EXISTING URINAL. PRESERVE SANITARY AND DOMESTIC WATER CONNECTIONS FOR NEW URINAL.
  - 4 CONTRACTOR SHALL DEMOLISH EXISTING DROP-IN LAVATORY. PRESERVE SANITARY AND DOMESTIC WATER CONNECTIONS FOR NEW LAVATORY.
  - 5 CONTRACTOR SHALL DEMOLISH EXISTING FLOOR DRAIN GRATE. EXISTING FLOOR DRAIN SHALL BE CAPPED/COVERED DURING CONSTRUCTION.
  - 6 CONTRACTOR SHALL DEMOLISH EXISTING WALL MOUNTED SHOWER FAUCET. DEMOLISH EXISTING DOMESTIC WATER LINE BACK TO MAIN AND CAP AT BRANCH CONNECTION. PATCH WALL TO LIKE NEW CONDITION.
  - 7 CONTRACTOR SHALL DEMOLISH EXISTING WALL MOUNTED SHOWER FAUCET AND FLOOR MOUNTED SHOWER RECEPTOR. DEMOLISH EXISTING DOMESTIC WATER LINE BACK TO MAIN AND CAP AT BRANCH CONNECTION. PATCH WALL TO LIKE NEW CONDITION. CAP SANITARY SEWER BELOW FINISH FLOOR.
  - 8 CONTRACTOR SHALL DEMOLISH EXISTING FLOOR DRAIN STRAINER AND GRATE. CAP SANITARY SEWER BELOW FINISH FLOOR.
  - 9 CONTRACTOR SHALL DEMOLISH EXISTING STEAMERS AND ALL ACCESSORIES. DEMOLISH EXISTING DOMESTIC WATER LINE BACK TO MAIN AND CAP AT BRANCH CONNECTION. CAP SANITARY SEWER BELOW FINISH FLOOR.
  - 10 CONTRACTOR SHALL DEMOLISH EXISTING WALL MOUNTED LAVATORY. PRESERVE SANITARY AND DOMESTIC WATER CONNECTIONS FOR NEW WALL MOUNTED LAVATORY.
  - 11 CONTRACTOR SHALL DEMOLISH EXISTING WATER COOLER. PRESERVE SANITARY AND DOMESTIC WATER CONNECTIONS FOR NEW WATER COOLER.
  - 12 CONTRACTOR SHALL DEMOLISH EXISTING WATER COOLER. CAP SANITARY SEWER IN WALL AND PATCH AND PAINT WALL TO MATCH EXISTING. CAP EXISTING DOMESTIC WATER LINE IN WALL. PATCH AND PAINT WALL TO LIKE NEW CONDITION.

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SCALE:	AS INDICATED
PROJECT NO.:	0110.20.002
DRAWN BY:	TJA
CHECKED BY:	IMV

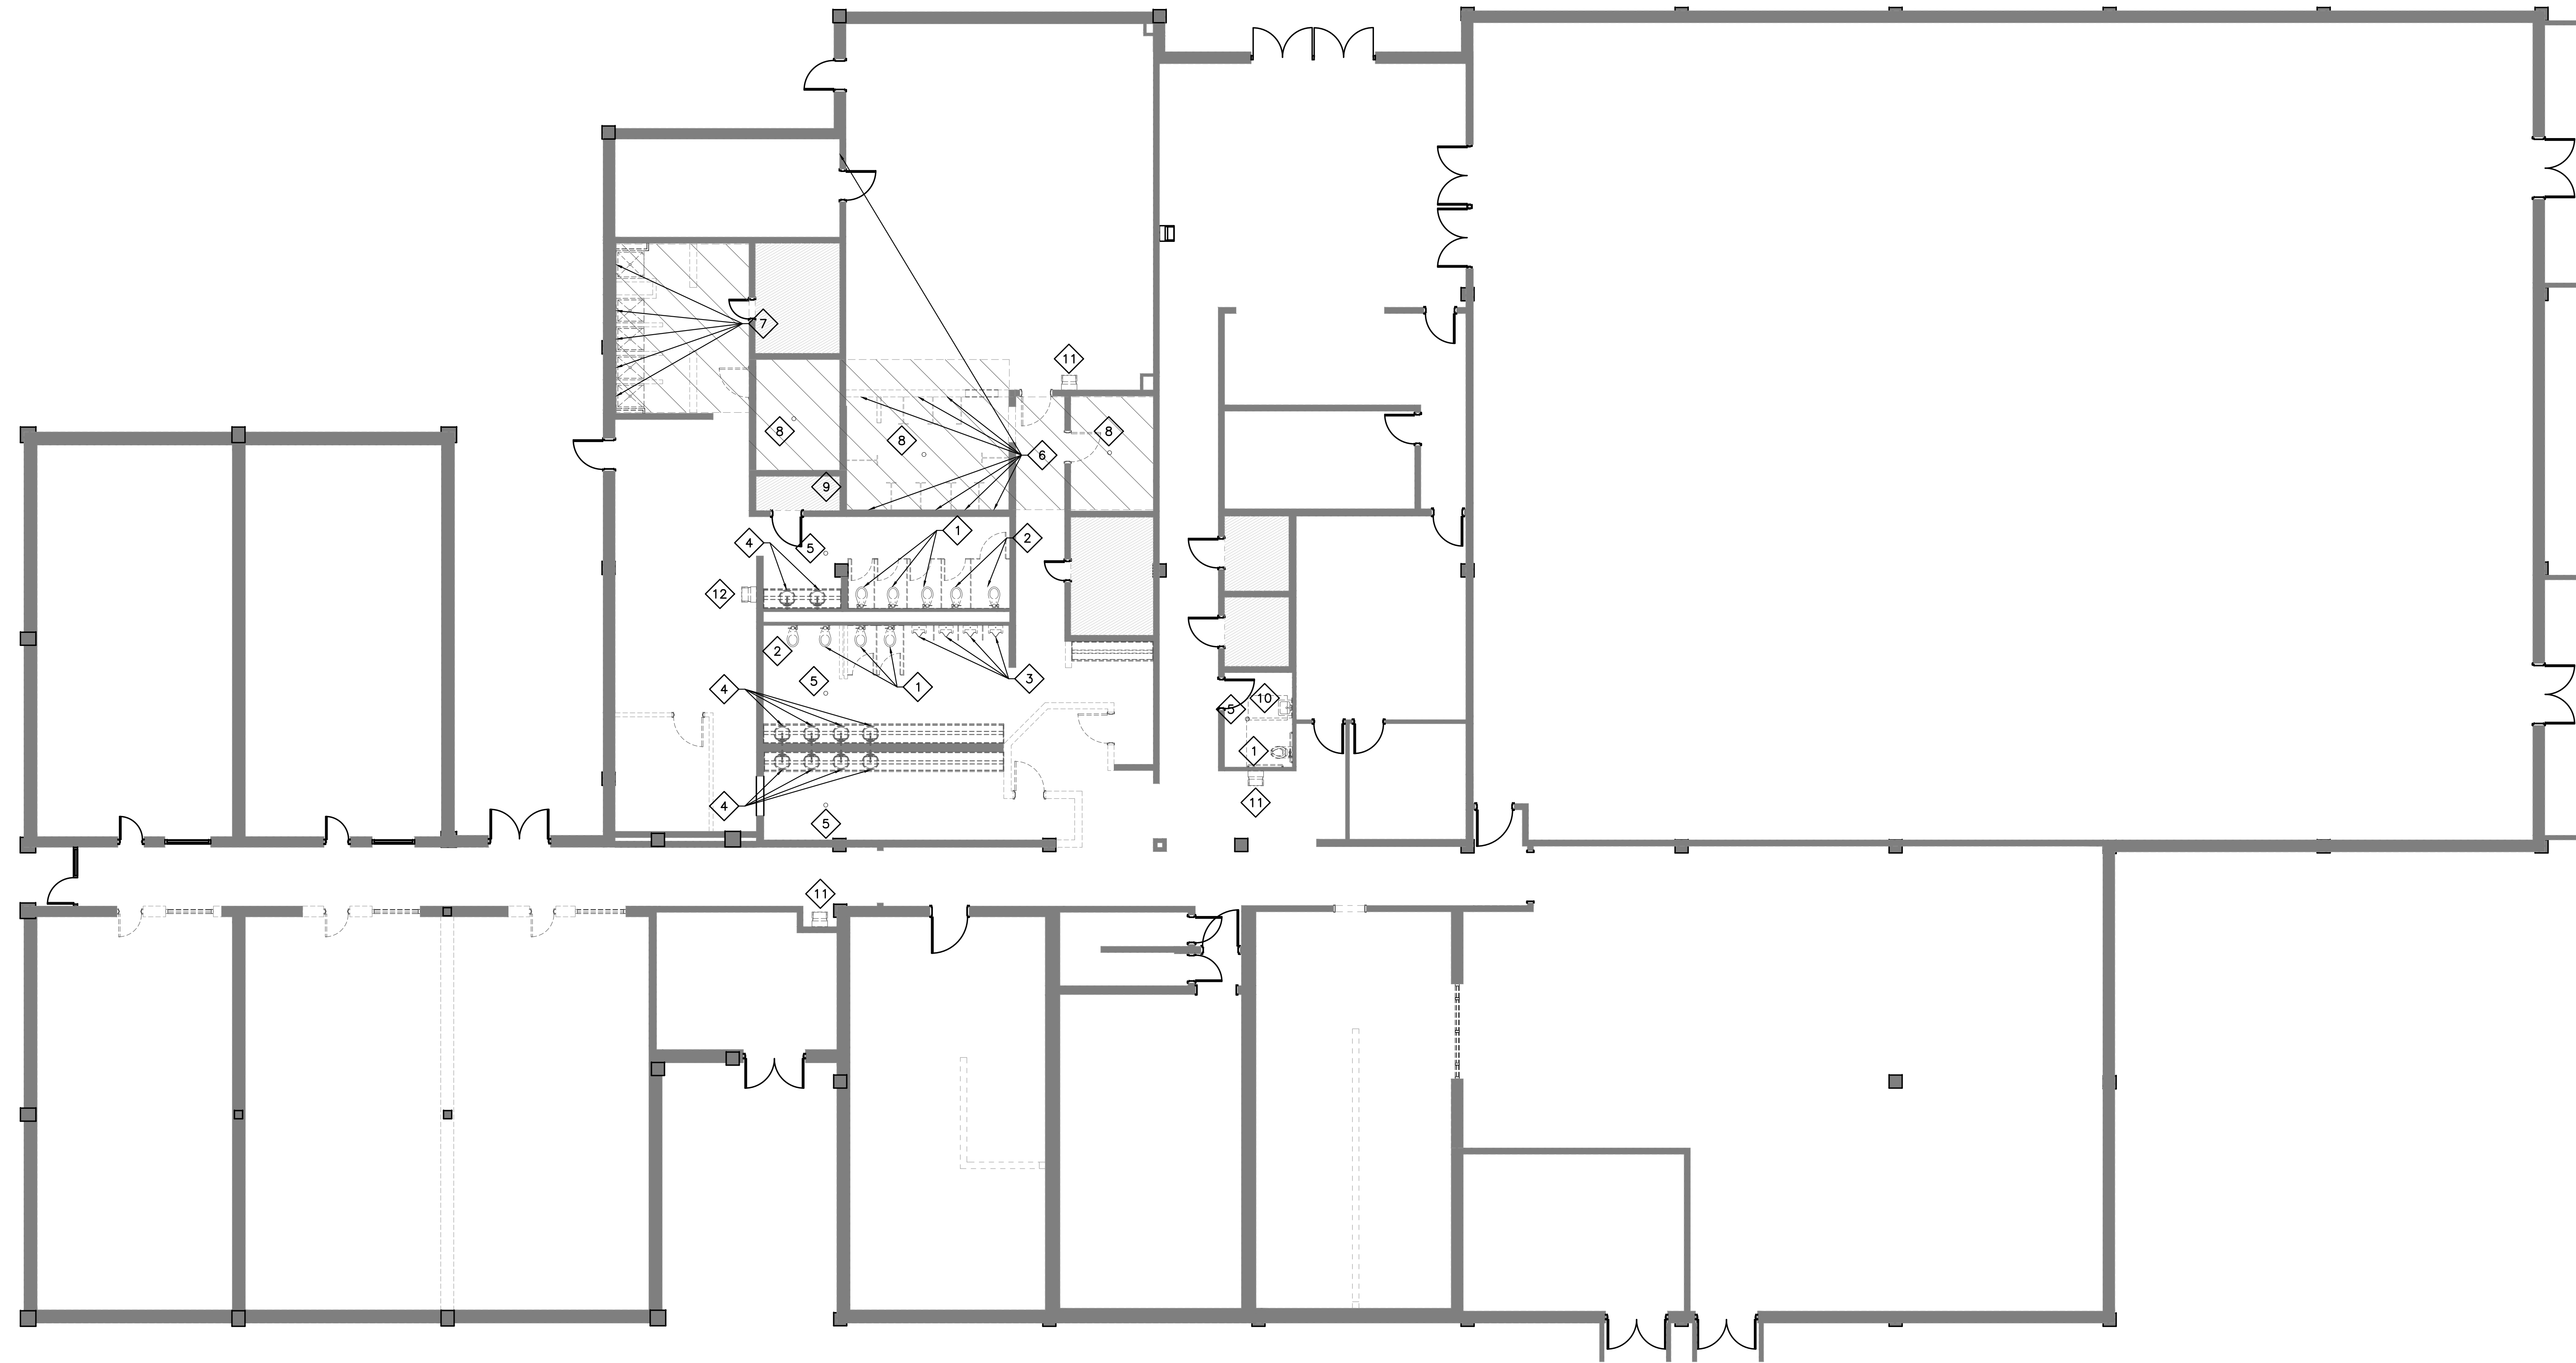**PLUMBING DEMO PLAN**


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**P100**

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**1 PLUMBING DEMO PLAN**  
SCALE: 1/8"=1'-0"

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**MAHG 191089 REPAIR BLAKE GYM  
KEESLER AIR FORCE BASE**  
1201 H STREET, BLDG 1201  
KAFB - BILOXI, MS 39534

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**SANITARY SEWER PLAN**

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**P101**
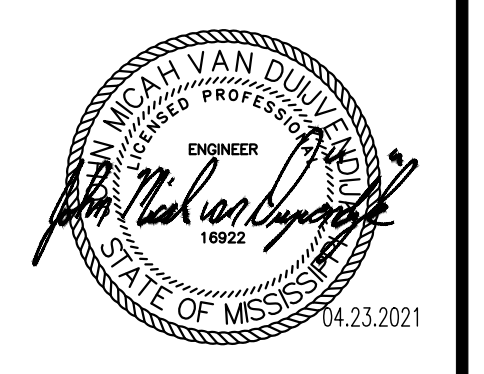
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- PLUMBING KEY NOTES**
- A** CONTRACTOR SHALL CONNECT NEW WATER CLOSET TO EXISTING SANITARY SEWER CONNECTION IN FLOOR. PATCH FLOOR AS NECESSARY TO MATCH SURROUNDINGS.
  - B** CONTRACTOR SHALL CONNECT NEW WATER CLOSET TO EXISTING SANITARY SEWER CONNECTION BELOW FLOOR. INSTALL OFFSET FLANGE/SAW CUT AS NECESSARY FOR ADA COMPLIANT CLEARANCES. PATCH FLOOR AS NECESSARY TO MATCH SURROUNDINGS.
  - C** CONTRACTOR SHALL CONNECT NEW INTEGRATED LAVATORY TO EXISTING 1-1/2" SANITARY SEWER CONNECTION AT EXISTING WALL.
  - D** CONTRACTOR SHALL INSTALL NEW ROUND STAINLESS STEEL GRATE ON EXISTING FLOOR DRAIN. VERIFY SIZE AND MODEL OF EXISTING PRIOR TO ORDERING. EXISTING FLOOR DRAIN SHALL BE CAPPED/COVERED DURING CONSTRUCTION AND THOROUGHLY CLEANED FOLLOWING CONSTRUCTION PRIOR TO INSTALLATION OF NEW GRATE.
  - E** CONTRACTOR SHALL CONNECT NEW WALL MOUNTED LAVATORY TO EXISTING 1-1/2" SANITARY SEWER CONNECTION AT EXISTING WALL.
  - F** CONTRACTOR SHALL CONNECT NEW WATER COOLER TO EXISTING SANITARY SEWER CONNECTION AT EXISTING WALL.
  - G** CONTRACTOR SHALL CONNECT NEW URINAL TO EXISTING 2" SANITARY SEWER CONNECTION AT EXISTING WALL.

- NOTES:**
- CONNECT ALL NEW VENTS TO EXISTING VENTS OF THE SAME SIZE OR LARGER.
  - SAW CUT EXISTING SLAB AS NECESSARY FOR NEW SANITARY LINES. PATCH AND FILL TO MATCH EXISTING FLOOR.

RECESS FLOOR AS NECESSARY FOR ADA INSTALLATION. COORDINATE WITH GC.



**1 SANITARY SEWER PLAN**  
SCALE: 1/8"=1'-0"

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**1 DOMESTIC WATER PLAN**  
 SCALE: 1/8"=1'-0"

PLUMBING KEY NOTES	
<b>A</b>	CONTRACTOR SHALL CONNECT NEW WATER CLOSET TO EXISTING DCW LINE CONNECTION AT EXISTING WALL.
<b>B</b>	CONTRACTOR SHALL CONNECT NEW INTEGRAL LAVATORY TO EXISTING DCW LINE CONNECTION AT EXISTING WALL.
<b>C</b>	CONTRACTOR SHALL CONNECT NEW WALL MOUNTED LAVATORY TO EXISTING DCW LINE CONNECTION AT EXISTING WALL.
<b>D</b>	CONTRACTOR SHALL CONNECT NEW URINAL TO EXISTING DCW LINE CONNECTION AT EXISTING WALL.
<b>E</b>	CONTRACTOR SHALL CONNECT NEW WATER COOLER TO EXISTING DCW LINE CONNECTION AT EXISTING WALL.

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 ARCHITECTURE  
 Bradford A. Jones, Architect

**MAHG 191089 REPAIR BLAKE GYM  
 KEESLER AIR FORCE BASE**  
 1201 H STREET, BLDG 1201  
 KAFB - BILOXI, MS 39534

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PROJECT NO.:	0110.20.002
DRAWN BY:	TJA
CHECKED BY:	JMV

**DOMESTIC WATER PLAN**

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<b>P102</b>		
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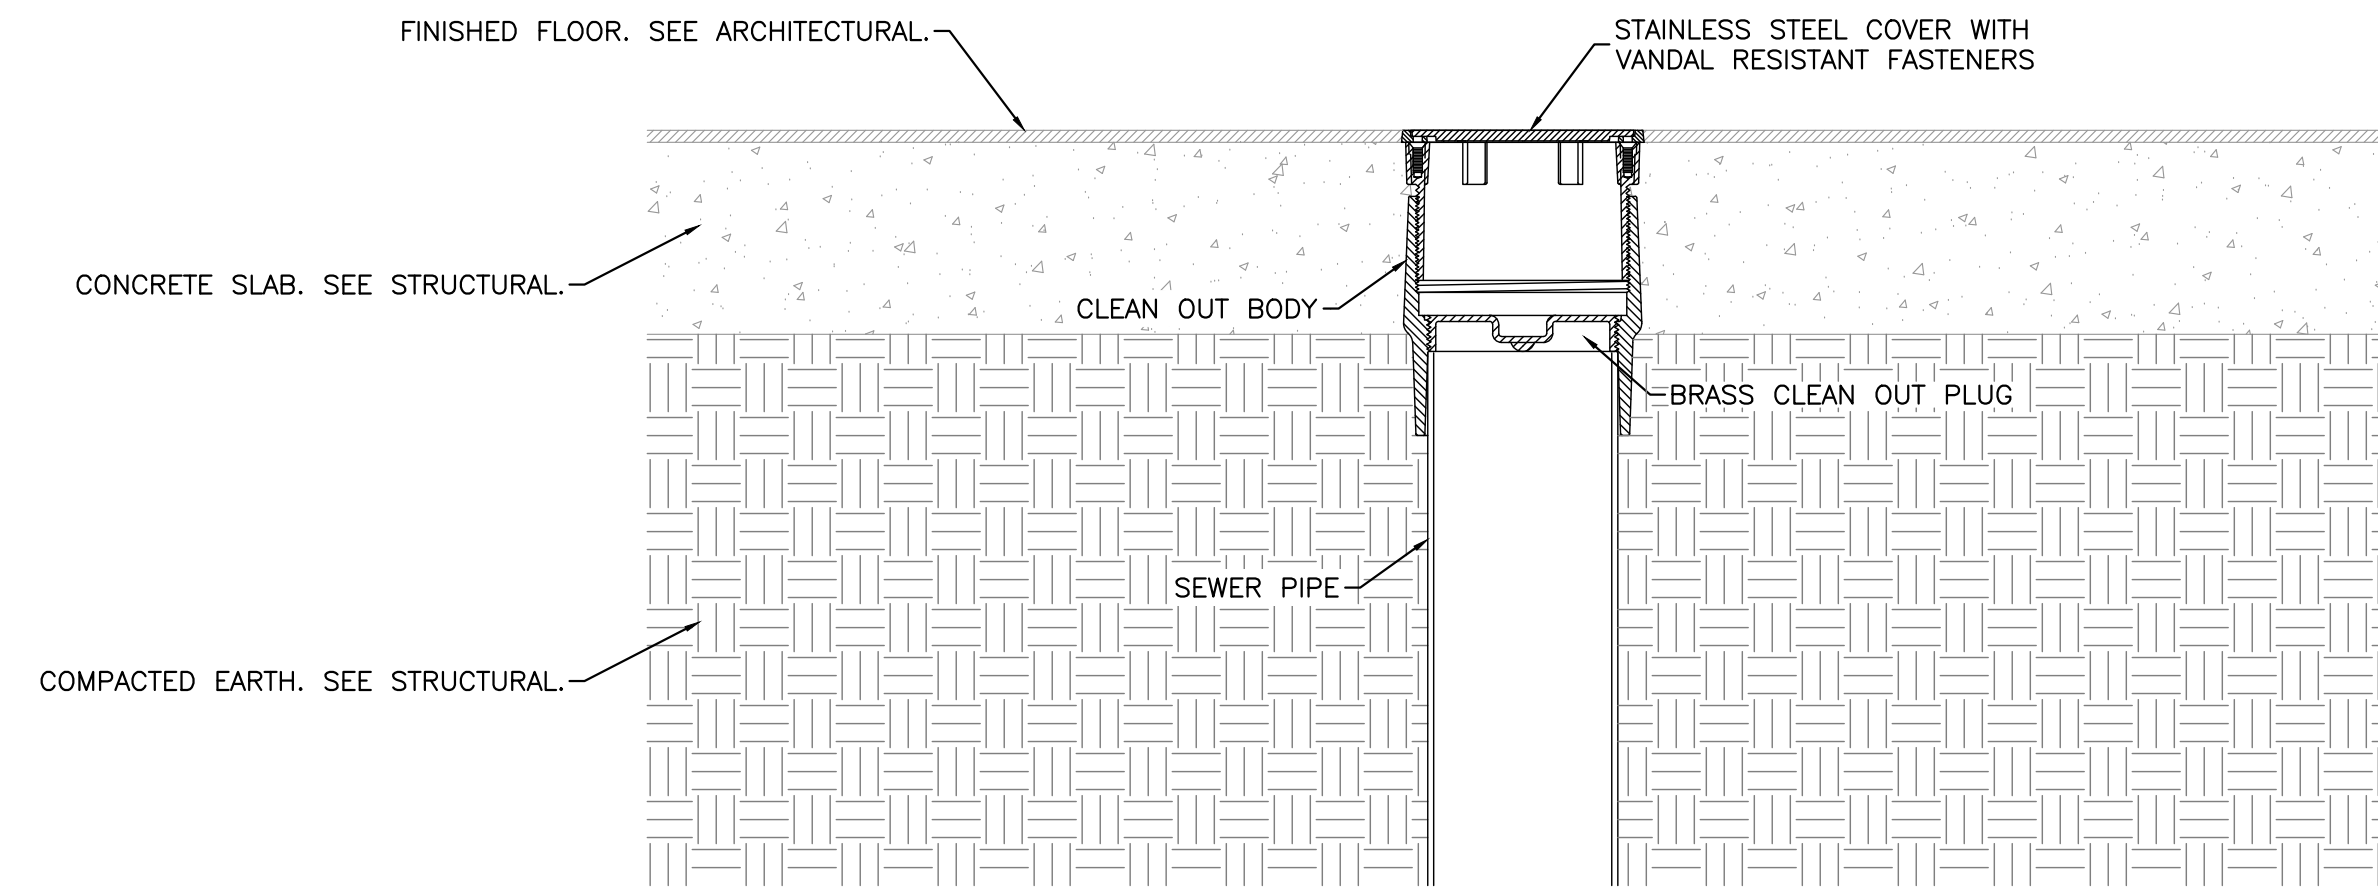
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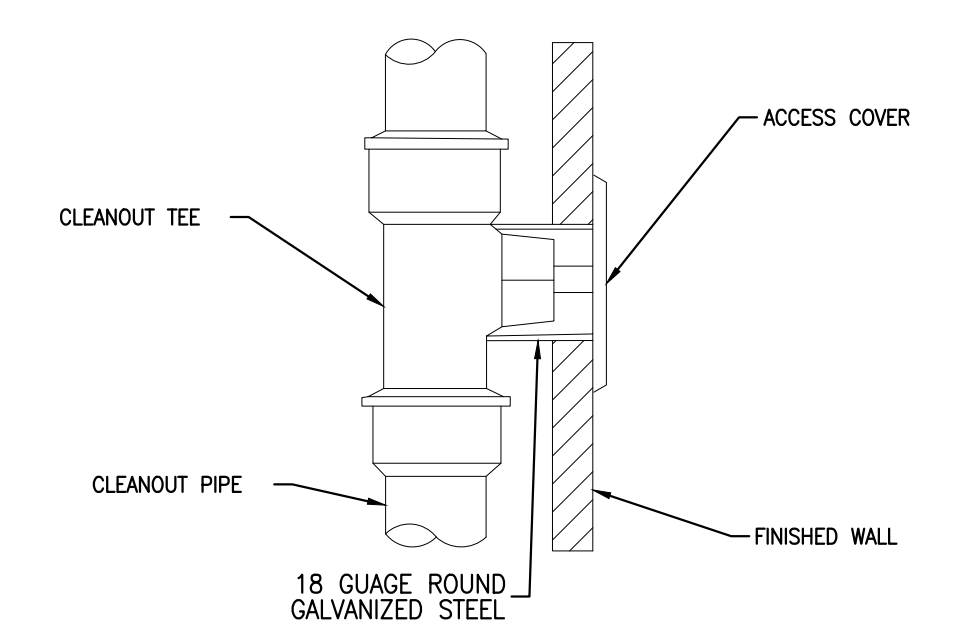
PLUMBING FIXTURE SCHEDULE								
TAG	DESCRIPTION	MAKE	MODEL	CONNECTIONS				NOTES
				CW	HW	TW	D	
P-1	ADA FLOOR MOUNT WATER CLOSET-FV	AMERICAN STANDARD	3043.001	1"	N/A	N/A	3"	1,2,3,4,5,29
P-2	ADA WALL MOUNT LAVATORY	AMERICAN STANDARD	0356.421	1/2"	1/2"	N/A	1-1/4"	1,5,6,7,8,9,10,20,29
P-3	FLOOR DRAIN	ZURN	ZS415B-SZ1-TSP	N/A	N/A	N/A	3"	5,14,15,29
P-4	ADA FORMED LAVATORY	INPRO	-	1/2"	1/2"	N/A	1-1/4"	1,5,6,7,8,9,10,29
P-5	FLOOR MOUNT WATER CLOSET-FV	AMERICAN STANDARD	3043.001	1"	N/A	N/A	3"	2,3,4,5,15,29
P-6	URINAL-FV	AMERICAN STANDARD	6590.001	3/4"	N/A	N/A	2"	17,19,29
P-7	32"x32" CUSTOM SHOWER	INPRO	-	1/2"	N/A	N/A	2"	25,26,29,30
P-8	ADA HI/LO WATER COOLER	ELKAY	EMABFLBWSLK	1/2"	N/A	N/A	1-1/2"	1,12,16,17,18,29
P-9	SINGLE WATER COOLER	ELKAY	EMABFWSLK	1/2"	N/A	N/A	1-1/4"	12,15,16,17,25,29
P-10	ADA URINAL-FV	AMERICAN STANDARD	6590.001	3/4"	N/A	N/A	2"	1,17,19,29
P-11	ADA 36"x60" CUSTOM SHOWER	INPRO	-	1/2"	1/2"	N/A	2"	1,24,25,27,29,31
P-12	ADA 36"x36" CUSTOM SHOWER	INPRO	-	1/2"	1/2"	N/A	2"	1,24,25,28,29,31
4" WCO	4" WALL CLEAN OUT	ZURN	Z1446-BP	N/A	N/A	N/A	4"	21,22,23,29
4" FCO	4" FLOOR CLEAN OUT	ZURN	ZS1400-B-BP	N/A	N/A	N/A	4"	21,22,29

1 MOUNT WITH ADA CLEARANCES	2 WITH TOTO TET1LA32#CP FLUSH VALVE OR APPROVED EQUAL
3 WITH CHURCH 295SSCT SEAT OR APPROVED EQUAL	4 COORDINATE RIGHT OR LEFT FLUSH VALVE LEVER INSTALLATION WITH ADA (OPEN SIDE)
5 OR APPROVED EQUAL	6 WITH ADA GRID STRAINER
7 WITH 1-1/4" 17 GAUGE P-TRAP	8 WITH BALL STOPS AND RIGID SUPPLIES
9 WITH ADA TRAP, STOP, AND SUPPLY PROTECTORS	10 WITH TOTO TEL105-D10ET (WITH INTEGRATED MIXING VALVE) FAUCET (ASSE 1070 COMPLIANT) OR APPROVED EQUAL
11 WITH ZURN ZB43M-XL FAUCET	12 WITH BOTTLE FILLER
13 WITH DOME STRAINER	14 WITH ASSE 1072 TRAP SEAL PROTECTION DEVICE
15 MOUNT WITH STANDARD CLEARANCES	16 WITH CONCEALED SUPPORT CARRIER
17 WITH TOTO TEU1LA12#CP SENSOR FLUSH VALVE OR APPROVED EQUAL	18 WITH CANE APRON
19 WITH ZURN VERTICAL CARRIER SYSTEM OR APPROVED EQUAL	20 WITH ZURN CARRIER SYSTEM OR APPROVED EQUAL
21 WITH BRONZE PLUG	22 WITH ROUND STAINLESS STEEL TOP
23 CAP OPEN END AS NECESSARY	24 WITH ZURN Z7000-HW3 ADA SHOWER FAUCET
25 WITH ZURN Z7301-SS-MT-S9-PEX SHOWER FAUCET	26 WITH STAINLESS STEEL LINEAR SHOWER DRAIN, STANDARD SLOTTED GRATE
27 WITH ADA STAINLESS STEEL LINEAR SHOWER DRAIN, STANDARD SLOTTED GRATE	28 WITH ADA STAINLESS STEEL LINEAR SHOWER DRAIN, STANDARD SLOTTED GRATE
29 OR EQUAL	30 INCLUDE BASE AND WALLS
31 INCLUDE BASE, WALLS, GRAB BARS, AND ALL ADA ACCESSORIES	



1 FLOOR CLEANOUT DETAIL  
SCALE: NTS



2 WALL CLEANOUT DETAIL  
SCALE: NTS

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**PLUMBING SCHEDULE & DETAILS**

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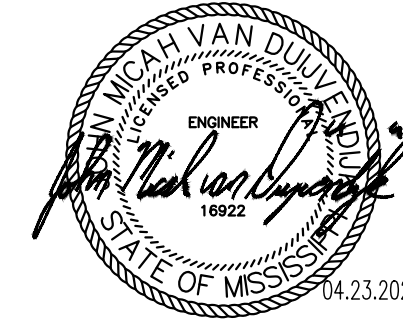


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HVAC ABBREVIATIONS	
A	AMPS
AC	AIR CONDITIONING
AFF	ABOVE FINISHED FLOOR
AHU	AIR HANDLING UNIT
AL	ALUMINUM
B	
BDD	BACKDRAFT DAMPER
BOD	BOTTOM OF DUCT
C	
CEF	CEILING EXHAUST FAN
CFH	CUBIC FEET PER HOUR
CFM	CUBIC FEET PER MINUTE
CHW	CHILLED WATER
CHWR	CHILLED WATER RETURN
CHWS	CHILLED WATER SUPPLY
CU	CONDENSING UNIT
CW	CONDENSER WATER
CWS	CONDENSER WATER SUPPLY
CWR	CONDENSER WATER RETURN
D	
DC	DIRECT CURRENT
E	
E	EXISTING
EA	EXHAUST AIR
EC	ELECTRICAL CONTRACTOR
EF	EXHAUST FAN
ESP	EXTERNAL STATIC PRESSURE
F	
FC	FAN COIL
FD	FIRE DAMPER
FSD	COMBINATION FIRE/SMOKE DAMPER
FT	FOOT/FEET
G	
GA	GAUGE
GC	GENERAL CONTRACTOR
GFM	GLASS FABRIC AND MASTIC
H	
HP	HORSEPOWER OR HEAT PUMP
HW	HOT WATER
HWR	HOT WATER RETURN
HWS	HOT WATER SUPPLY
K	
KW	KILOWATT
L	
LBS	POUNDS
M	
MAX	MAXIMUM
MBH	ONE THOUSAND BRITISH THERMAL UNITS PER HOUR
MC	MECHANICAL CONTRACTOR
MCA	MINIMUM CIRCUIT AMPACITY
MD	MOTORIZED DAMPER
MIN	MINIMUM
MOC	MAXIMUM OVERCURRENT PROTECTION
N	
NC/PO	NORMALLY CLOSED/POWERED OPEN
NIC	NOT IN CONTRACT
NIS	NEOPRENE IN SHEAR
NO/PC	NORMALLY OPEN/POWERED CLOSED
NTS	NOT TO SCALE
O	
OA	OUTDOOR AIR
OC	ON CENTER
P	
PC	PLUMBING CONTRACTOR
PH	PHASE
R	
RA	RETURN AIR
RGS	RIGID SEALED
RS	RUBBER IN SHEAR
RPM	REVOLUTIONS PER MINUTE
S	
SA	SUPPLY AIR
SOFT	SQUARE FEET
T	
TSP	TOTAL STATIC PRESSURE
TYP	TYPICAL
U	
UC	UNDERCUT DOOR
UL	UNDERWRITERS LABORATORIES
V	
V	VOLTAGE
VD	VOLUME DAMPER
VF	VERIFY IN FIELD
W	
W	WATT
WC	WATER COLUMN

HVAC SYMBOLS	
	SQUARE/RECTANGULAR SUPPLY DOWN
	SQUARE/RECTANGULAR SUPPLY UP
	ROUND SUPPLY DOWN
	ROUND SUPPLY UP
	SQUARE/RECTANGULAR RETURN DOWN
	SQUARE/RECTANGULAR RETURN UP
	ROUND RETURN DOWN
	ROUND RETURN UP
	SQUARE/RECTANGULAR EXHAUST DOWN
	SQUARE/RECTANGULAR EXHAUST UP
	ROUND EXHAUST DOWN
	ROUND EXHAUST UP
	SQUARE/RECTANGULAR ELBOW
	SQUARE/RECTANGULAR ELBOW WITH TURNING VANES
	ROUND MAIN WITH CONICAL TAKEOFF
	ROUND MAIN WITH CONICAL TEE
	SQUARE/RECTANGULAR MAIN WITH CONICAL TEE
	ROUND MAIN WITH 45° LATERAL WYE
	SQUARE/RECTANGULAR MAIN WITH 45° LEAD IN TAKEOFF
	ROUND ELBOW
	EXISTING DUCT TO BE REMOVED
	EXISTING DUCT TO REMAIN
	NEW DUCT
	FLEXIBLE DUCT
	MANUAL VOLUME DAMPER
	INTERNALLY INSULATED DUCT
	SQUARE/RECTANGULAR TO ROUND TRANSITION
	CONCENTRIC TRANSITION
	ECCENTRIC TRANSITION
	ROUND NECK CEILING AIR TERMINAL
	SQUARE/RECTANGULAR NECK CEILING AIR TERMINAL
	TRANSFER AIR PATH
	TIMECLOCK
	THERMOSTAT
	TEMPERATURE SENSOR
	HUMIDITY SENSOR
	DUCT SMOKE DETECTOR
	CONNECT TO EXISTING
	SWITCH
	MOTORIZED DAMPER
	FIRE DAMPER
	COMBINATION FIRE/SMOKE DAMPER
	SMOKE DAMPER
	BACKDRAFT DAMPER
	CAP AND SEAL
	FLEXIBLE CONNECTION

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 KEESLER AIR FORCE BASE**  
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 KAFB - BILOXI, MS 39534

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**MECHANICAL ABBREVIATIONS & SYMBOLS**


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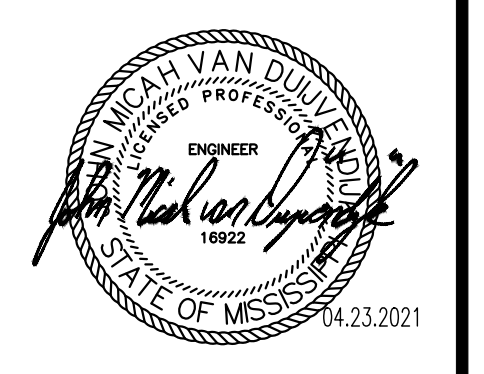
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1 MECHANICAL HVAC DEMOLITION PLAN  
 SCALE: 1/8"=1'-0"



**MAHG 191089 REPAIR BLAKE GYM**  
**KEESLER AIR FORCE BASE**  
 1201 H STREET, BLDG 1201  
 KAFB - BILOXI, MS 39534

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**MECHANICAL HVAC DEMOLITION PLAN**


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1 MECHANICAL PIPING DEMOLITION PLAN  
 SCALE: 1/8"=1'-0"
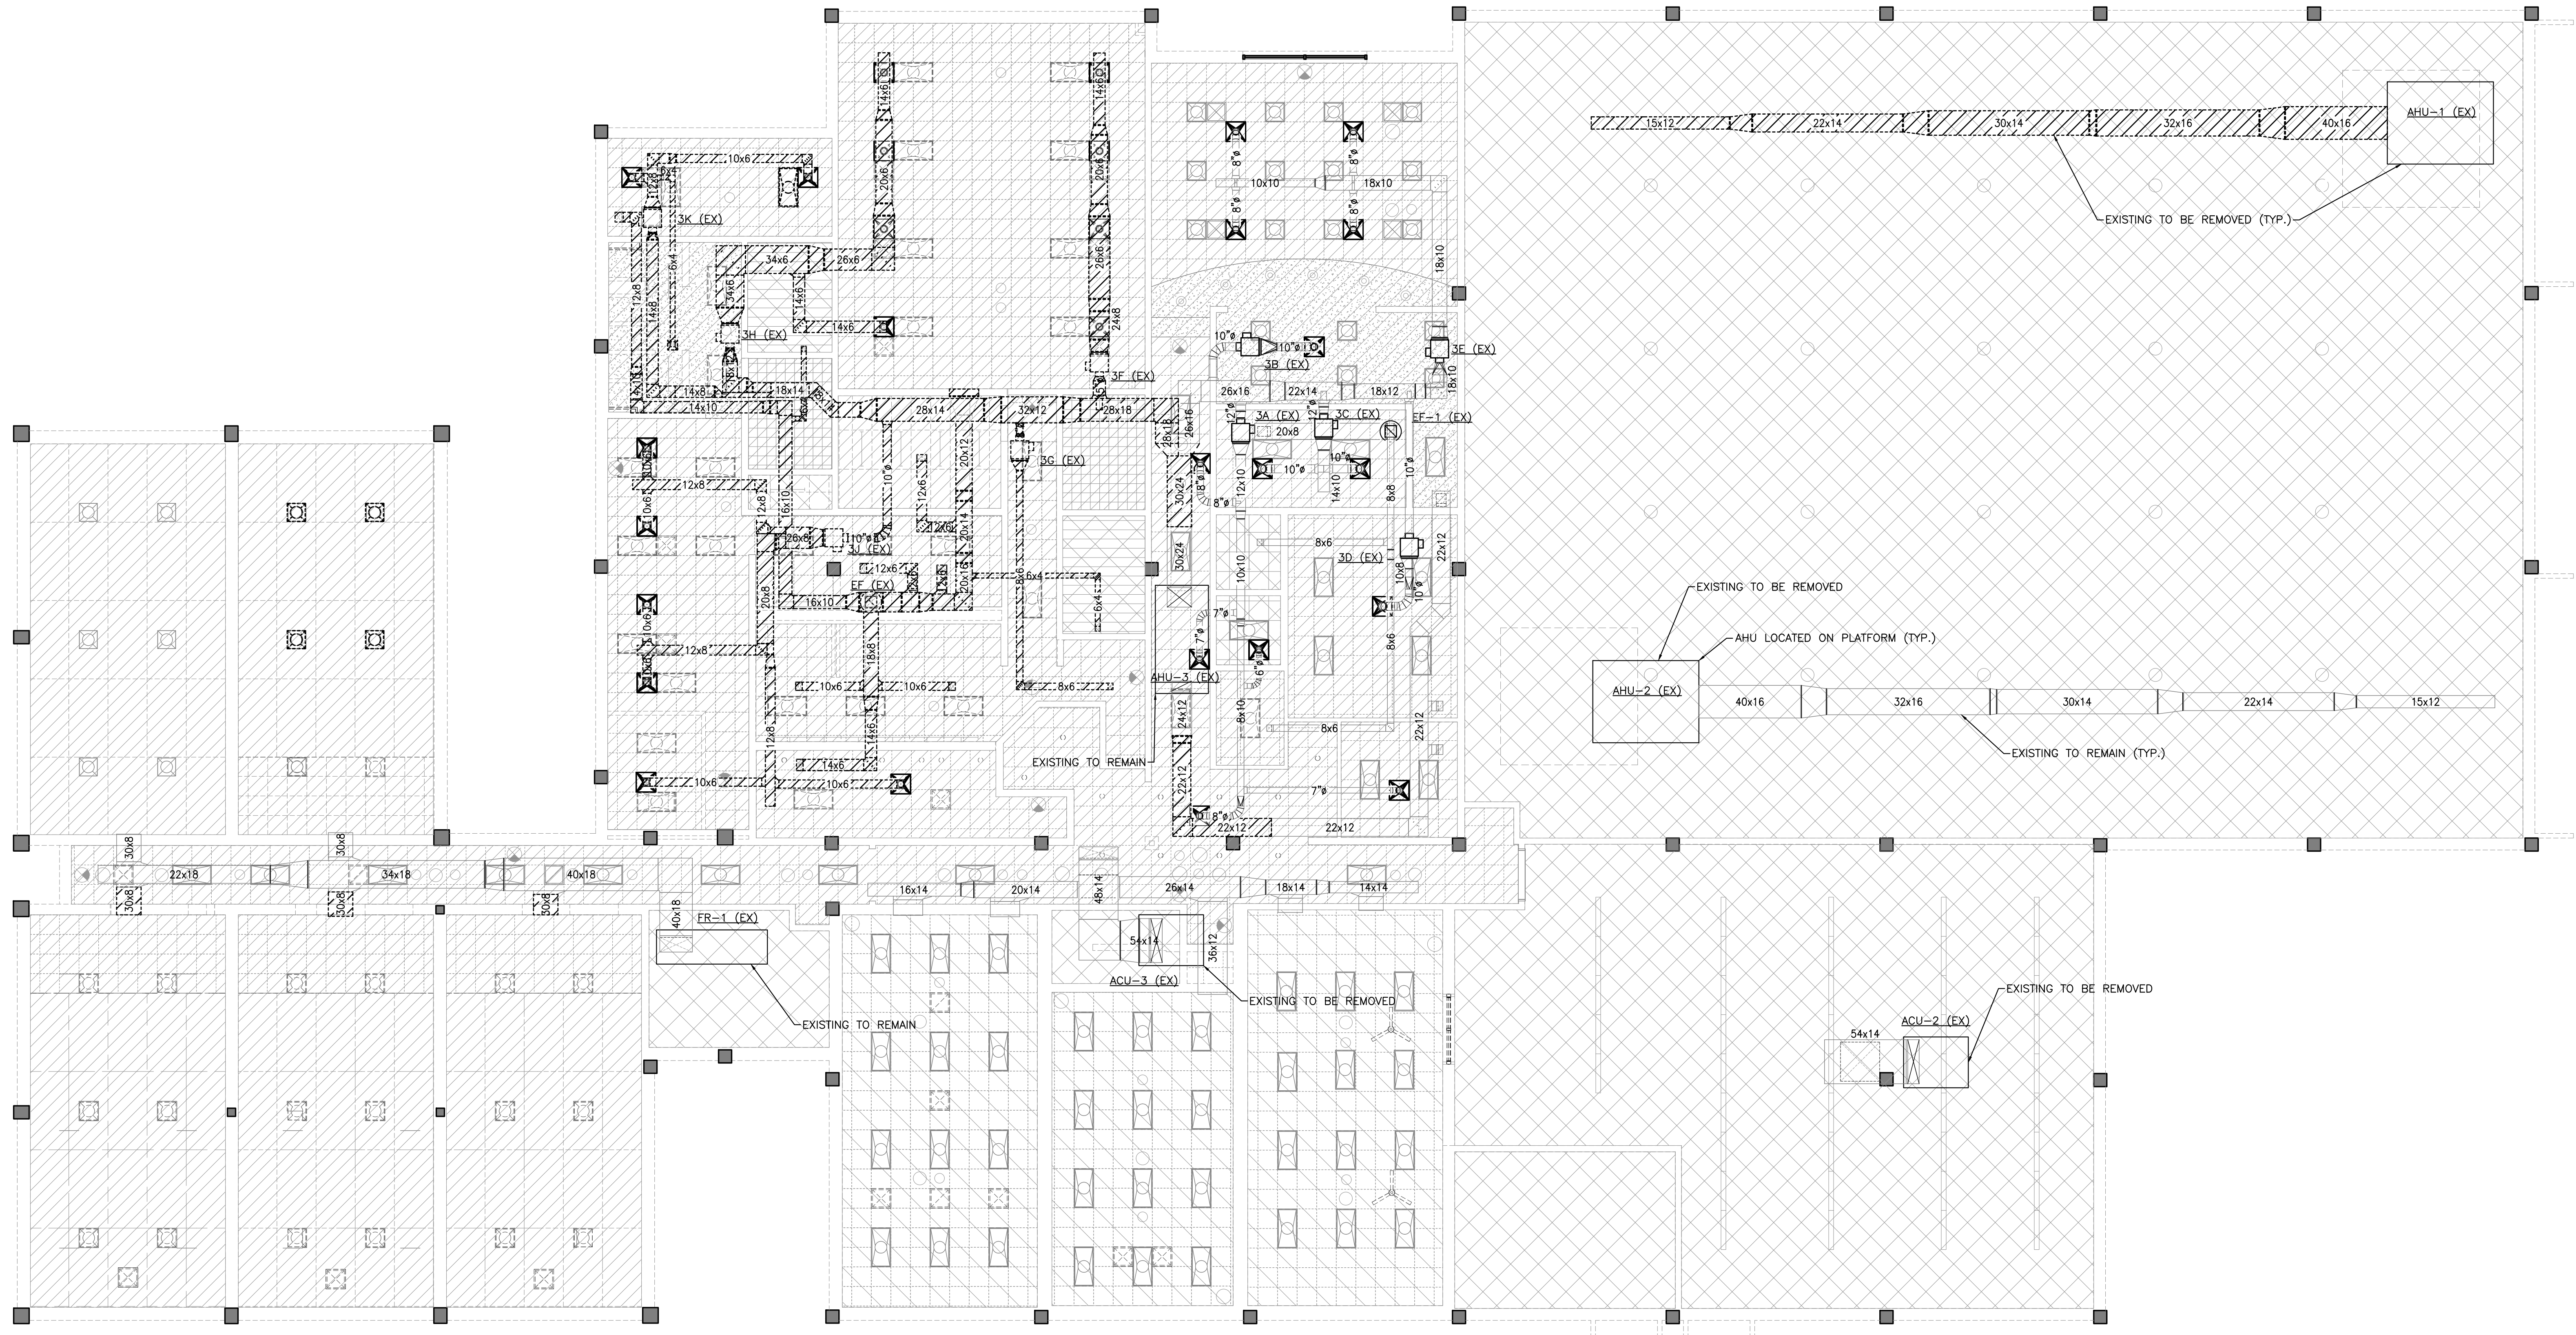
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MECHANICAL PIPING DEMOLITION PLAN


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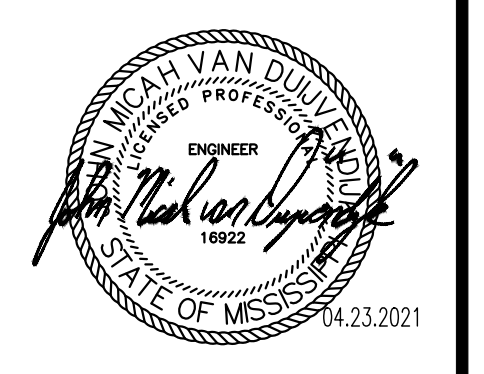
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1 MECHANICAL HVAC PLAN  
 SCALE: 1/8"=1'-0"



**MAHG 191089 REPAIR BLAKE GYM**  
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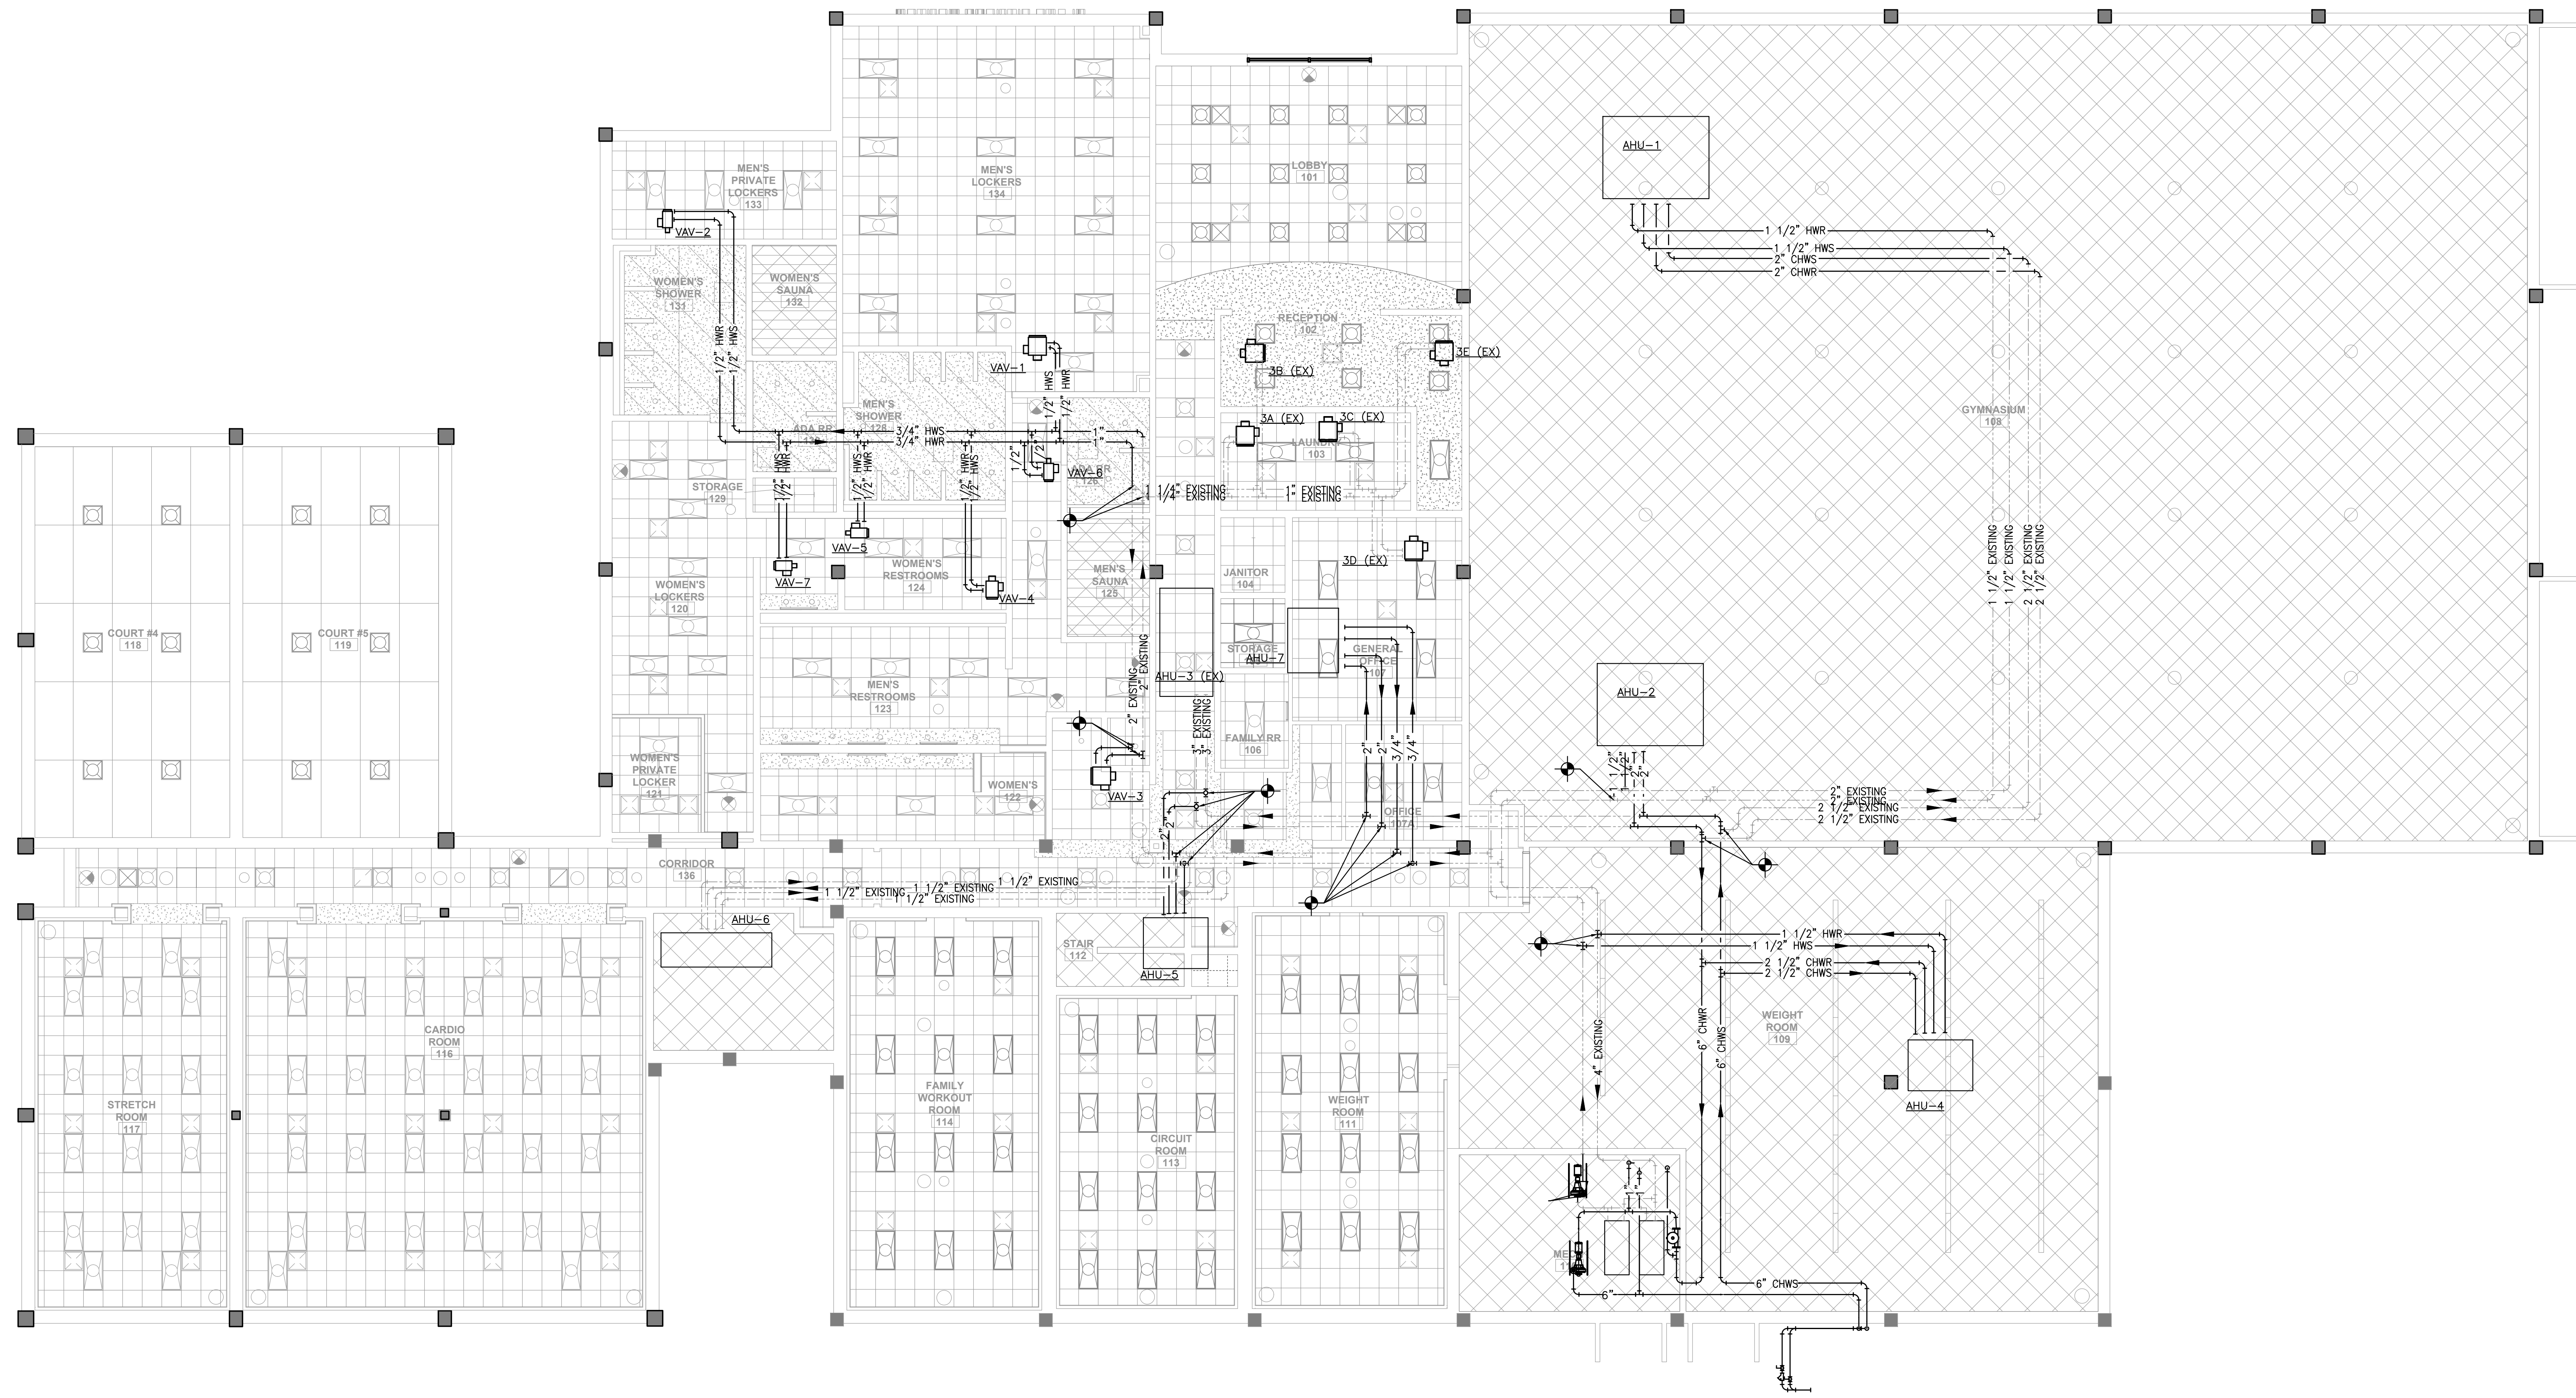
**MECHANICAL HVAC PLAN**
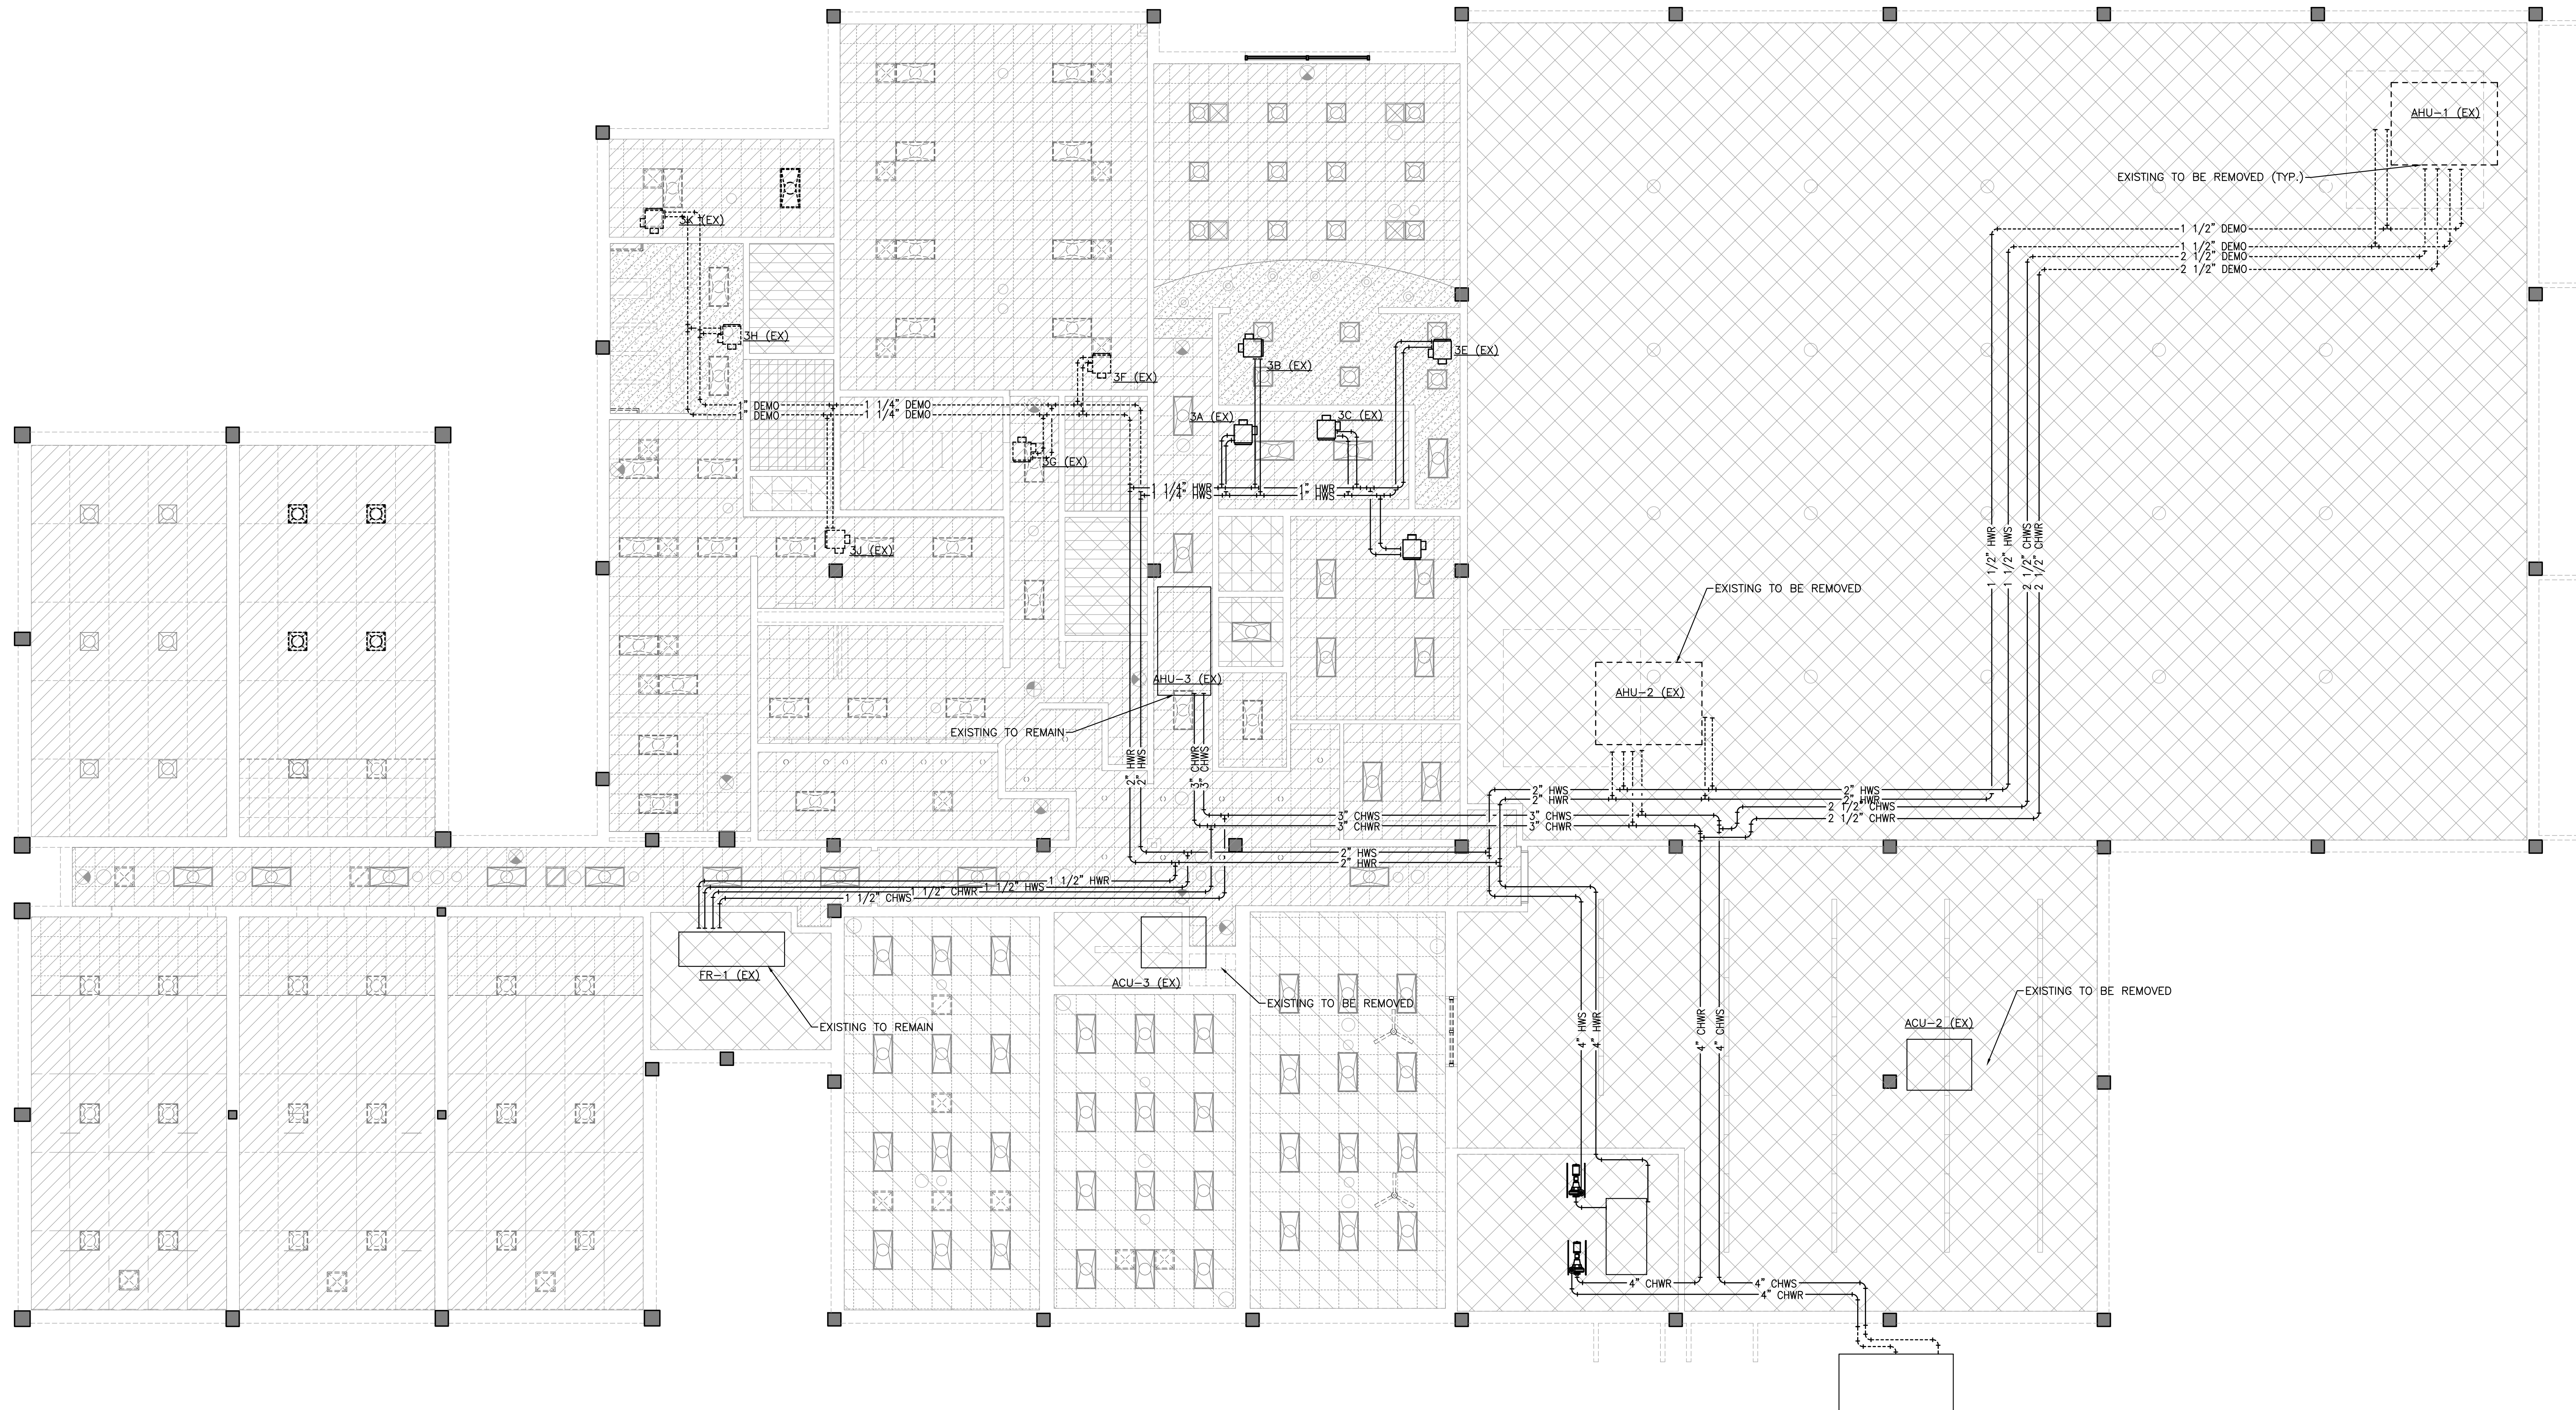
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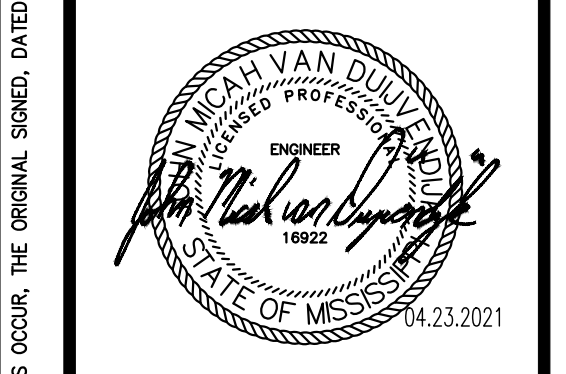
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1 MECHANICAL PIPING PLAN  
 SCALE: 1/8"=1'-0"

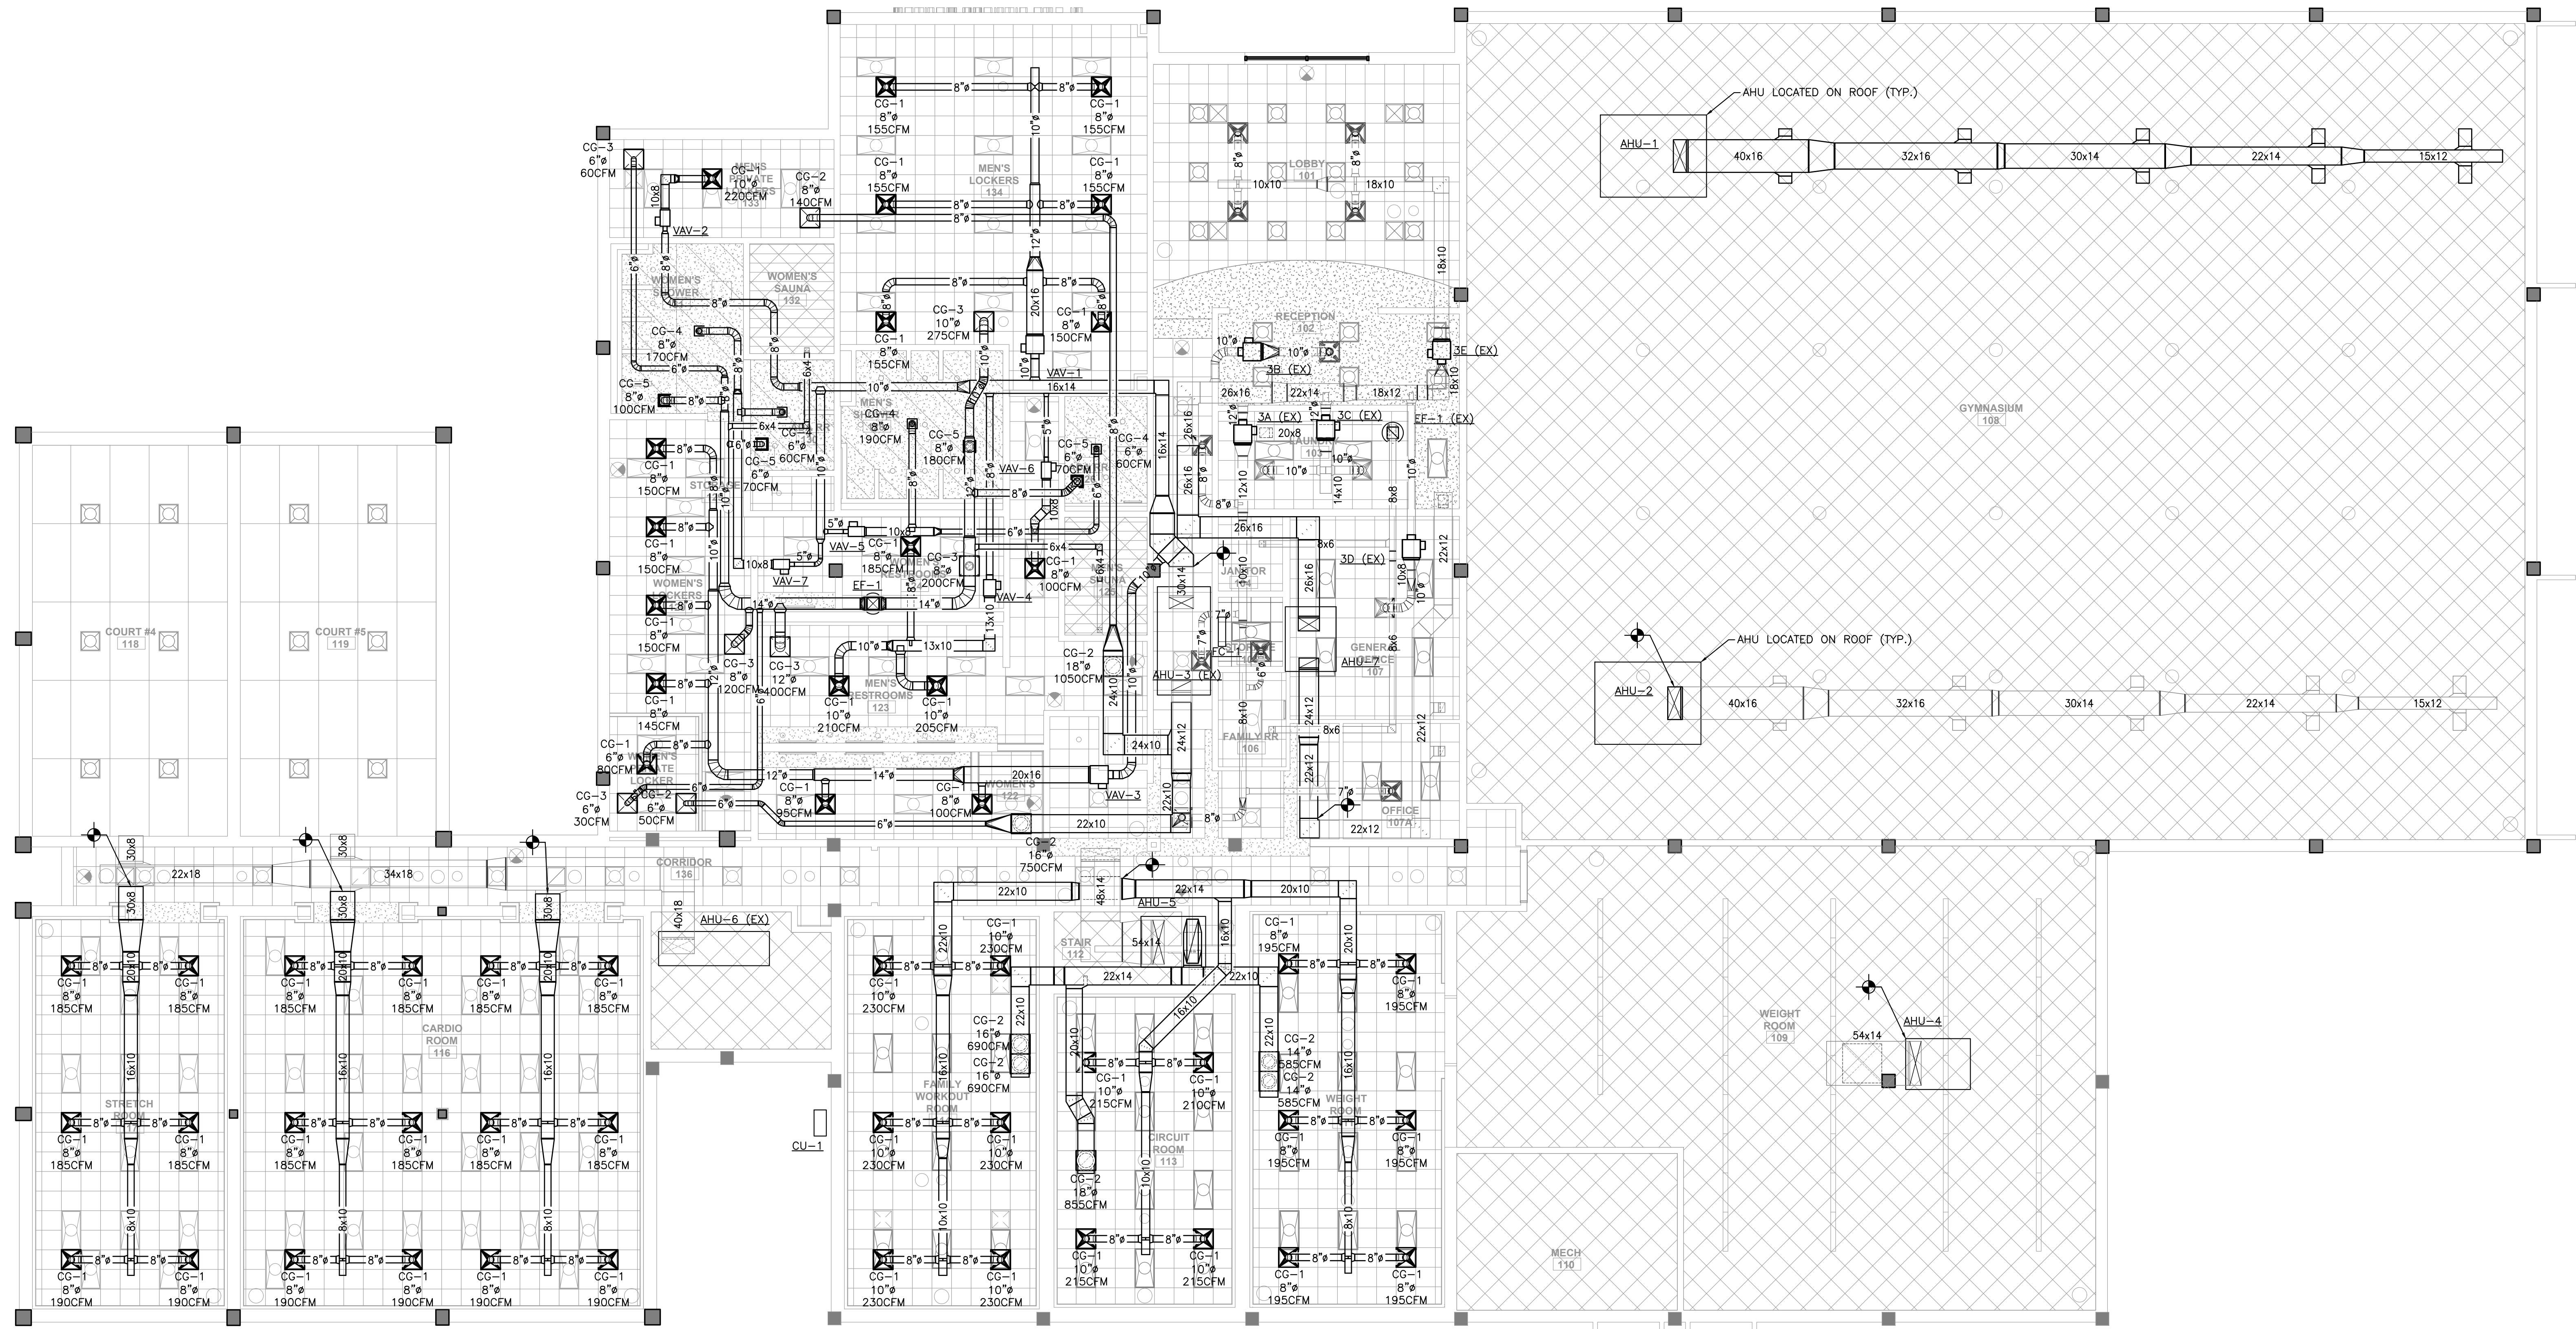

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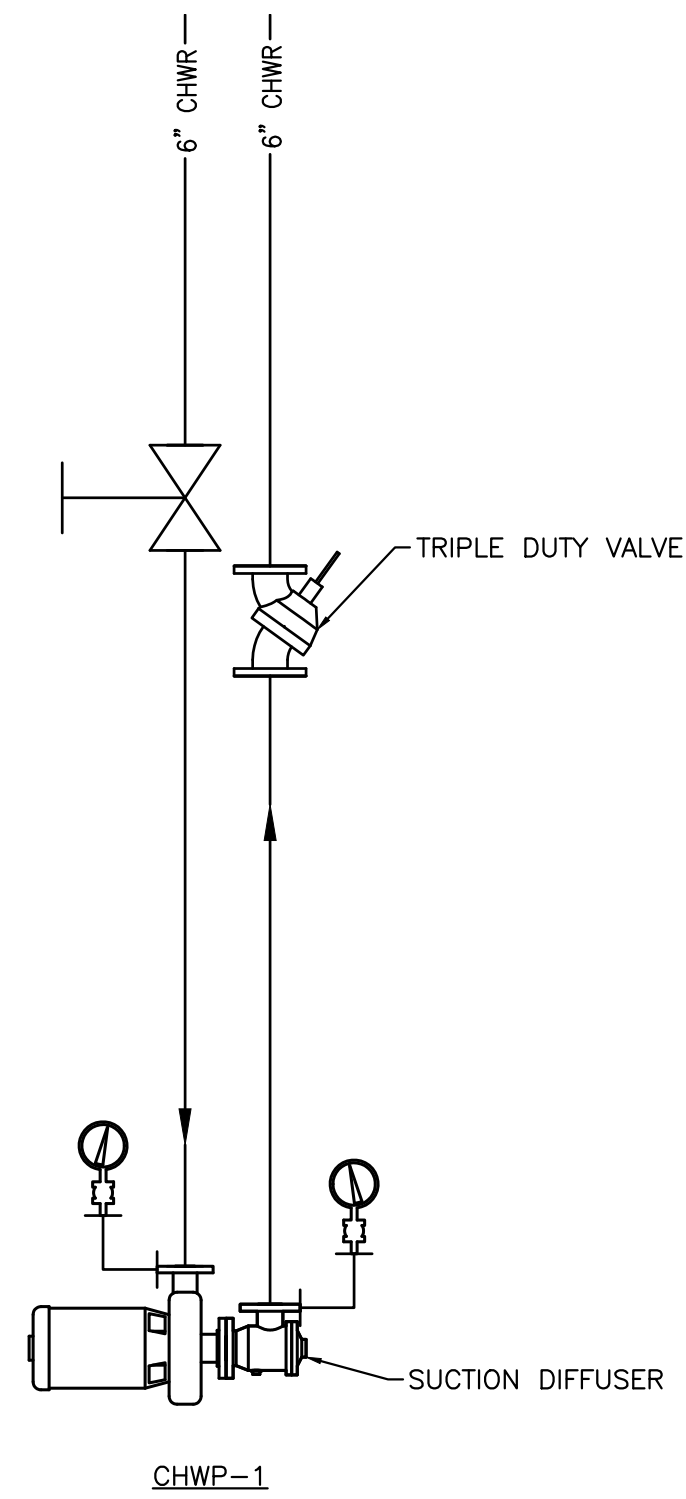
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**MECHANICAL PIPING PLAN**


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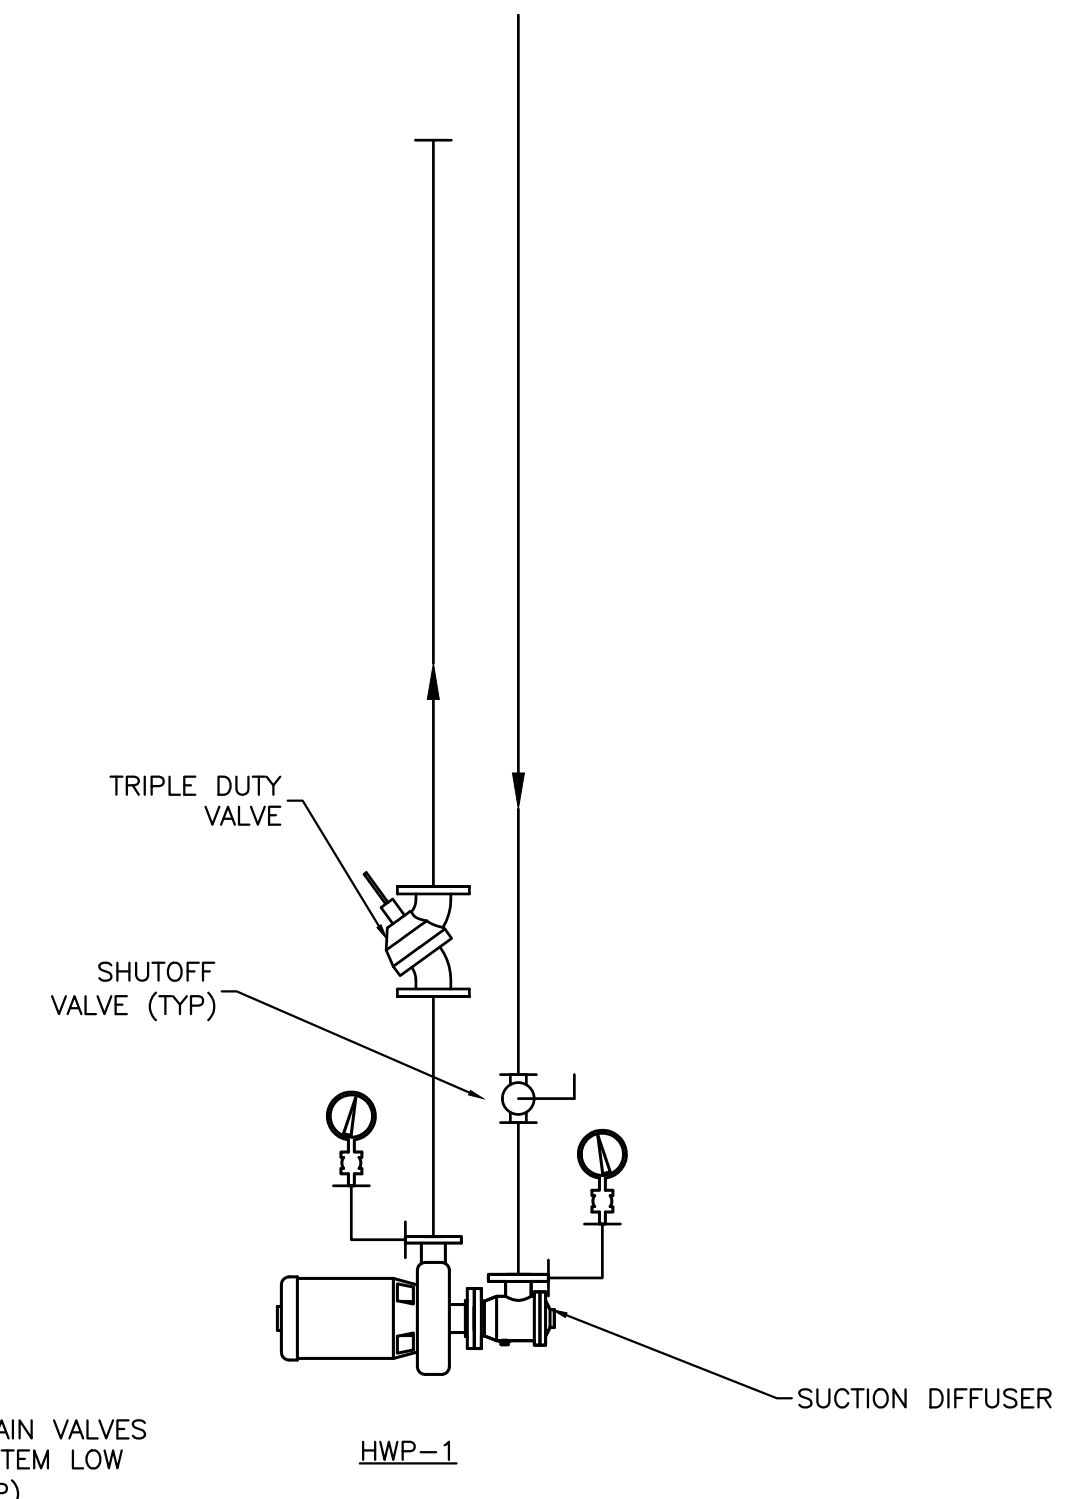
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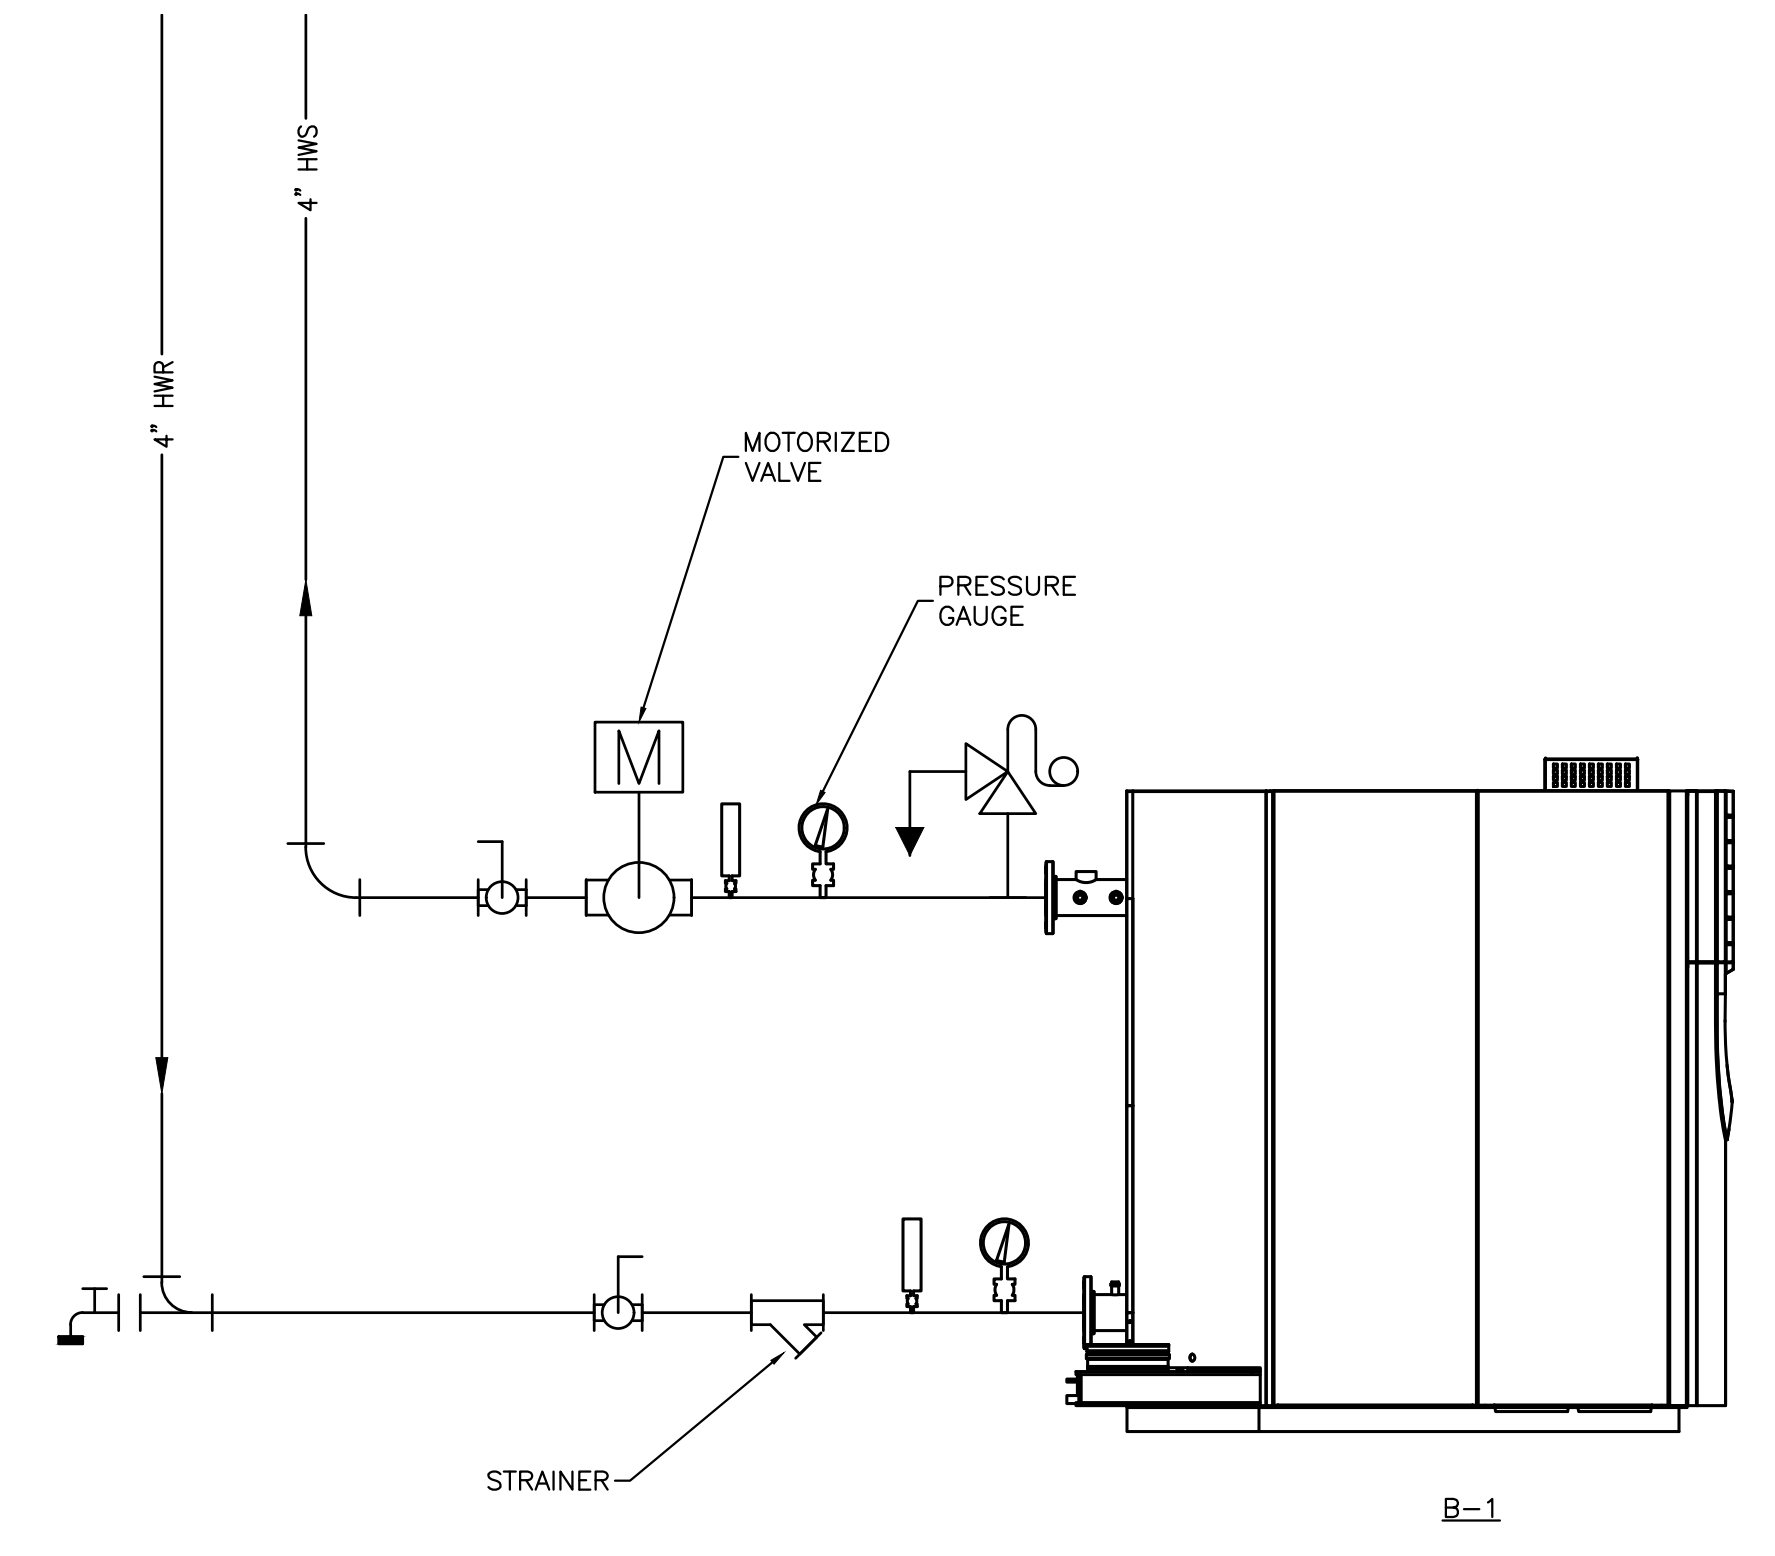
2 CHILLED WATER PUMP DETAIL  
SCALE: NTS




3 CHILLED DETAIL  
SCALE: NTS



4 HOT WATER PUMP DETAIL  
SCALE: NTS

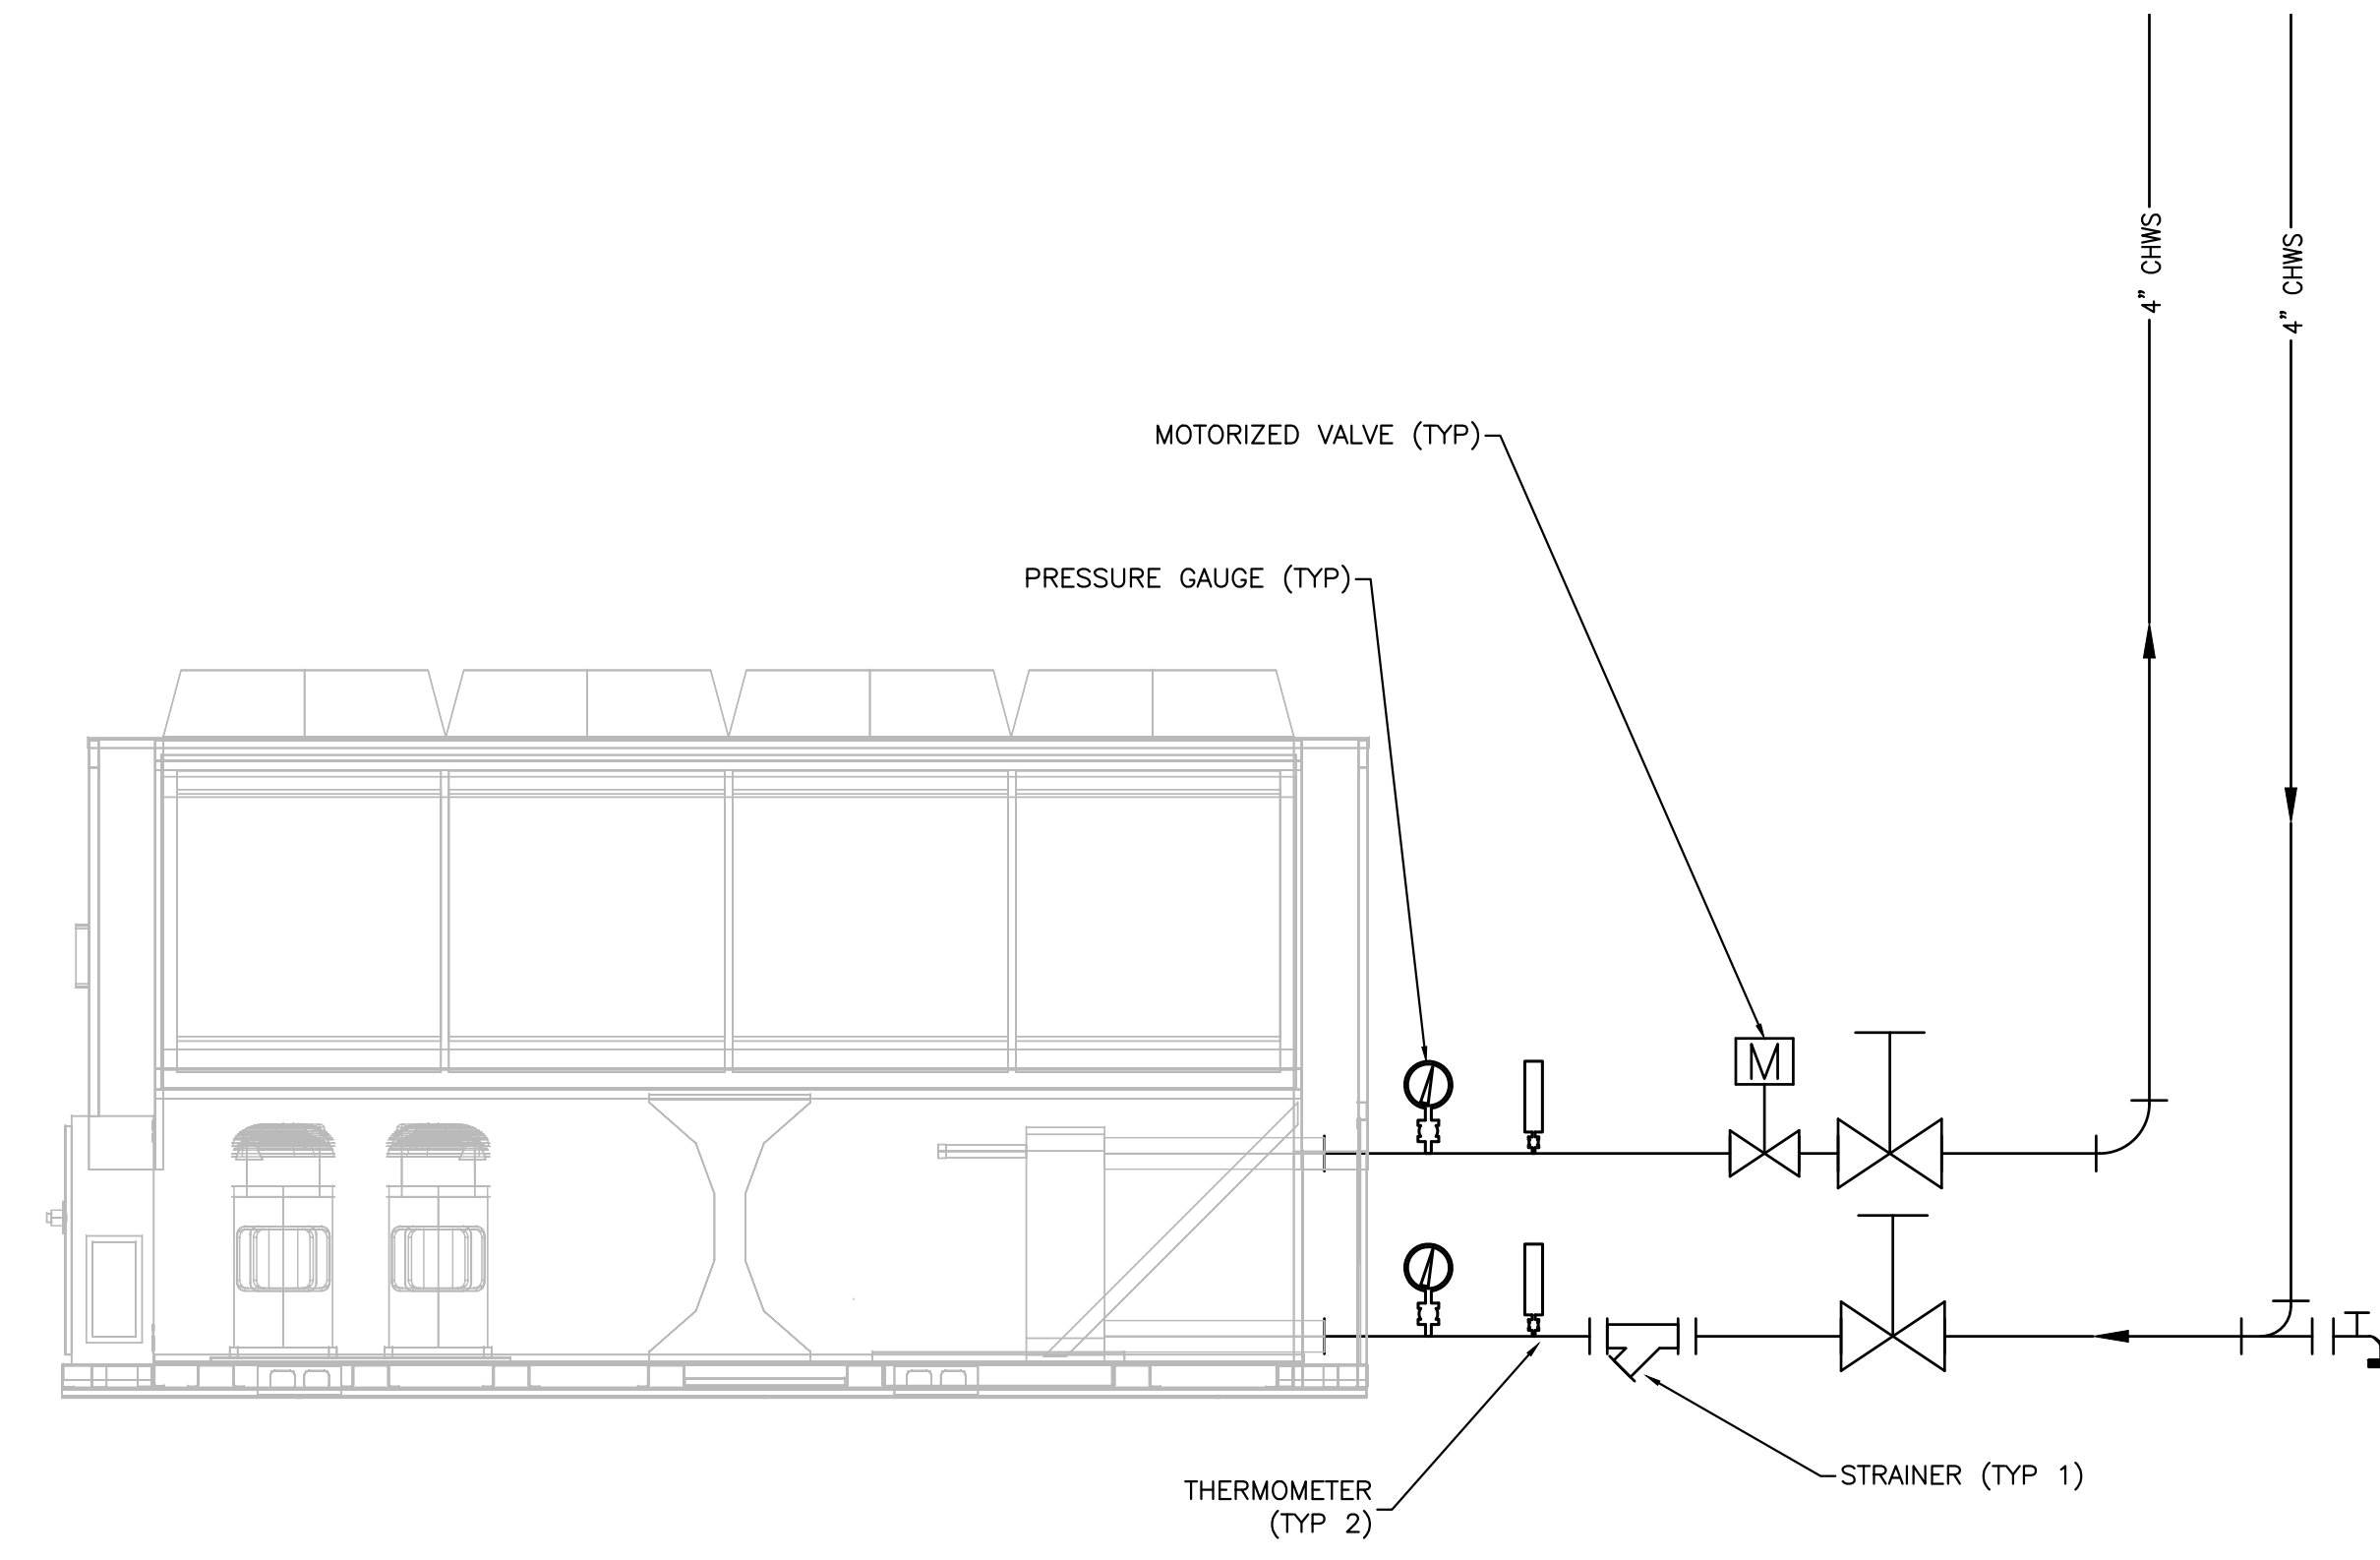

5 BOILER DETAIL  
SCALE: NTS

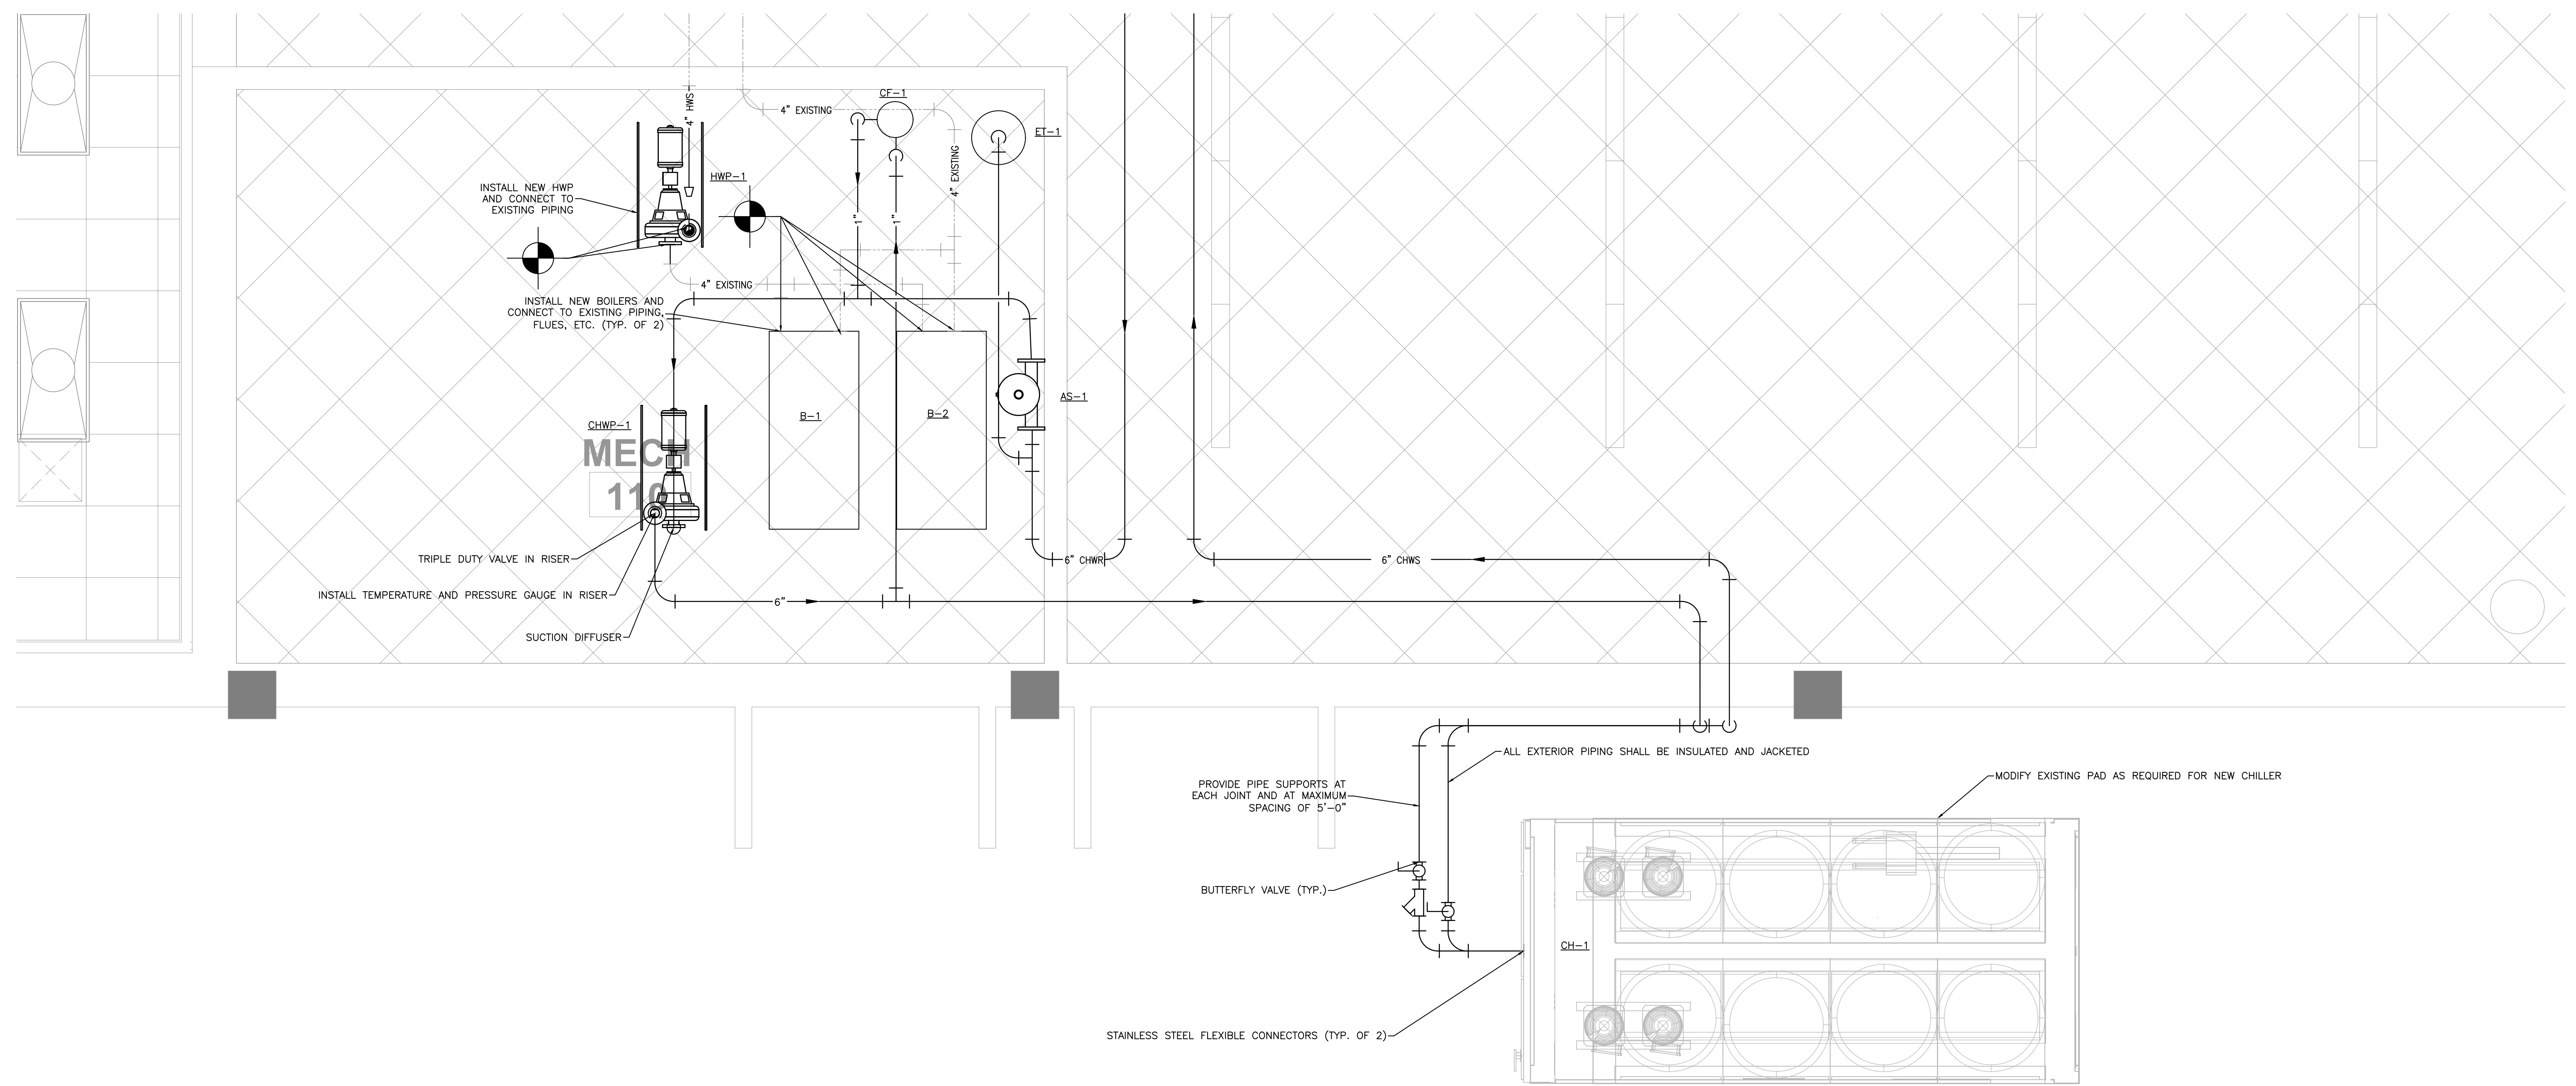

1 ENLARGED MECHANICAL ROOM  
SCALE: 1/2"=1'-0"

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ARCHITECTURE  
Bradford A. Jones, Architect

**MAHG 191089 REPAIR BLAKE GYM  
KEESLER AIR FORCE BASE**  
1201 H STREET, BLDG 1201  
KAFB - BILOXI, MS 39534

SCALE:	AS INDICATED
PROJECT NO.:	0110.20.002
DRAWN BY:	TJA
CHECKED BY:	IMV

ENLARGED MECHANICAL ROOM


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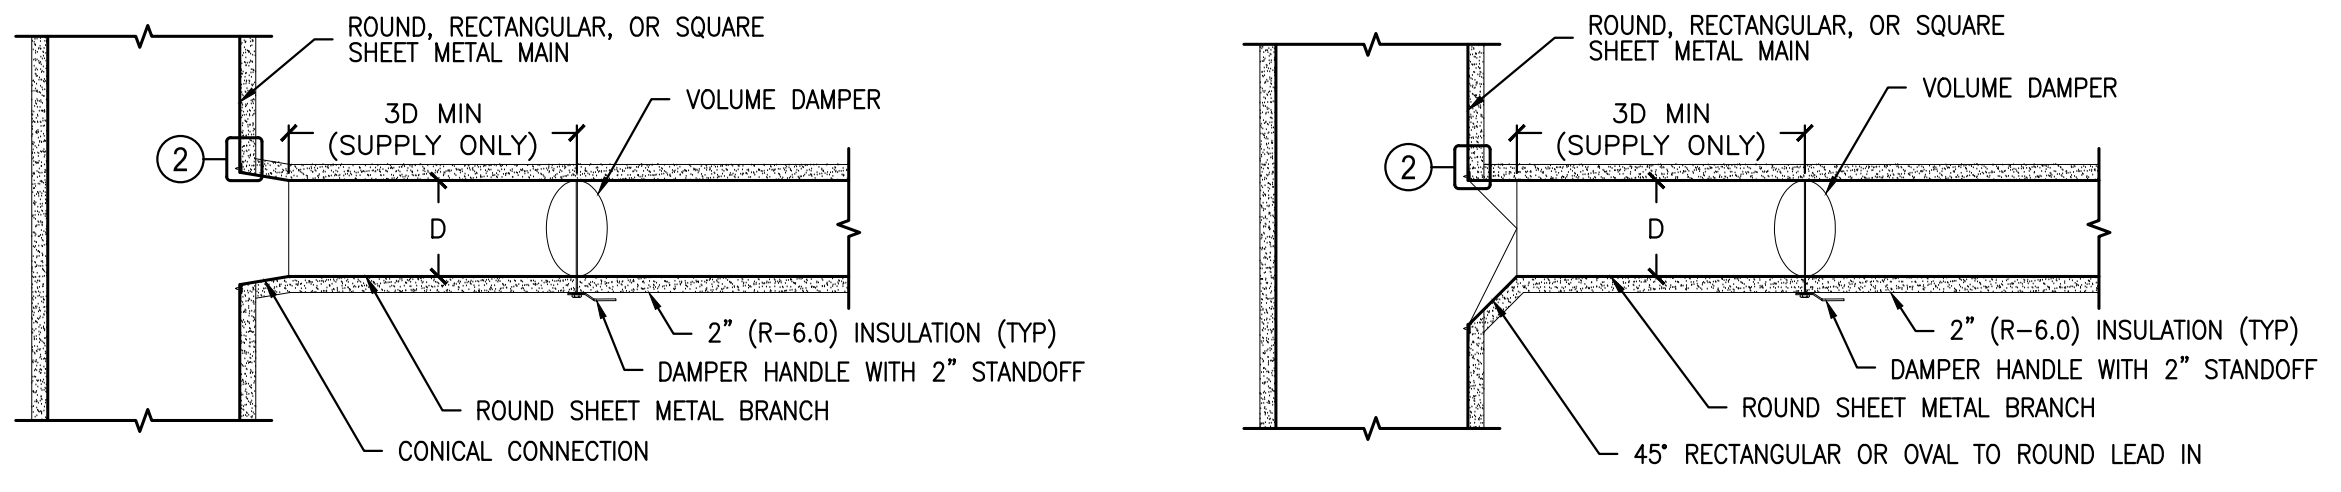
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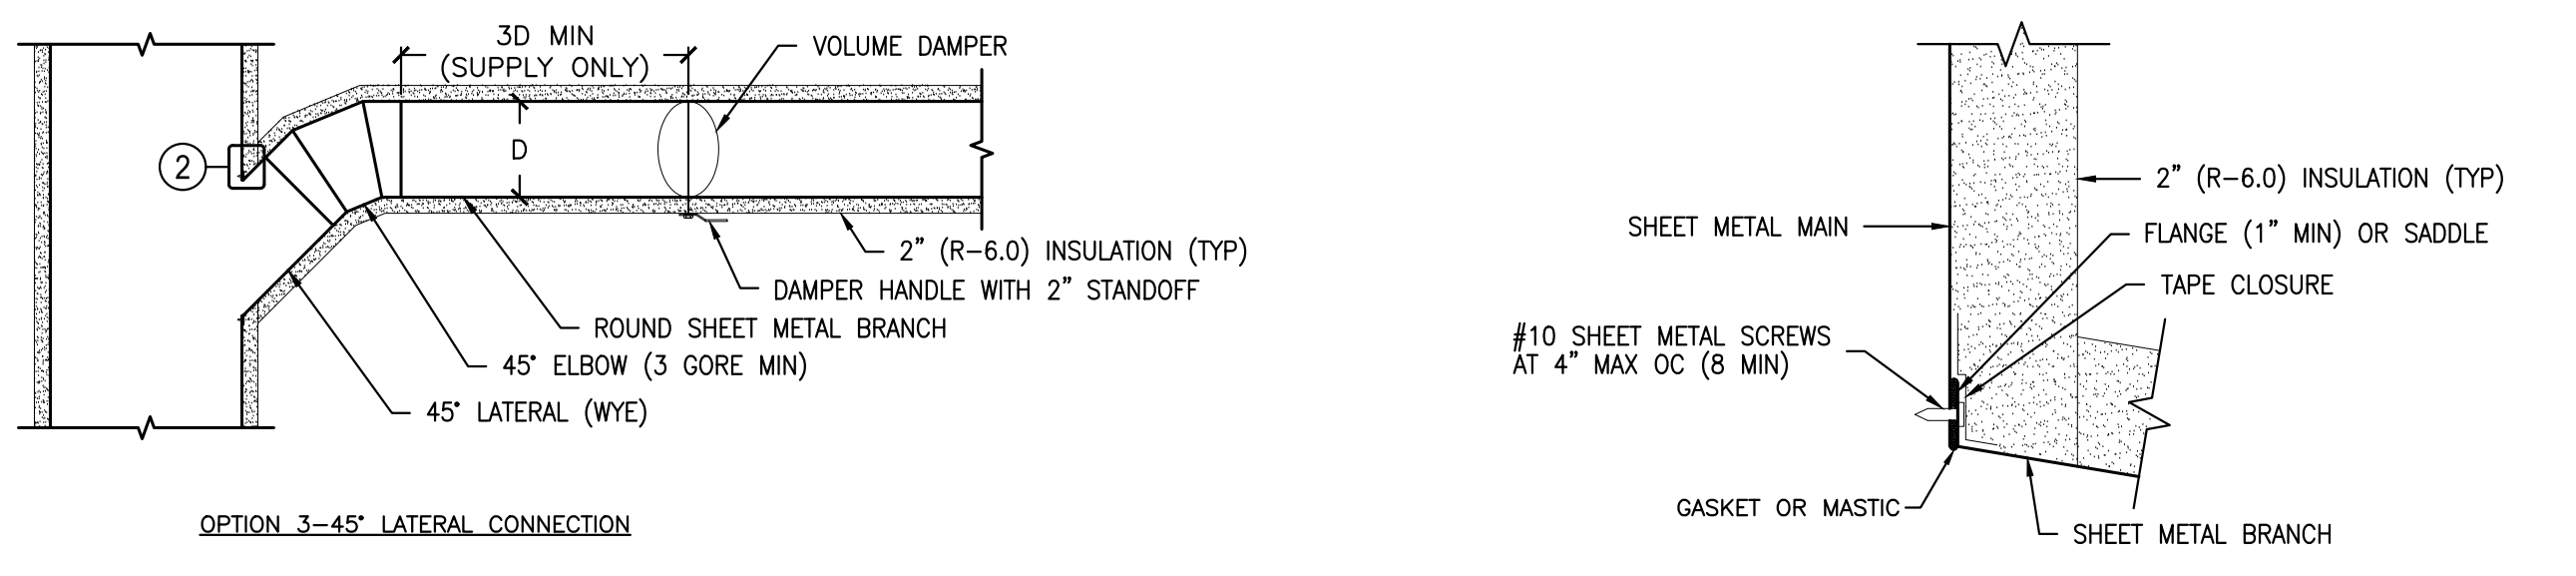
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1 BRANCH DUCT TERMINATION DETAILS  
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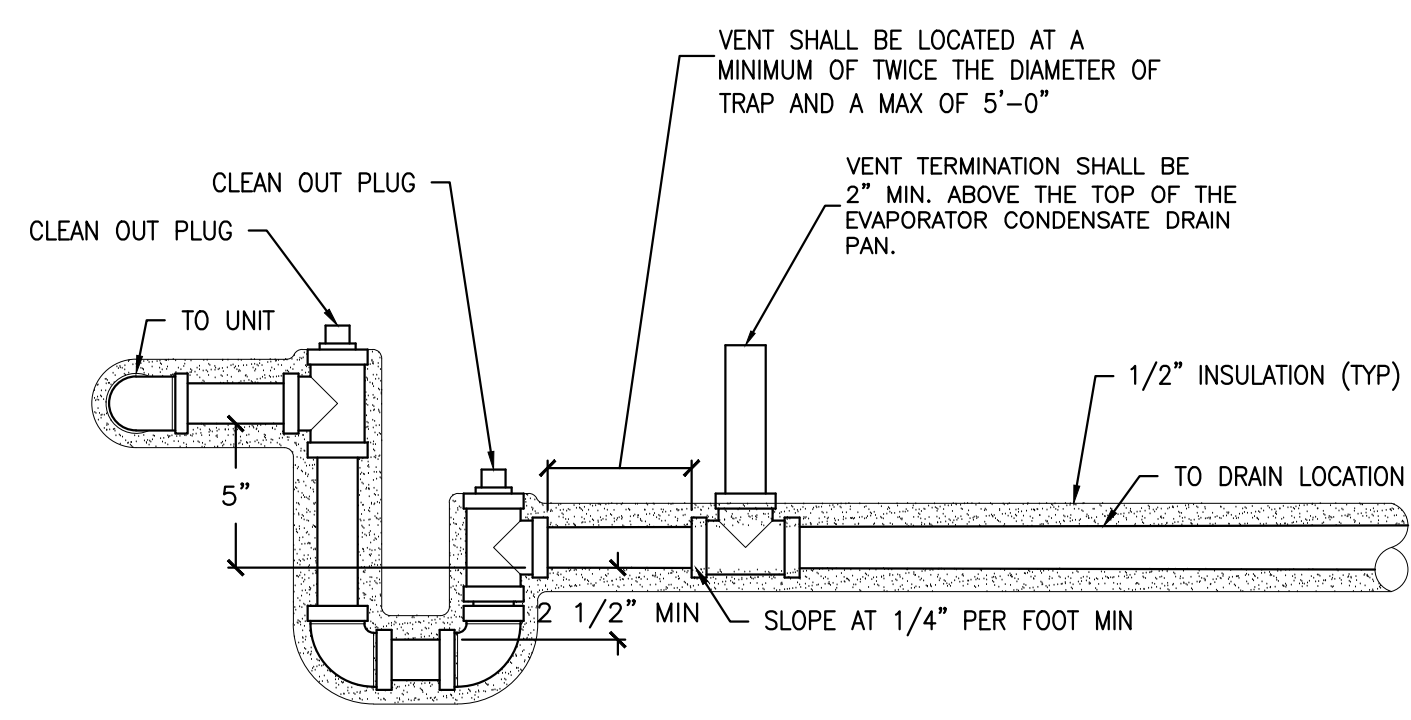
2 SHEET METAL DUCT BRANCH CONNECTION OPTIONS  
SCALE: NTS




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SCALE: NTS

ACCEPTABLE ROUND ELBOWS			
MAIN DUCTWORK (601-2,400 FPM)		BRANCH DUCTWORK (0-600 FPM)	


4 ACCEPTABLE ROUND ELBOWS  
SCALE: NTS

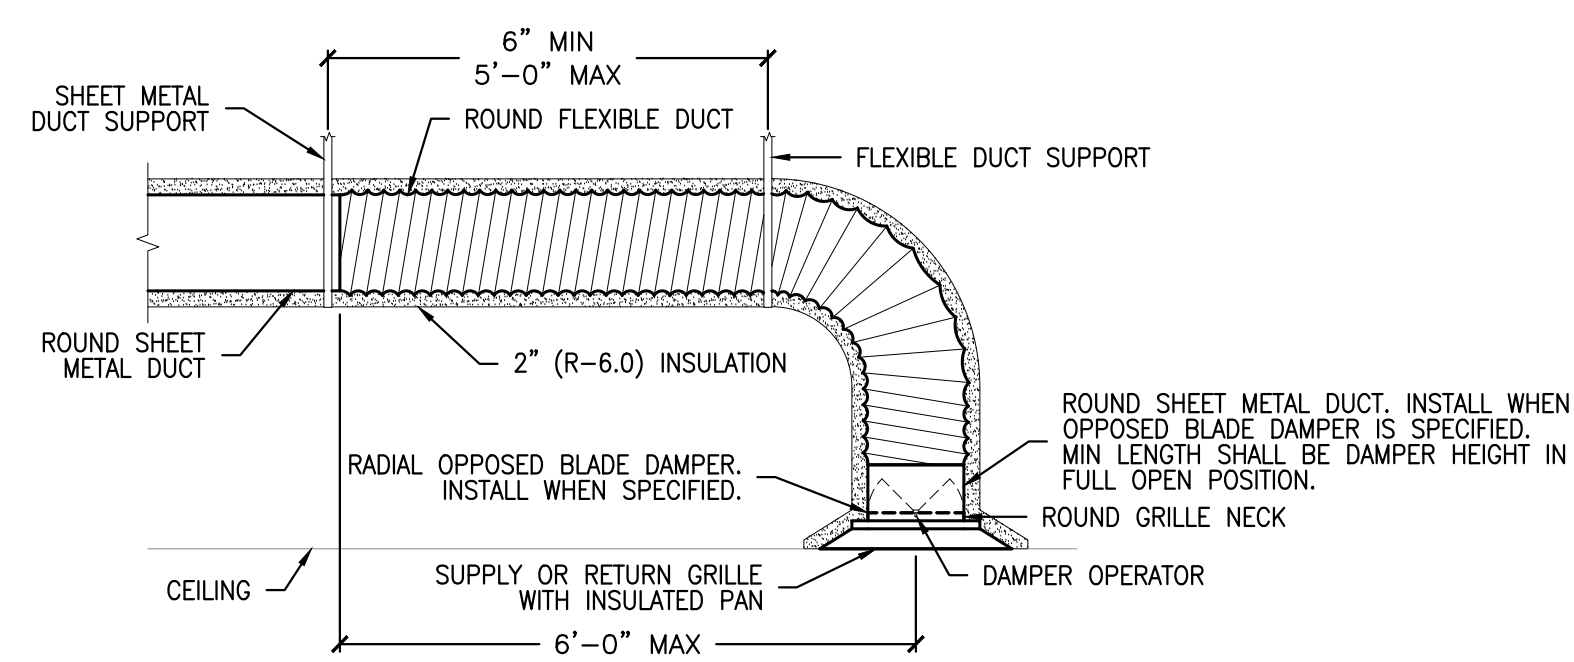

5 CONDENSATE DRAIN DETAIL  
SCALE: NTS

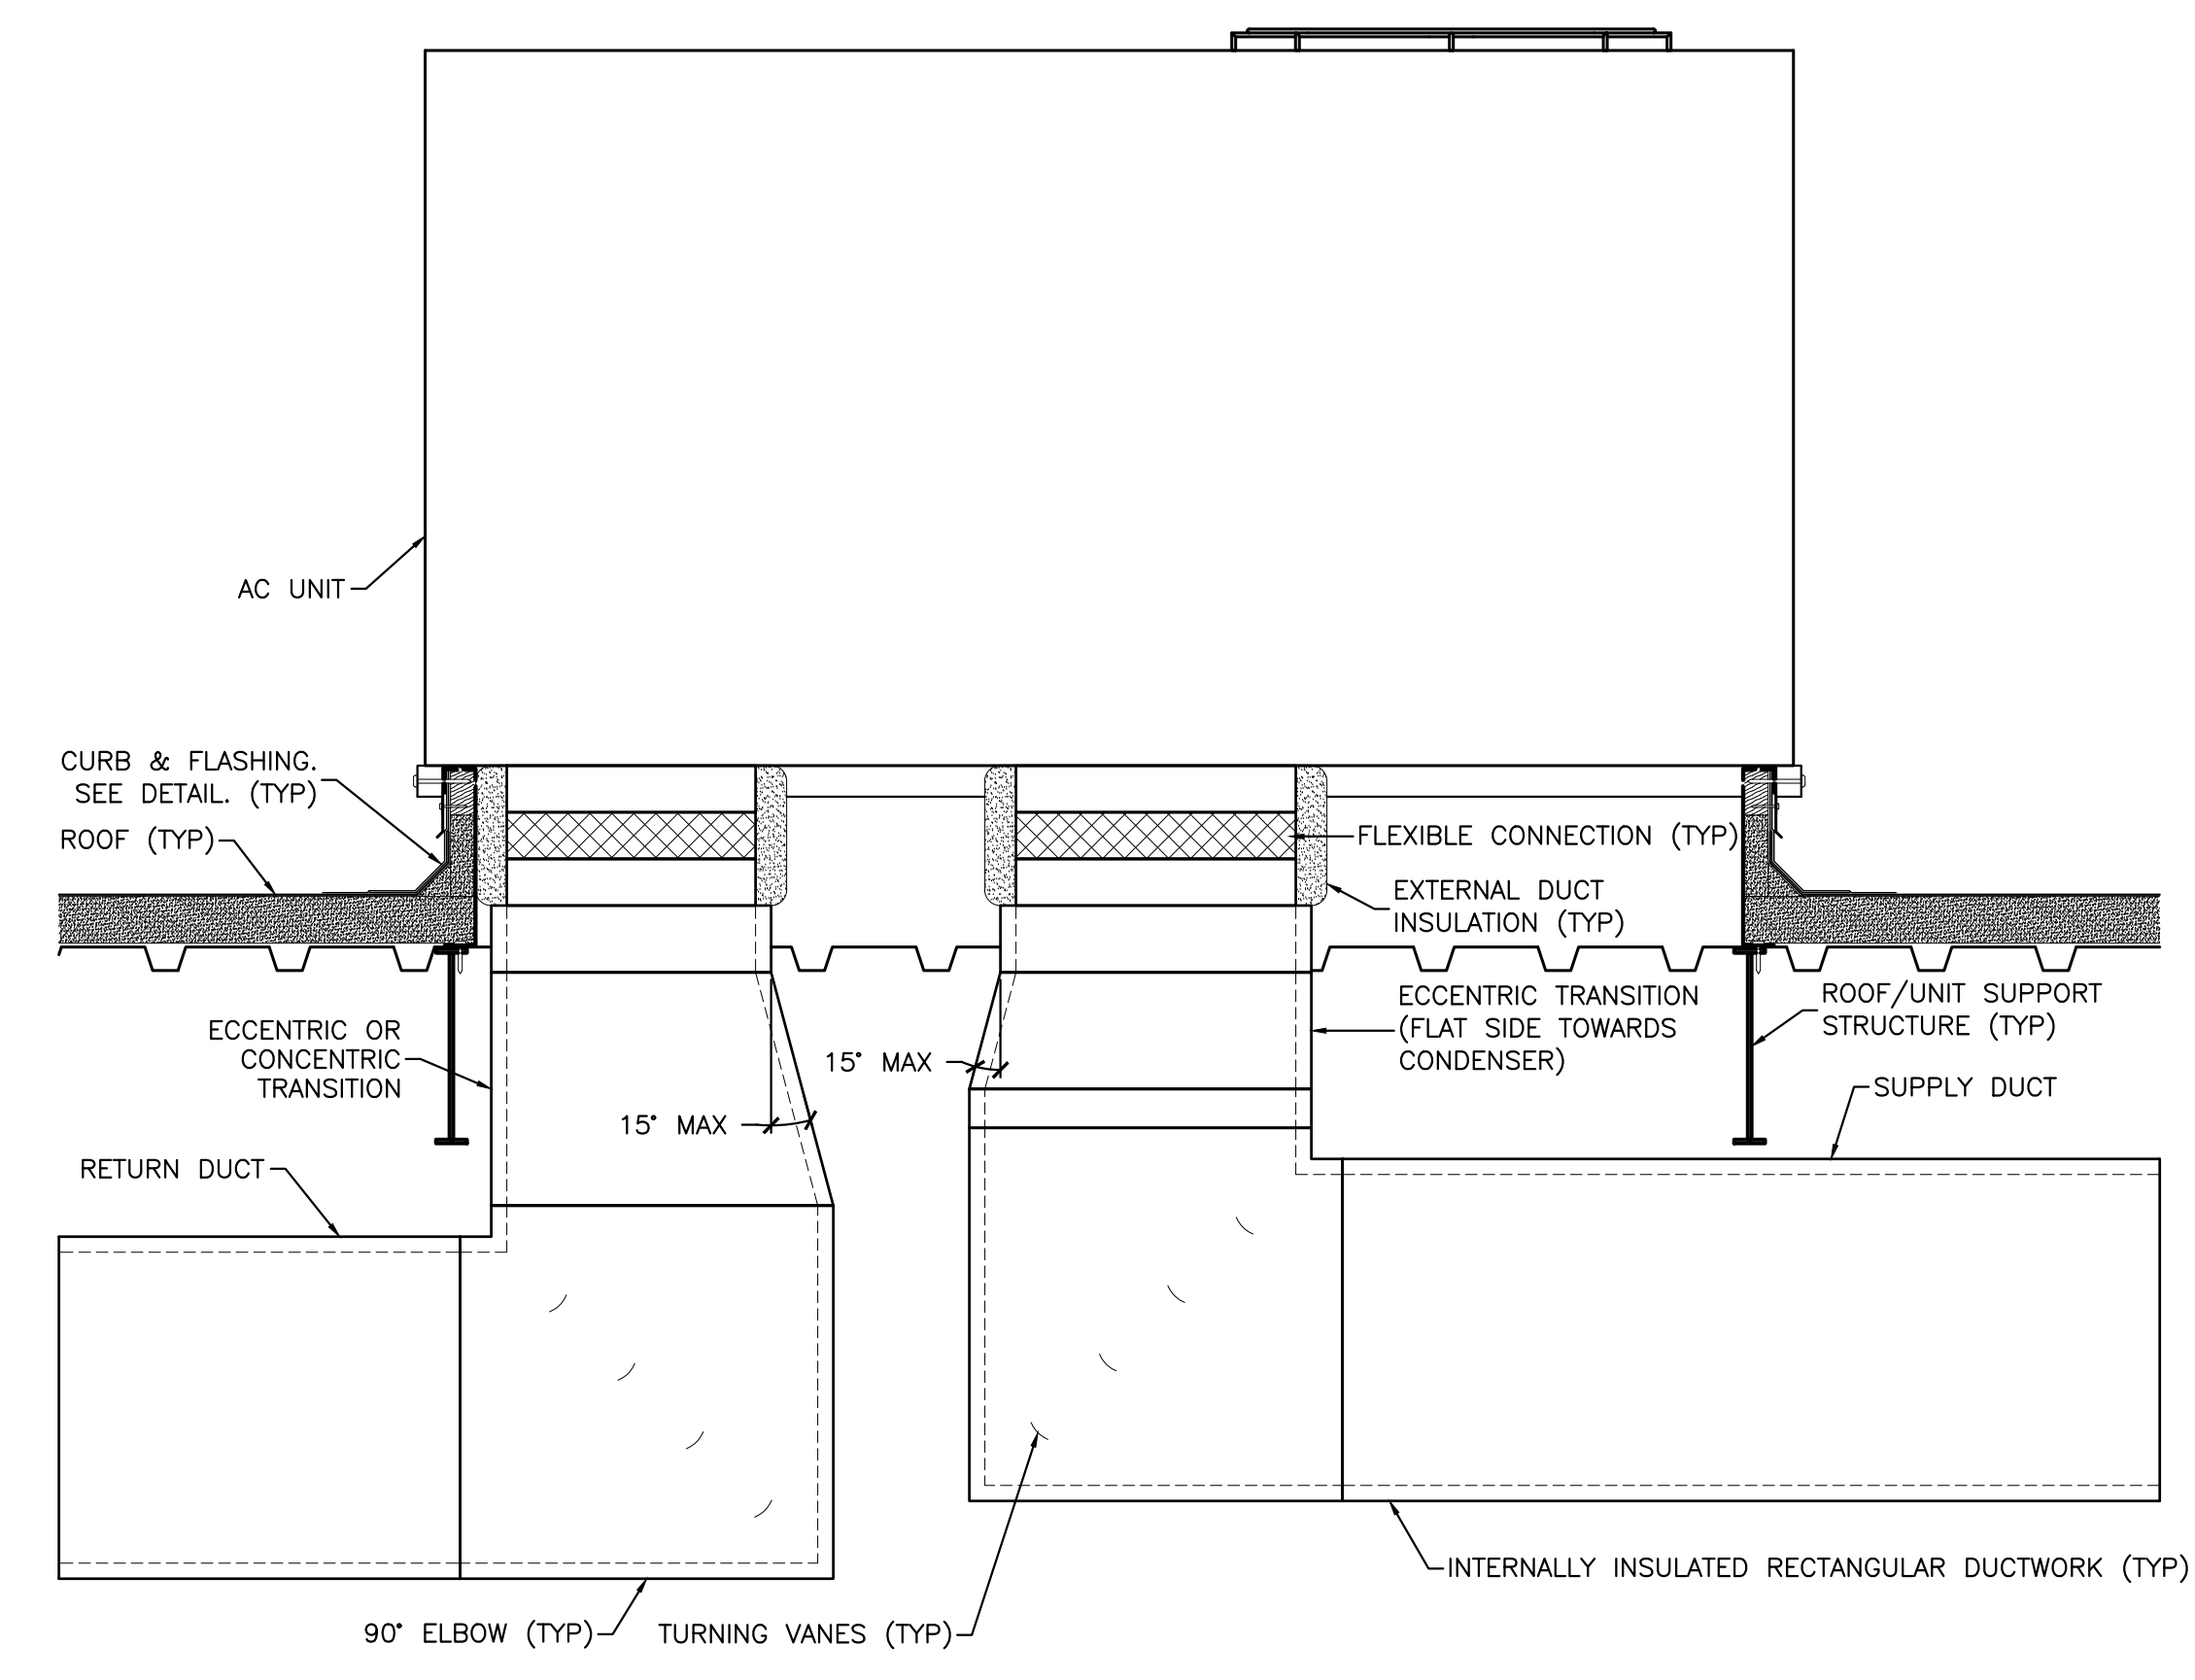


6 ROOFTOP UNIT DETAIL  
SCALE: NTS

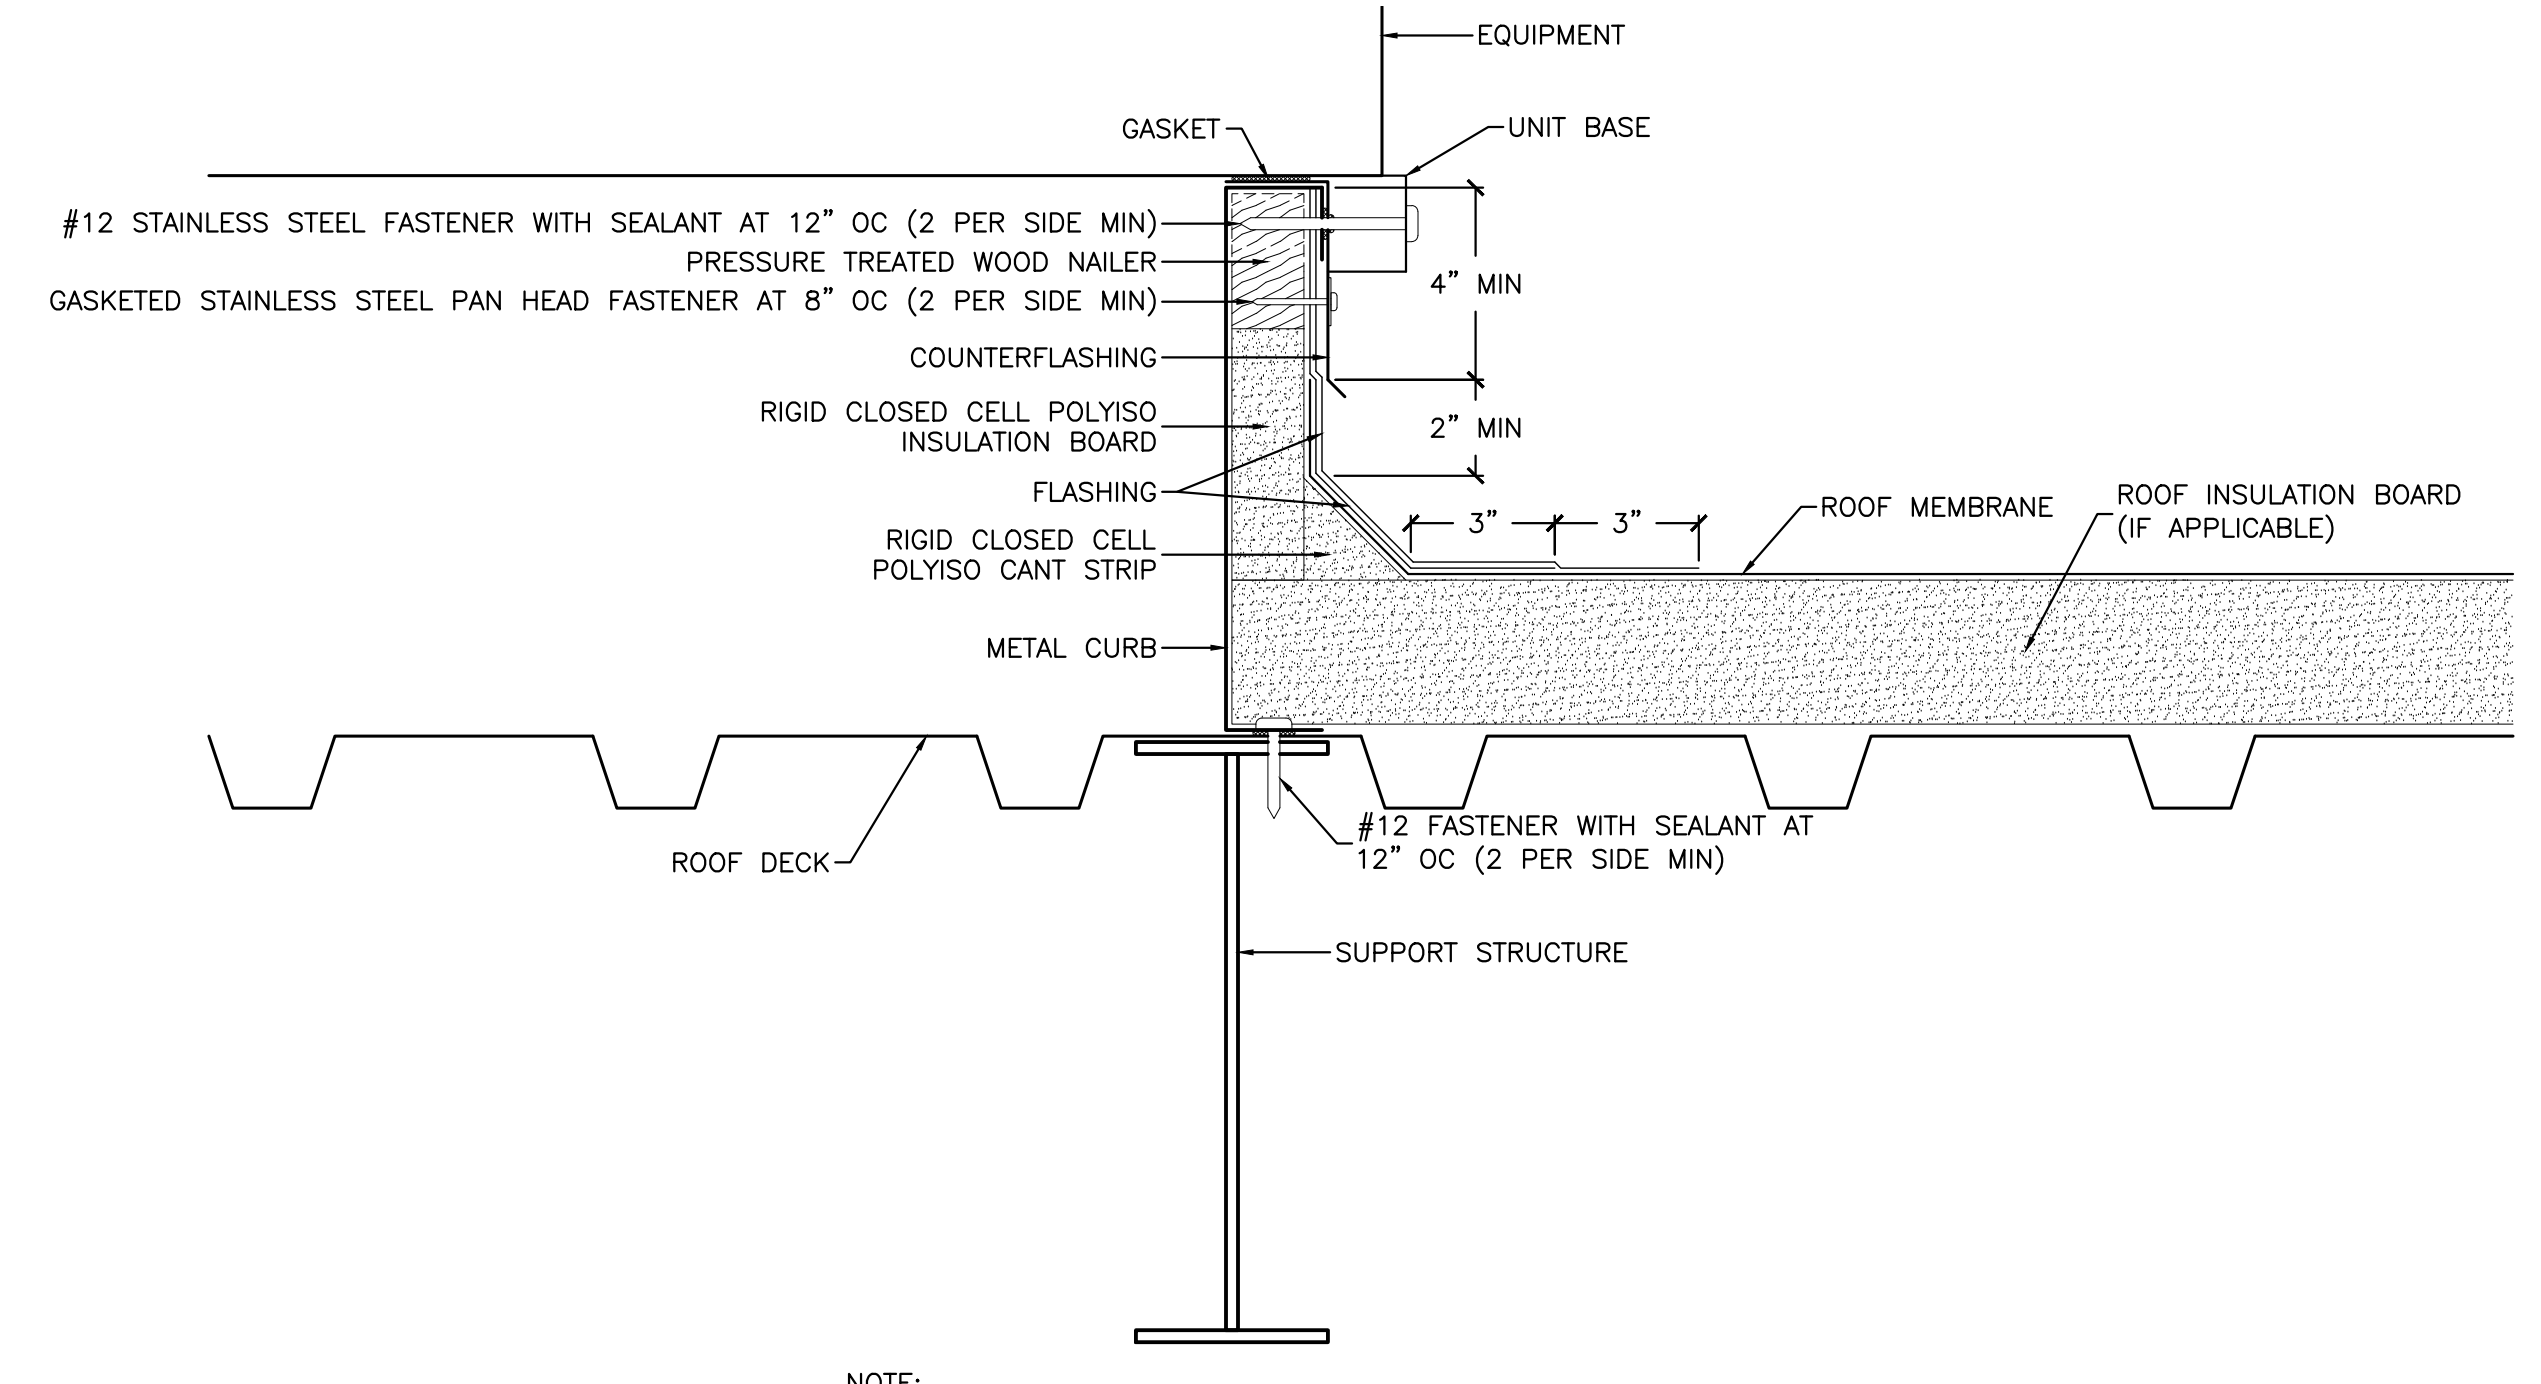


- NOTE:
1. THE CONSTRUCTION SHOWN REPRESENTS THE MINIMUM REQUIREMENTS FOR THIS PROJECT. IT IS NOT A SUBSTITUTE FOR THE ROOFING SYSTEM MANUFACTURER'S INSTALLATION STANDARDS OR THE ROOFING CONTRACTOR'S STANDARDS. ALL WORK SHALL BE FULLY COORDINATED WITH THE ROOFING CONTRACTOR AND SHALL BE PERFORMED IN A MANNER THAT WILL NOT AFFECT ANY NEW OR EXISTING ROOF WARRANTY.
  2. THE AC UNIT SHALL NOT BE SET UNTIL THE ROOF MEMBRANE AND FLASHING HAVE BEEN INSTALLED.


7 ROOF CURB DETAIL  
SCALE: NTS

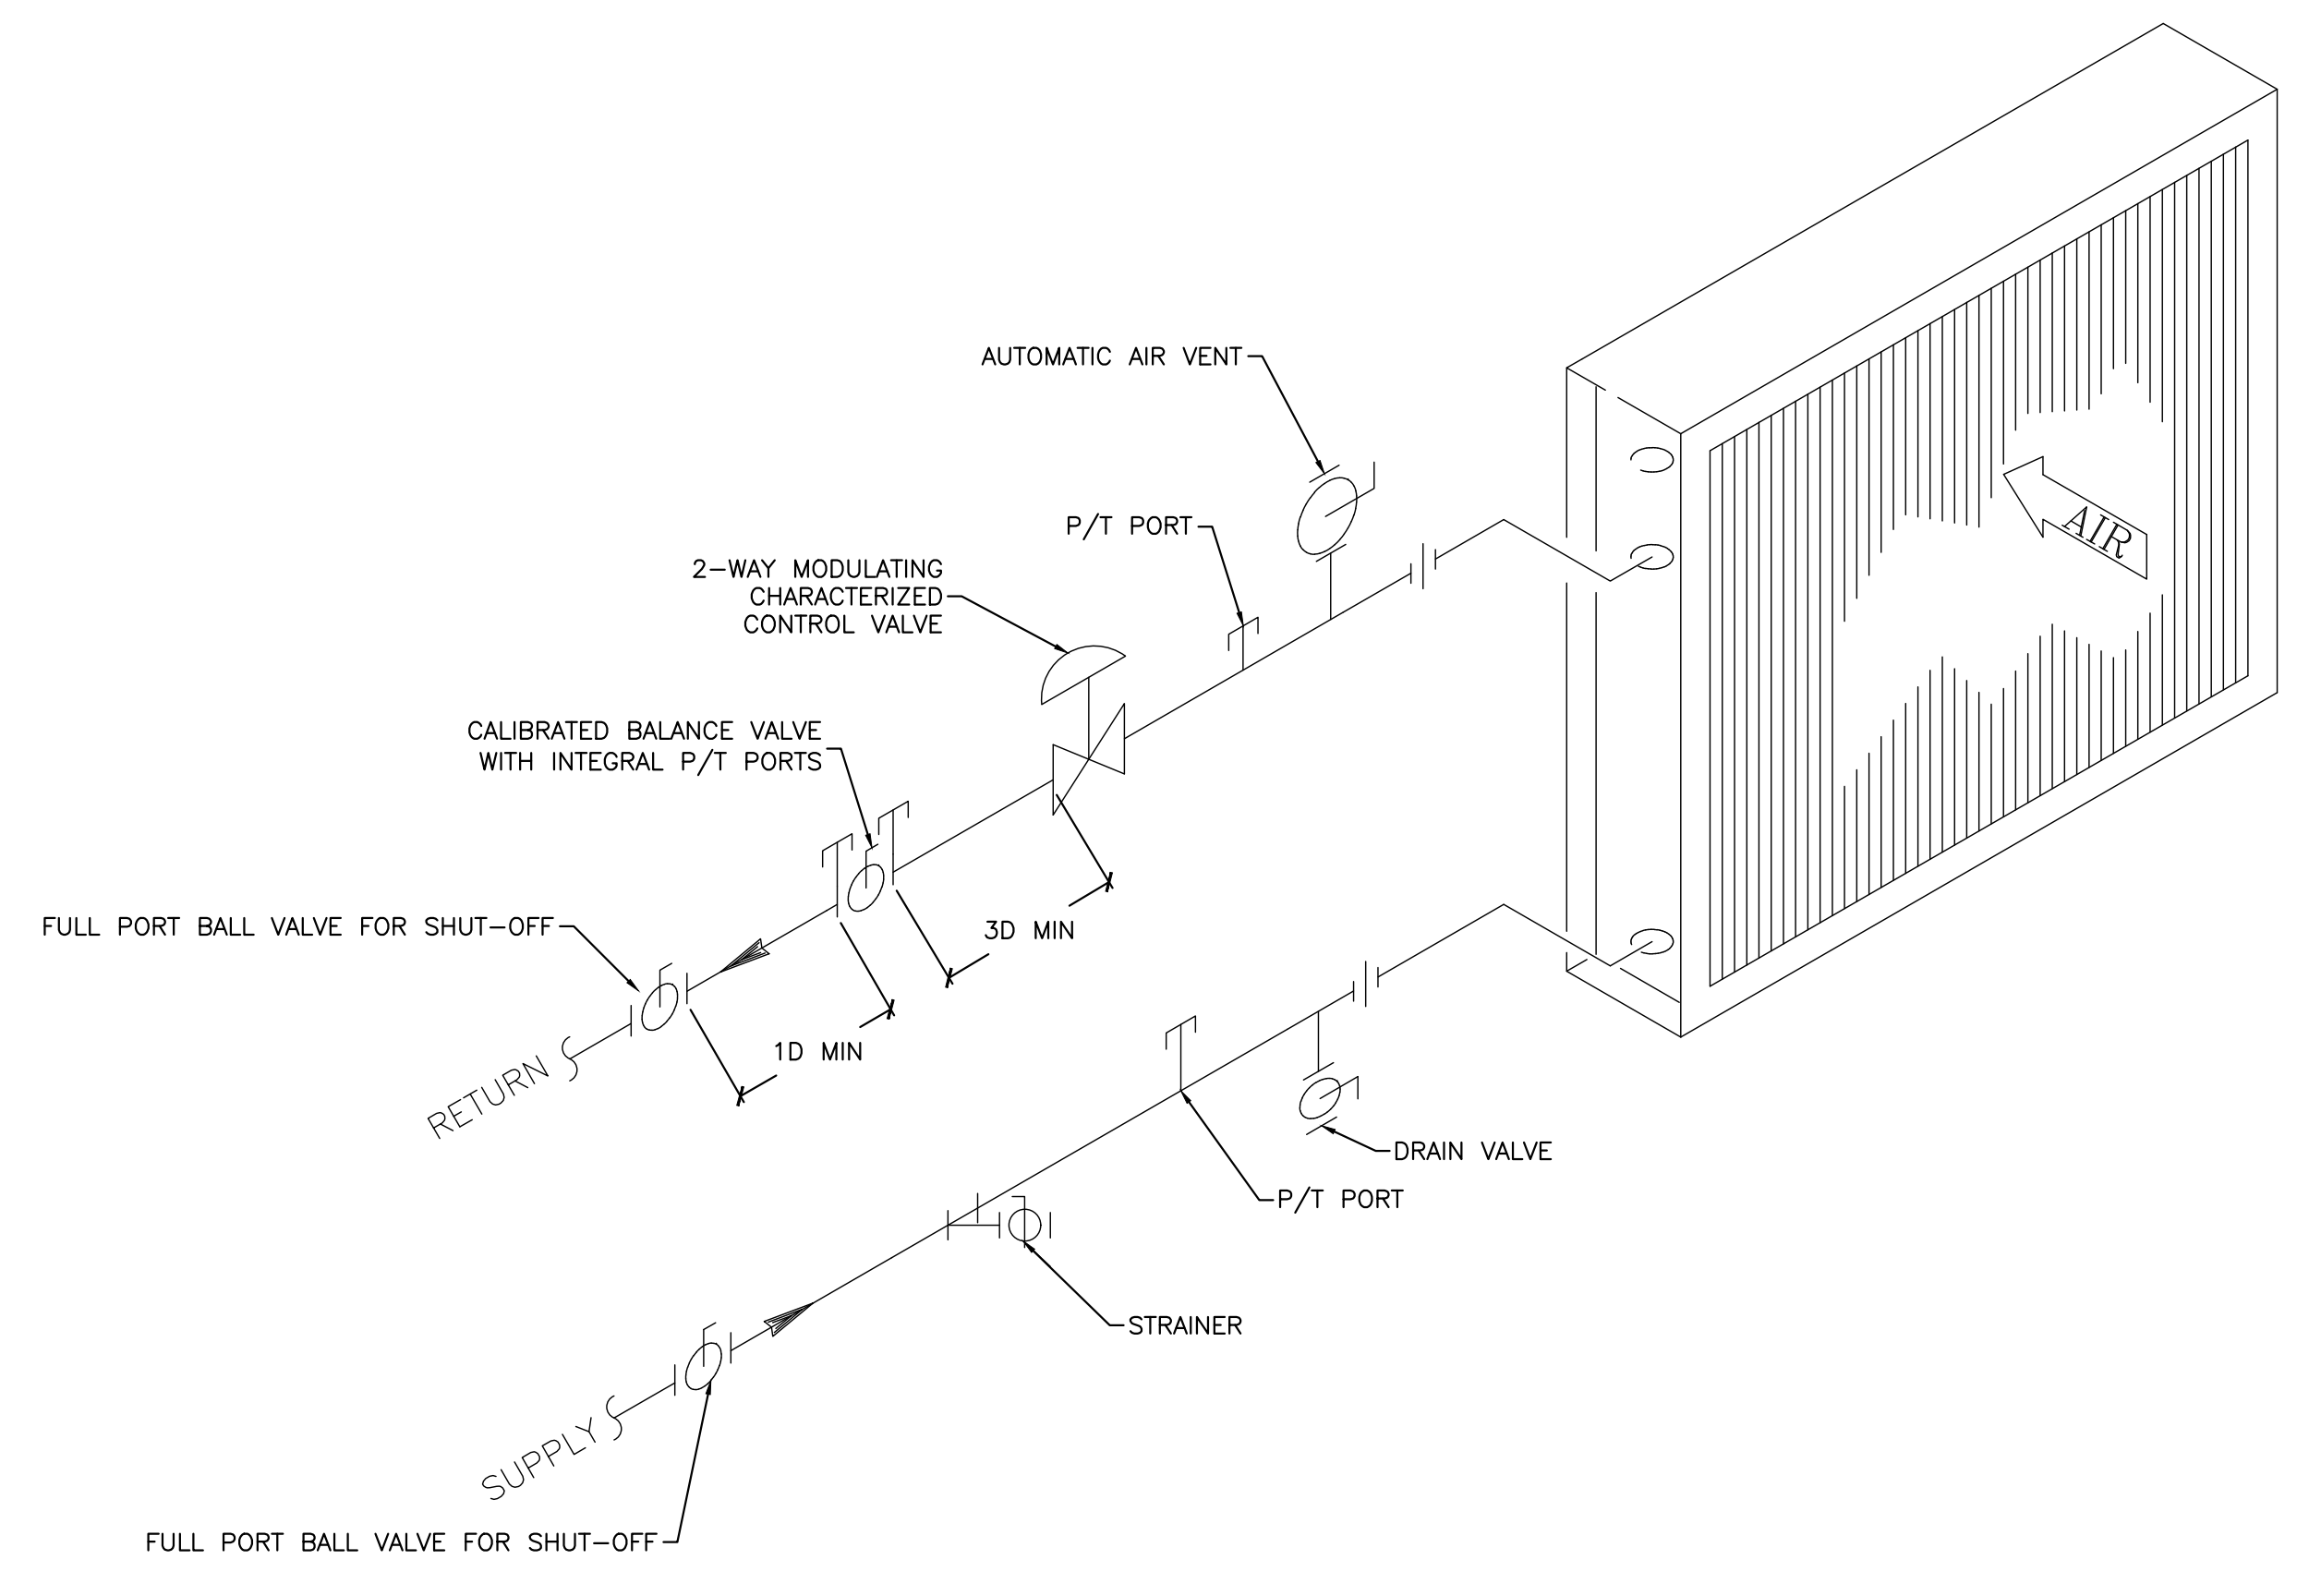

8 HYDRONIC WATER COIL PIPING DETAIL (2-WAY VALVE)  
SCALE: NTS

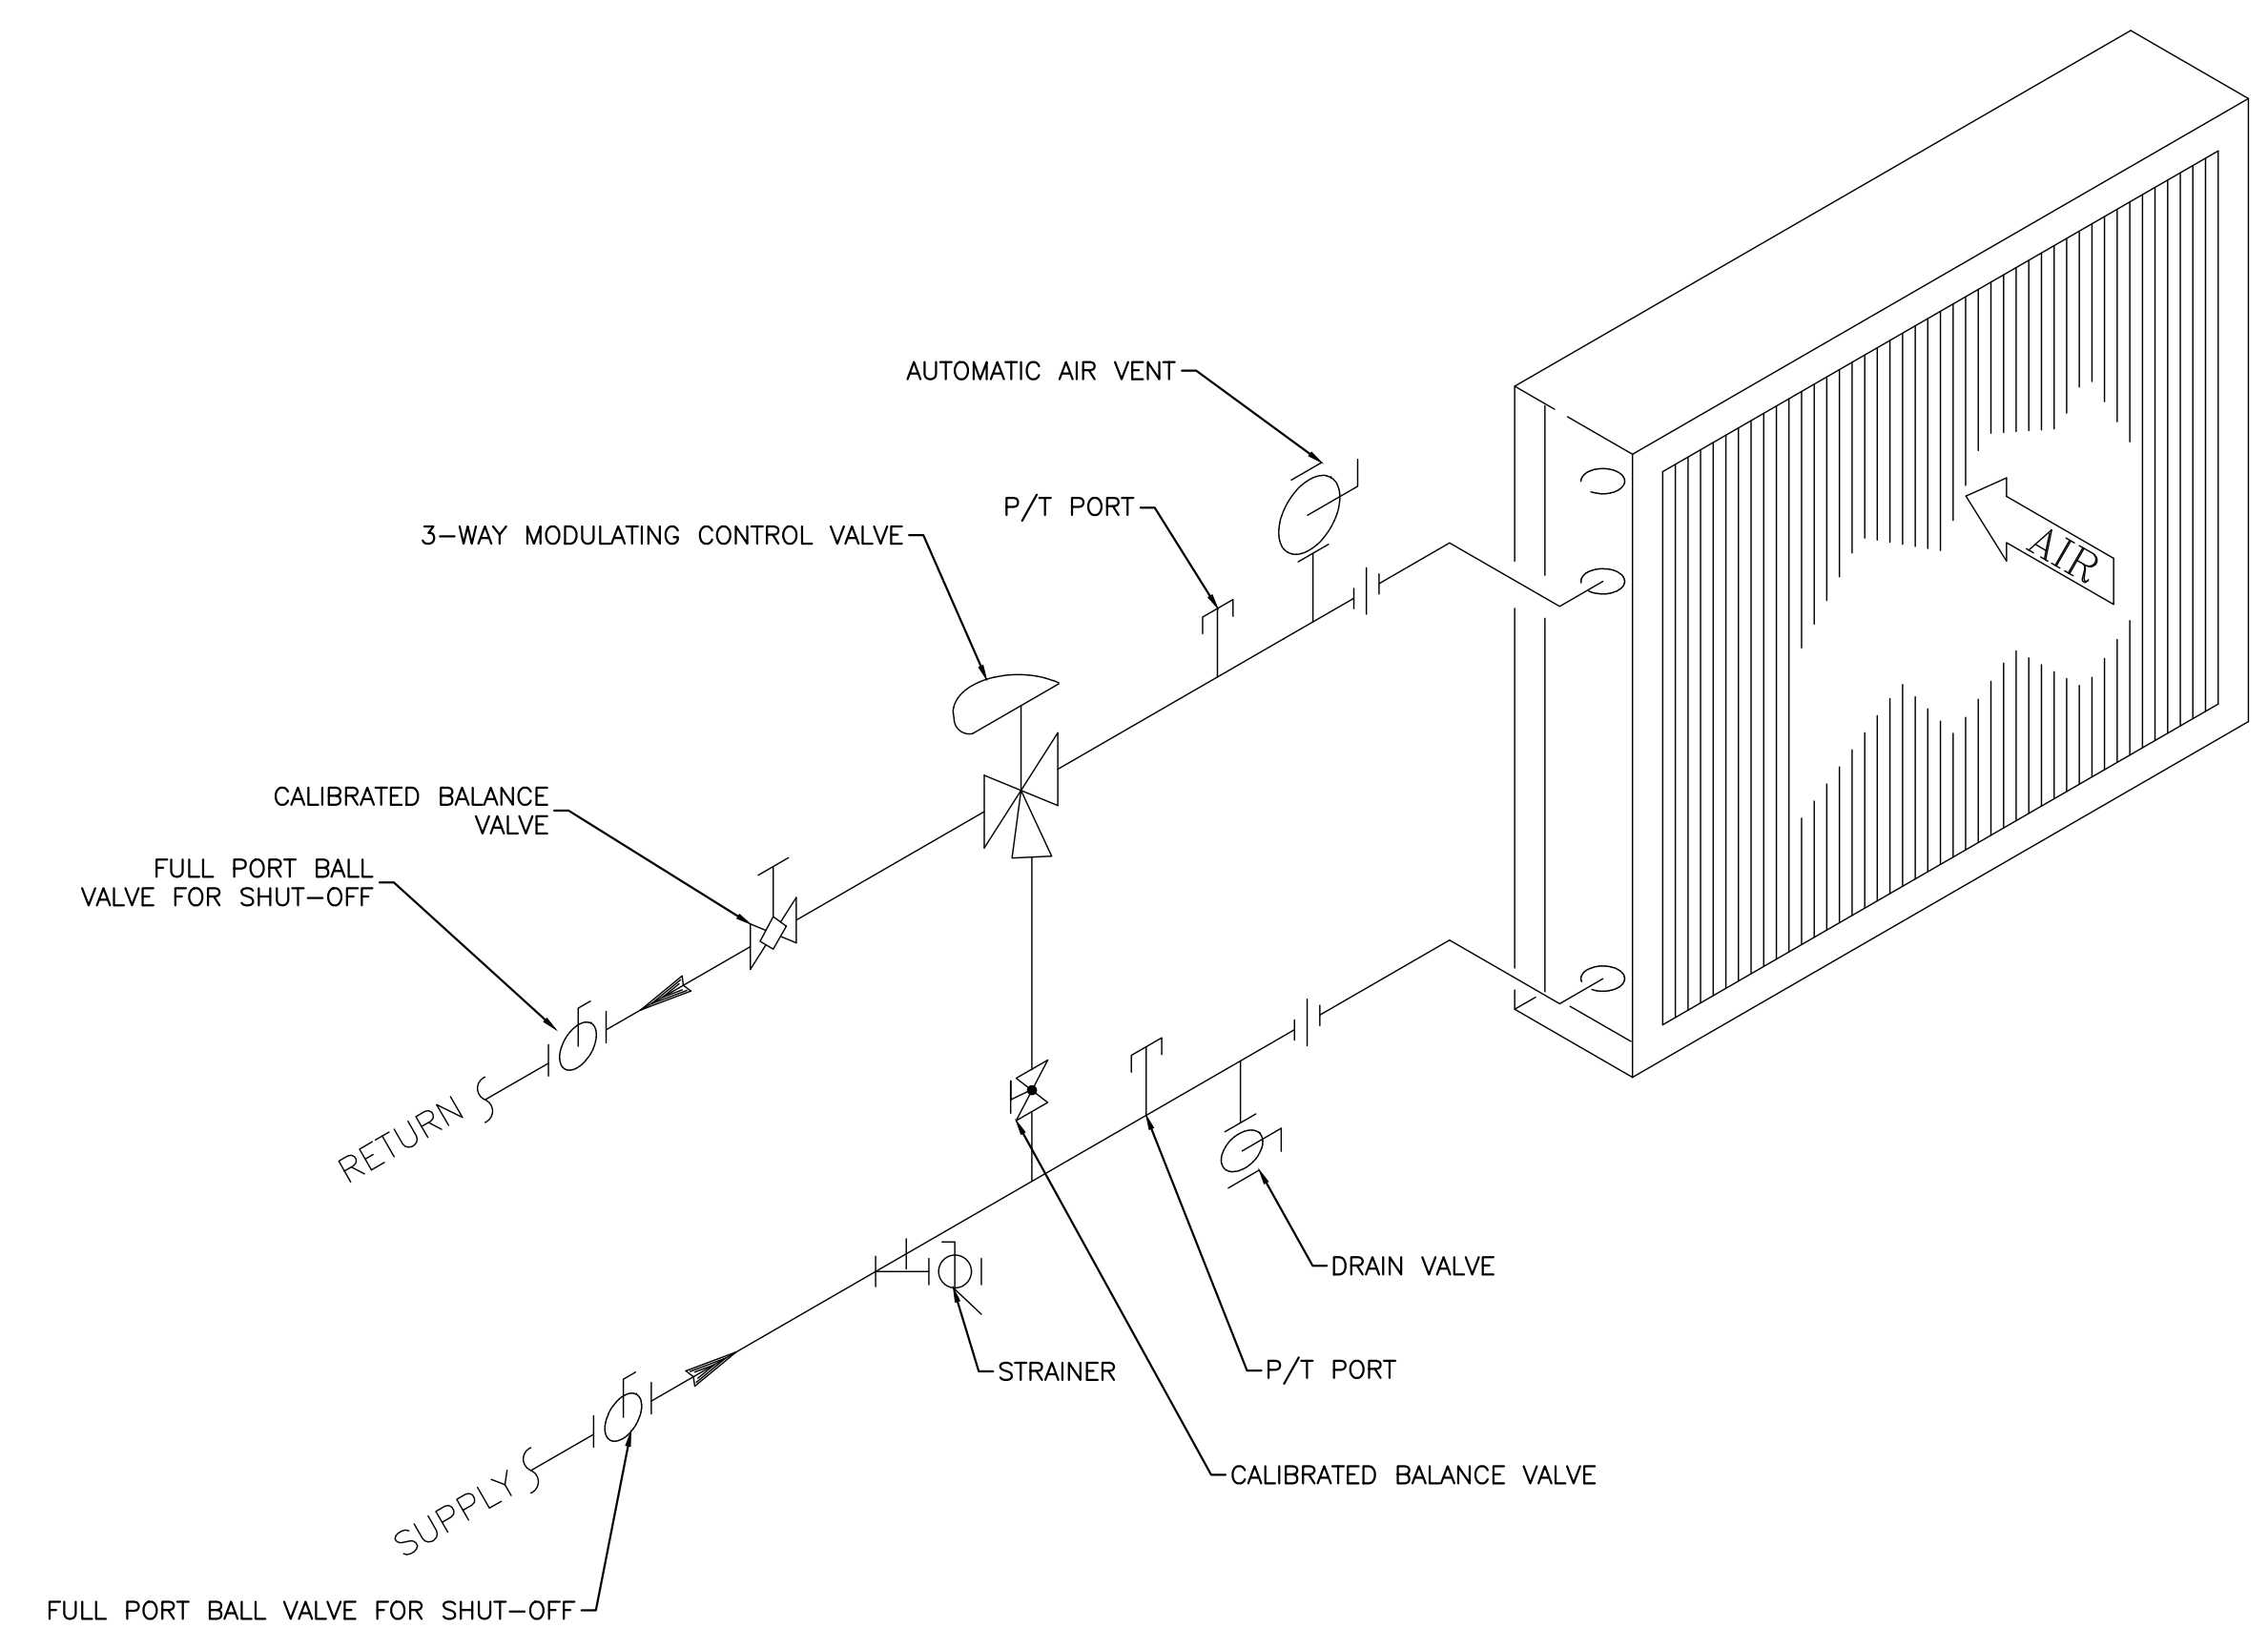

9 HYDRONIC WATER COIL PIPING DETAIL (3-WAY VALVE)  
SCALE: NTS

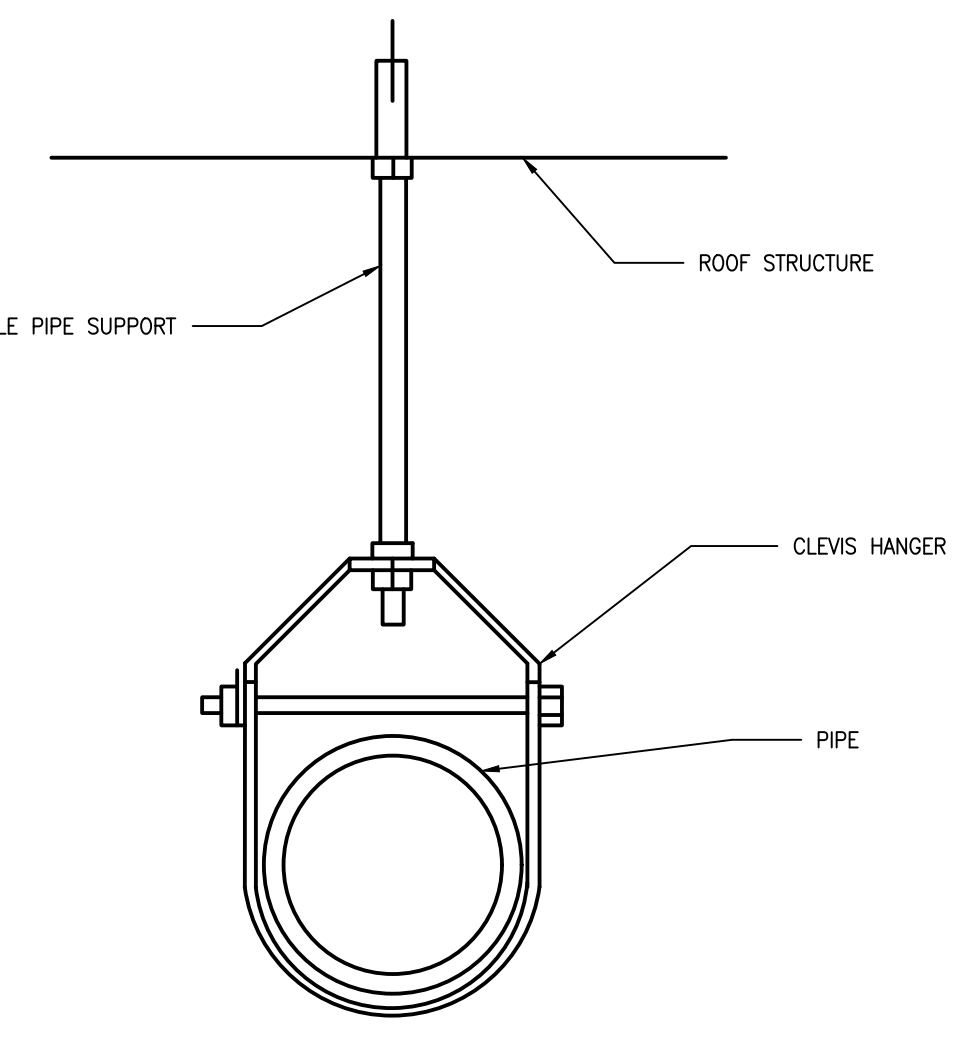

10 HANGING PIPE SUPPORT  
SCALE: NTS

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web: www.mpeng.us  
**MIP DESIGN GROUP**  
ARCHITECTURE  
Bradford A. Jones, Architect

**MECHANICAL DETAILS**

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**M501**


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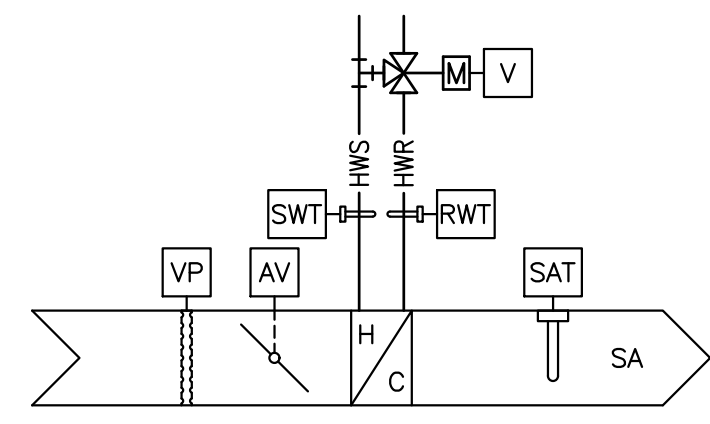







POINT	QTY.	DESCRIPTION
AV	1	AIR VALVE ACTUATOR (NO/PC, MODULATING)
RWT	1	RETURN WATER TEMPERATURE SENSOR
SAT	1	SUPPLY AIR TEMPERATURE SENSOR
SWT	1	SUPPLY WATER TEMPERATURE SENSOR
TH	1	SPACE COMBINATION TEMPERATURE/HUMIDITY THERMOSTAT
V	1	VALVE ACTUATOR (NO/PC, MODULATING)
VP	1	VELOCITY PRESSURE SENSOR

1 VAV BOX CONTROL DIAGRAM (2-WAY VALVE)  
SCALE: NTS

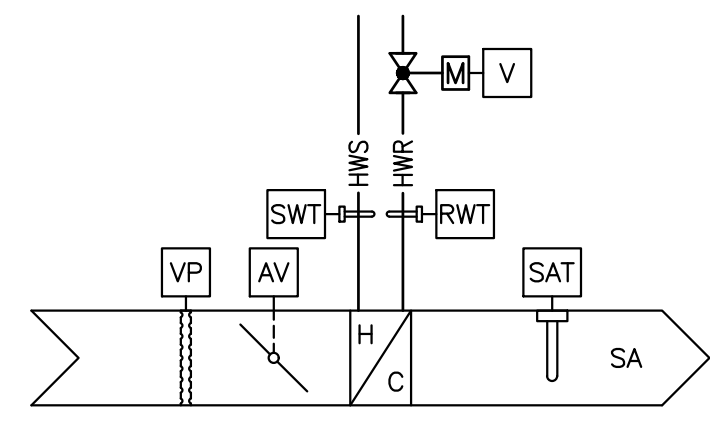


POINT	QTY.	DESCRIPTION
AV	1	AIR VALVE ACTUATOR (NO/PC, MODULATING)
RWT	1	RETURN WATER TEMPERATURE SENSOR
SAT	1	SUPPLY AIR TEMPERATURE SENSOR
SWT	1	SUPPLY WATER TEMPERATURE SENSOR
TH	1	SPACE COMBINATION TEMPERATURE/HUMIDITY THERMOSTAT
V	1	VALVE ACTUATOR (NO/PC, MODULATING)
VP	1	VELOCITY PRESSURE SENSOR

2 VAV BOX CONTROL DIAGRAM (3-WAY VALVE)  
SCALE: NTS

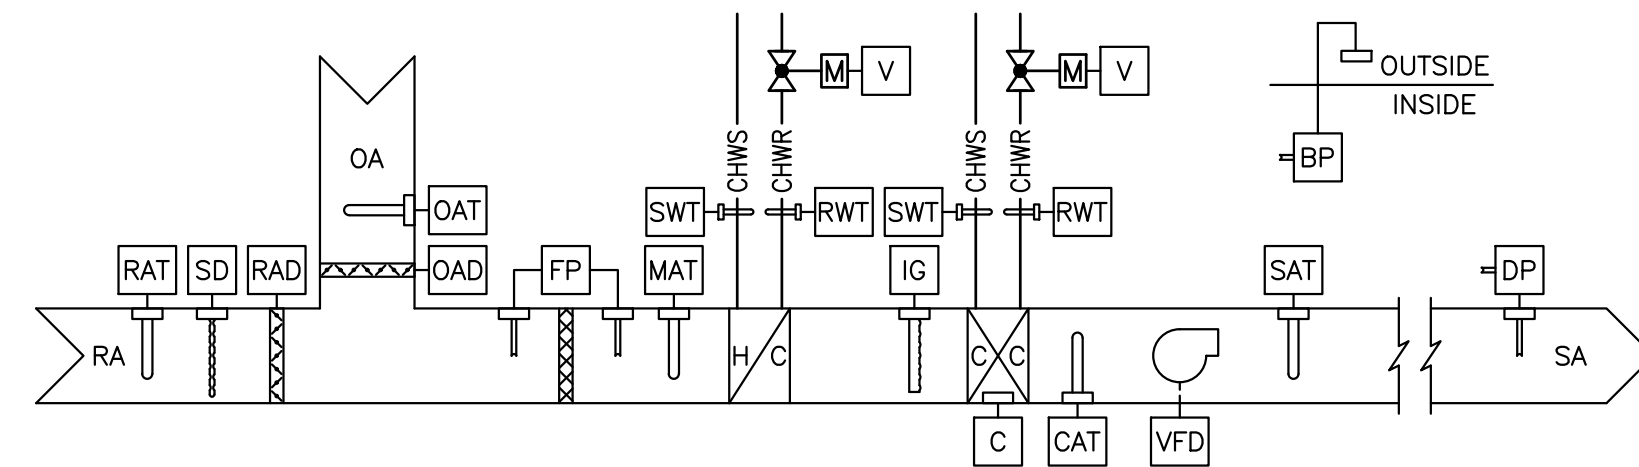


POINT	QTY.	DESCRIPTION
BP	1	BUILDING PRESSURE SENSOR
C	1	CONDENSATE OVERFLOW SENSOR
CAT	1	COIL AIR TEMPERATURE SENSOR
DP	1	DUCT PRESSURE SENSOR
FP	1	FILTER PRESSURE SENSOR
IG	1	ION GENERATOR UNIT
MAT	1	MIXED AIR TEMPERATURE SENSOR
OAD	1	OUTDOOR AIR DAMPER ACTUATOR (NO/PC, MODULATING)
OAT	1	OUTDOOR AIR TEMPERATURE SENSOR
RAD	1	RETURN AIR DAMPER ACTUATOR (NO/PC, MODULATING)
RAT	1	RETURN AIR TEMPERATURE SENSOR
RWT	2	RETURN WATER TEMPERATURE SENSOR
SAT	1	SUPPLY AIR TEMPERATURE SENSOR
SD	1	SMOKE DETECTOR
SWT	2	SUPPLY WATER TEMPERATURE SENSOR
V	1	VALVE ACTUATOR (NO/PC, MODULATING)
VFD	1	VARIABLE SPEED DRIVE

3 VAV AIR HANDLING UNIT CONTROL DIAGRAM  
SCALE: NTS

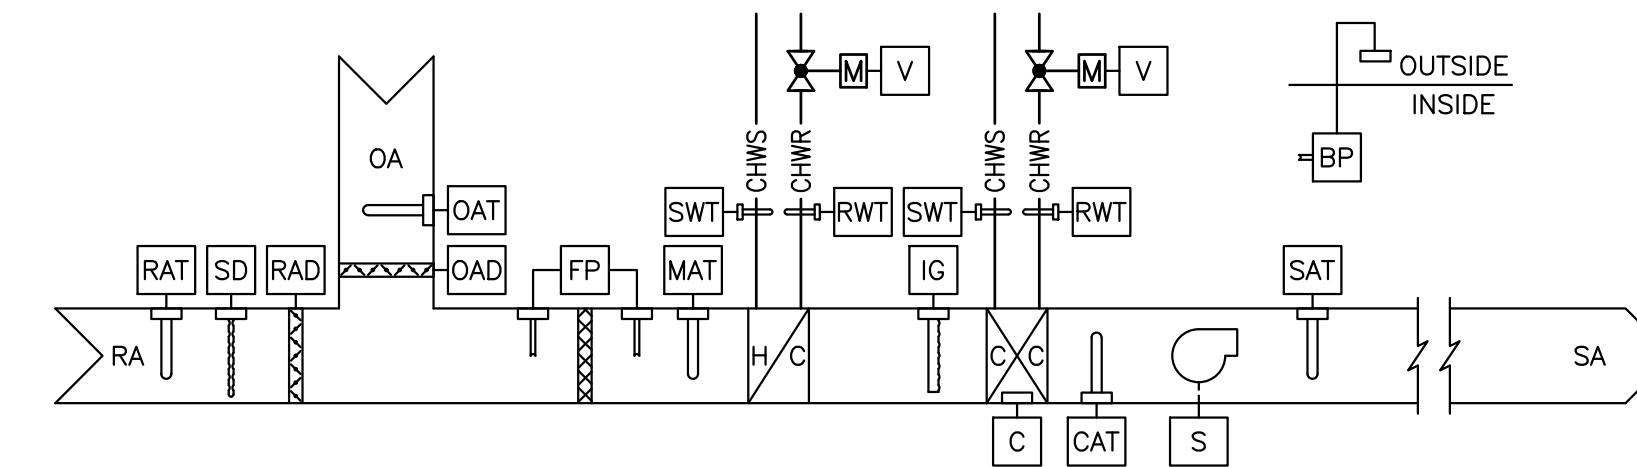


POINT	QTY.	DESCRIPTION
BP	1	BUILDING PRESSURE SENSOR
C	1	CONDENSATE OVERFLOW SENSOR
CAT	1	COIL AIR TEMPERATURE SENSOR
FP	1	FILTER PRESSURE SENSOR
IG	1	ION GENERATOR UNIT
MAT	1	MIXED AIR TEMPERATURE SENSOR
OAD	1	OUTDOOR AIR DAMPER ACTUATOR (NO/PC, MODULATING)
OAT	1	OUTDOOR AIR TEMPERATURE SENSOR
RAD	1	RETURN AIR DAMPER ACTUATOR (NO/PC, MODULATING)
RAT	1	RETURN AIR TEMPERATURE SENSOR
RWT	2	RETURN WATER TEMPERATURE SENSOR
S	1	STARTER
SAT	1	SUPPLY AIR TEMPERATURE SENSOR
SD	1	SMOKE DETECTOR
SWT	2	SUPPLY WATER TEMPERATURE SENSOR
V	1	VALVE ACTUATOR (NO/PC, MODULATING)

4 CAV AIR HANDLING UNIT CONTROL DIAGRAM  
SCALE: NTS

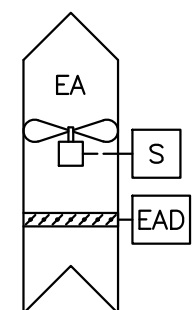


POINT	QTY.	DESCRIPTION
EAD	1	EXHAUST AIR DAMPER ACTUATOR (NO/PC, 2 POSITION)
S	1	STARTER

5 ROOFTOP EXHAUST FAN CONTROL DIAGRAM  
SCALE: NTS

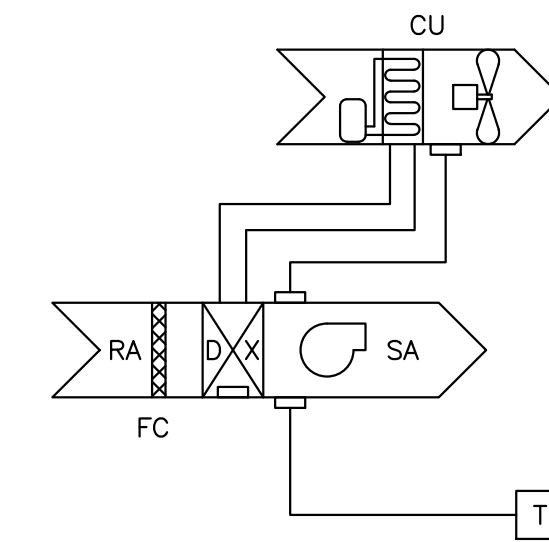


POINT	QTY.	DESCRIPTION
T	1	SPACE THERMOSTAT/UNIT CONTROLLER

5 FAN COIL & CONDENSING UNIT CONTROL DIAGRAM  
SCALE: NTS

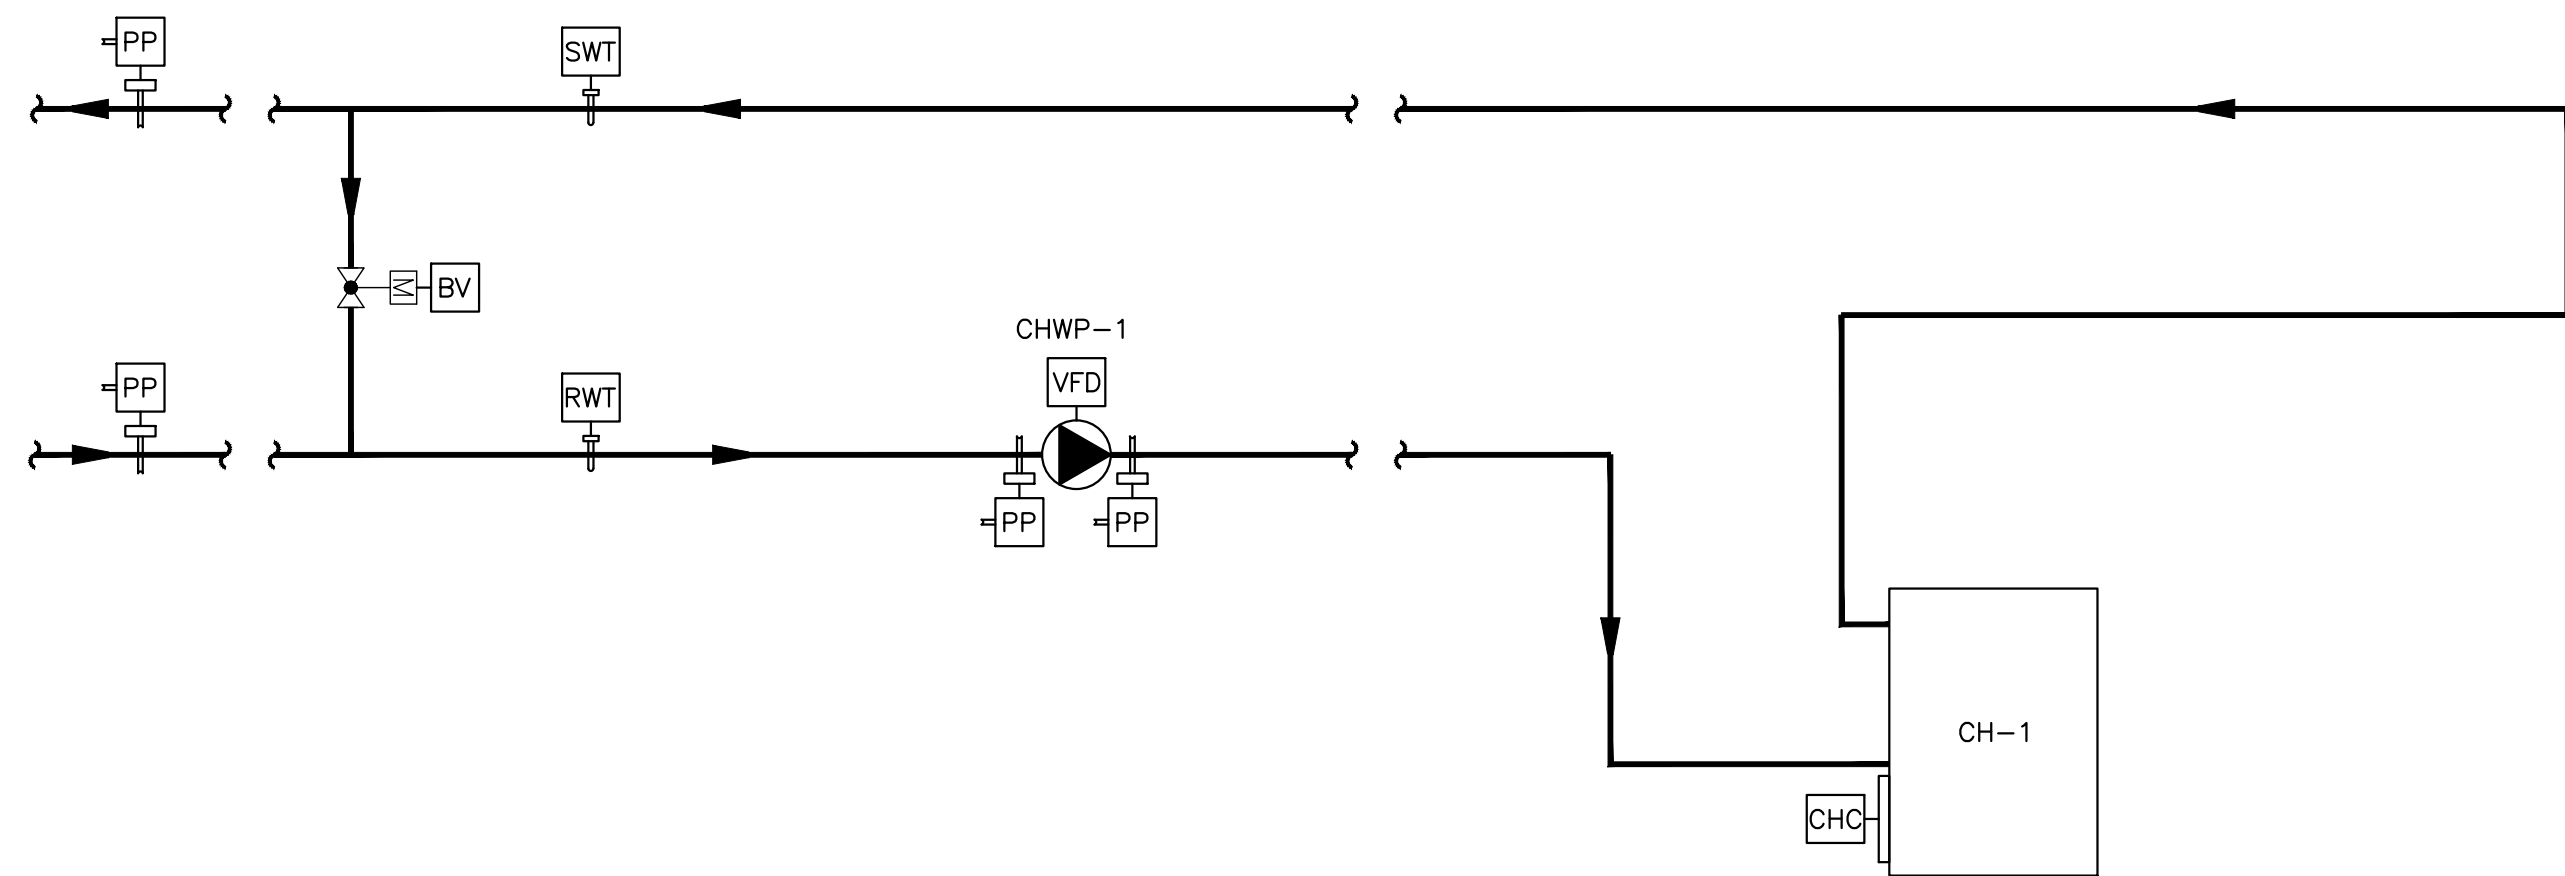

POINT	QTY.	DESCRIPTION
BV	1	BYPASS VALVE ACTUATOR (NO/PC, MODULATING)
CHC	1	CHILLER CONTROLLER
PP	4	PIPE PRESSURE SENSOR
RWT	1	RETURN WATER TEMPERATURE
SWT	1	SUPPLY WATER TEMPERATURE
VFD	1	VARIABLE FREQUENCY DRIVE

6 CHILLER SYSTEM CONTROL DIAGRAM  
SCALE: NTS

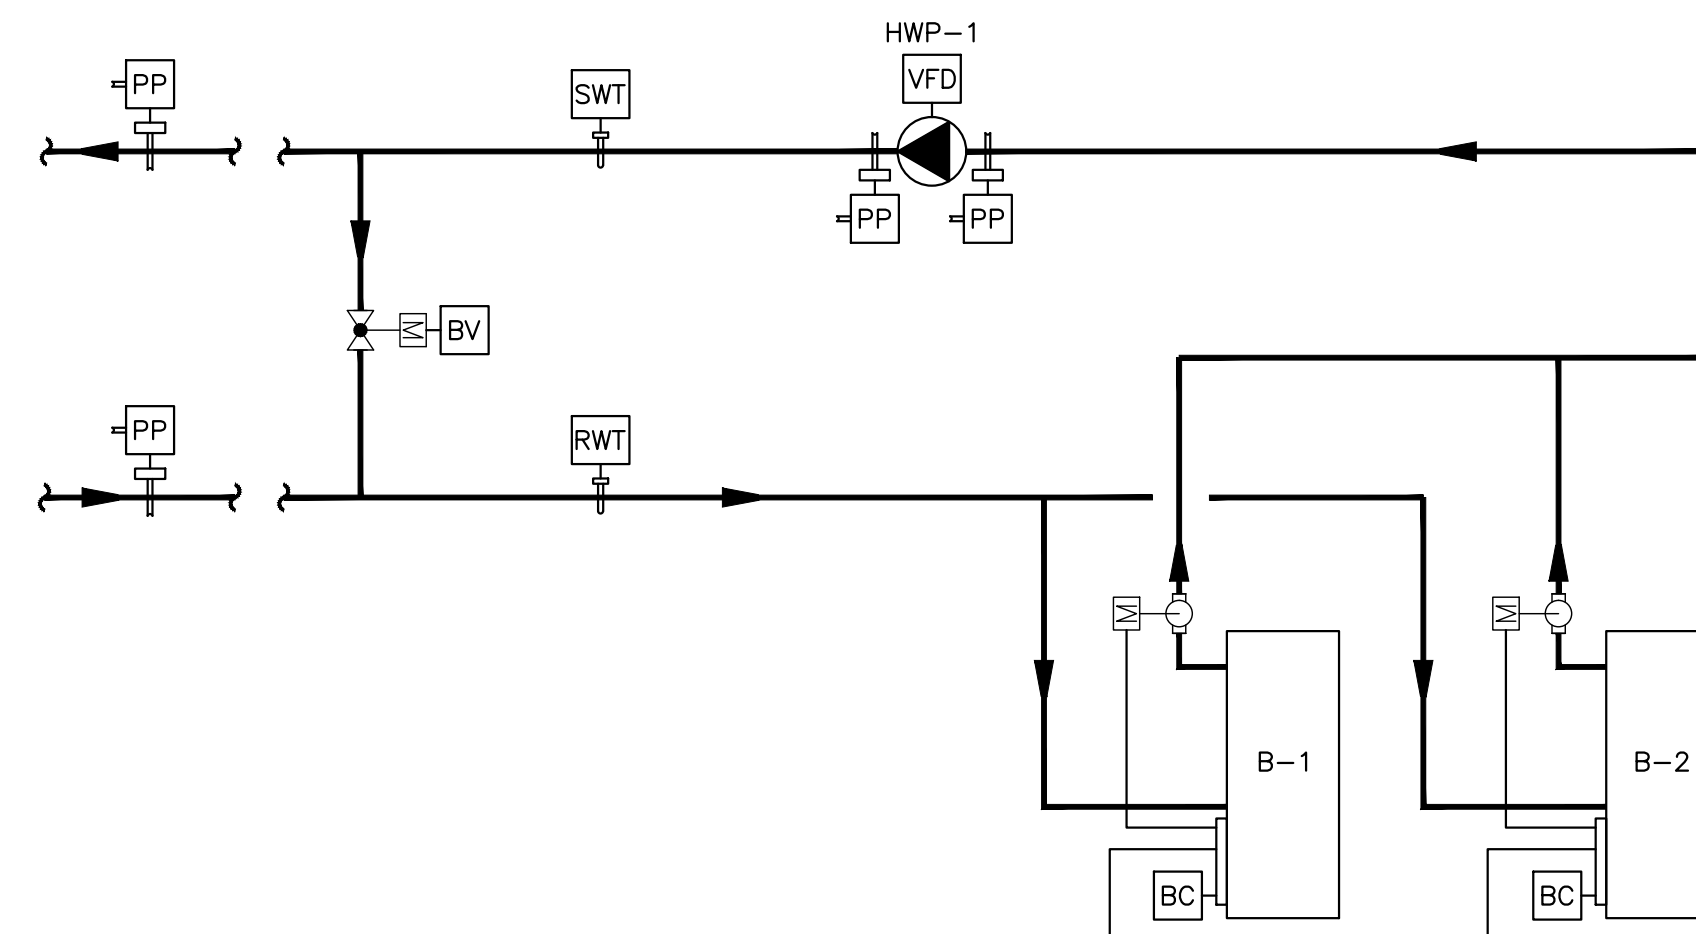

POINT	QTY.	DESCRIPTION
BC	2	BOILER CONTROLLER
BV	1	BYPASS VALVE ACTUATOR (NO/PC, MODULATING)
PP	4	PIPE PRESSURE SENSOR
RWT	1	RETURN WATER TEMPERATURE
SWT	1	SUPPLY WATER TEMPERATURE
VFD	1	VARIABLE FREQUENCY DRIVE

7 BOILER SYSTEM CONTROL DIAGRAM  
SCALE: NTS



POINT	QTY.	DESCRIPTION
HS	1	HORN STROBE
COM	1	CARBON MONOXIDE MONITOR

8 BOILER ROOM AIR QUALITY CONTROL DIAGRAM  
SCALE: NTS

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**MIP DESIGN GROUP**  
ARCHITECTURE  
Bradford A. Jones, Architect

**MAHG 191089 REPAIR BLAKE GYM  
KEESLER AIR FORCE BASE**  
1201 H STREET, BLDG 1201  
KAFB - BILOXI, MS 39534

SCALE: AS INDICATED
PROJECT NO: 0110.20.002
DRAWN BY: JMV
CHECKED BY: JMV

MECHANICAL CONTROL DIAGRAMS

NO.	DATE	REVISION / SUBMITTAL	ISSUED FOR CONSTRUCTION

NO.	DATE	REVISION / SUBMITTAL	ISSUED FOR CONSTRUCTION

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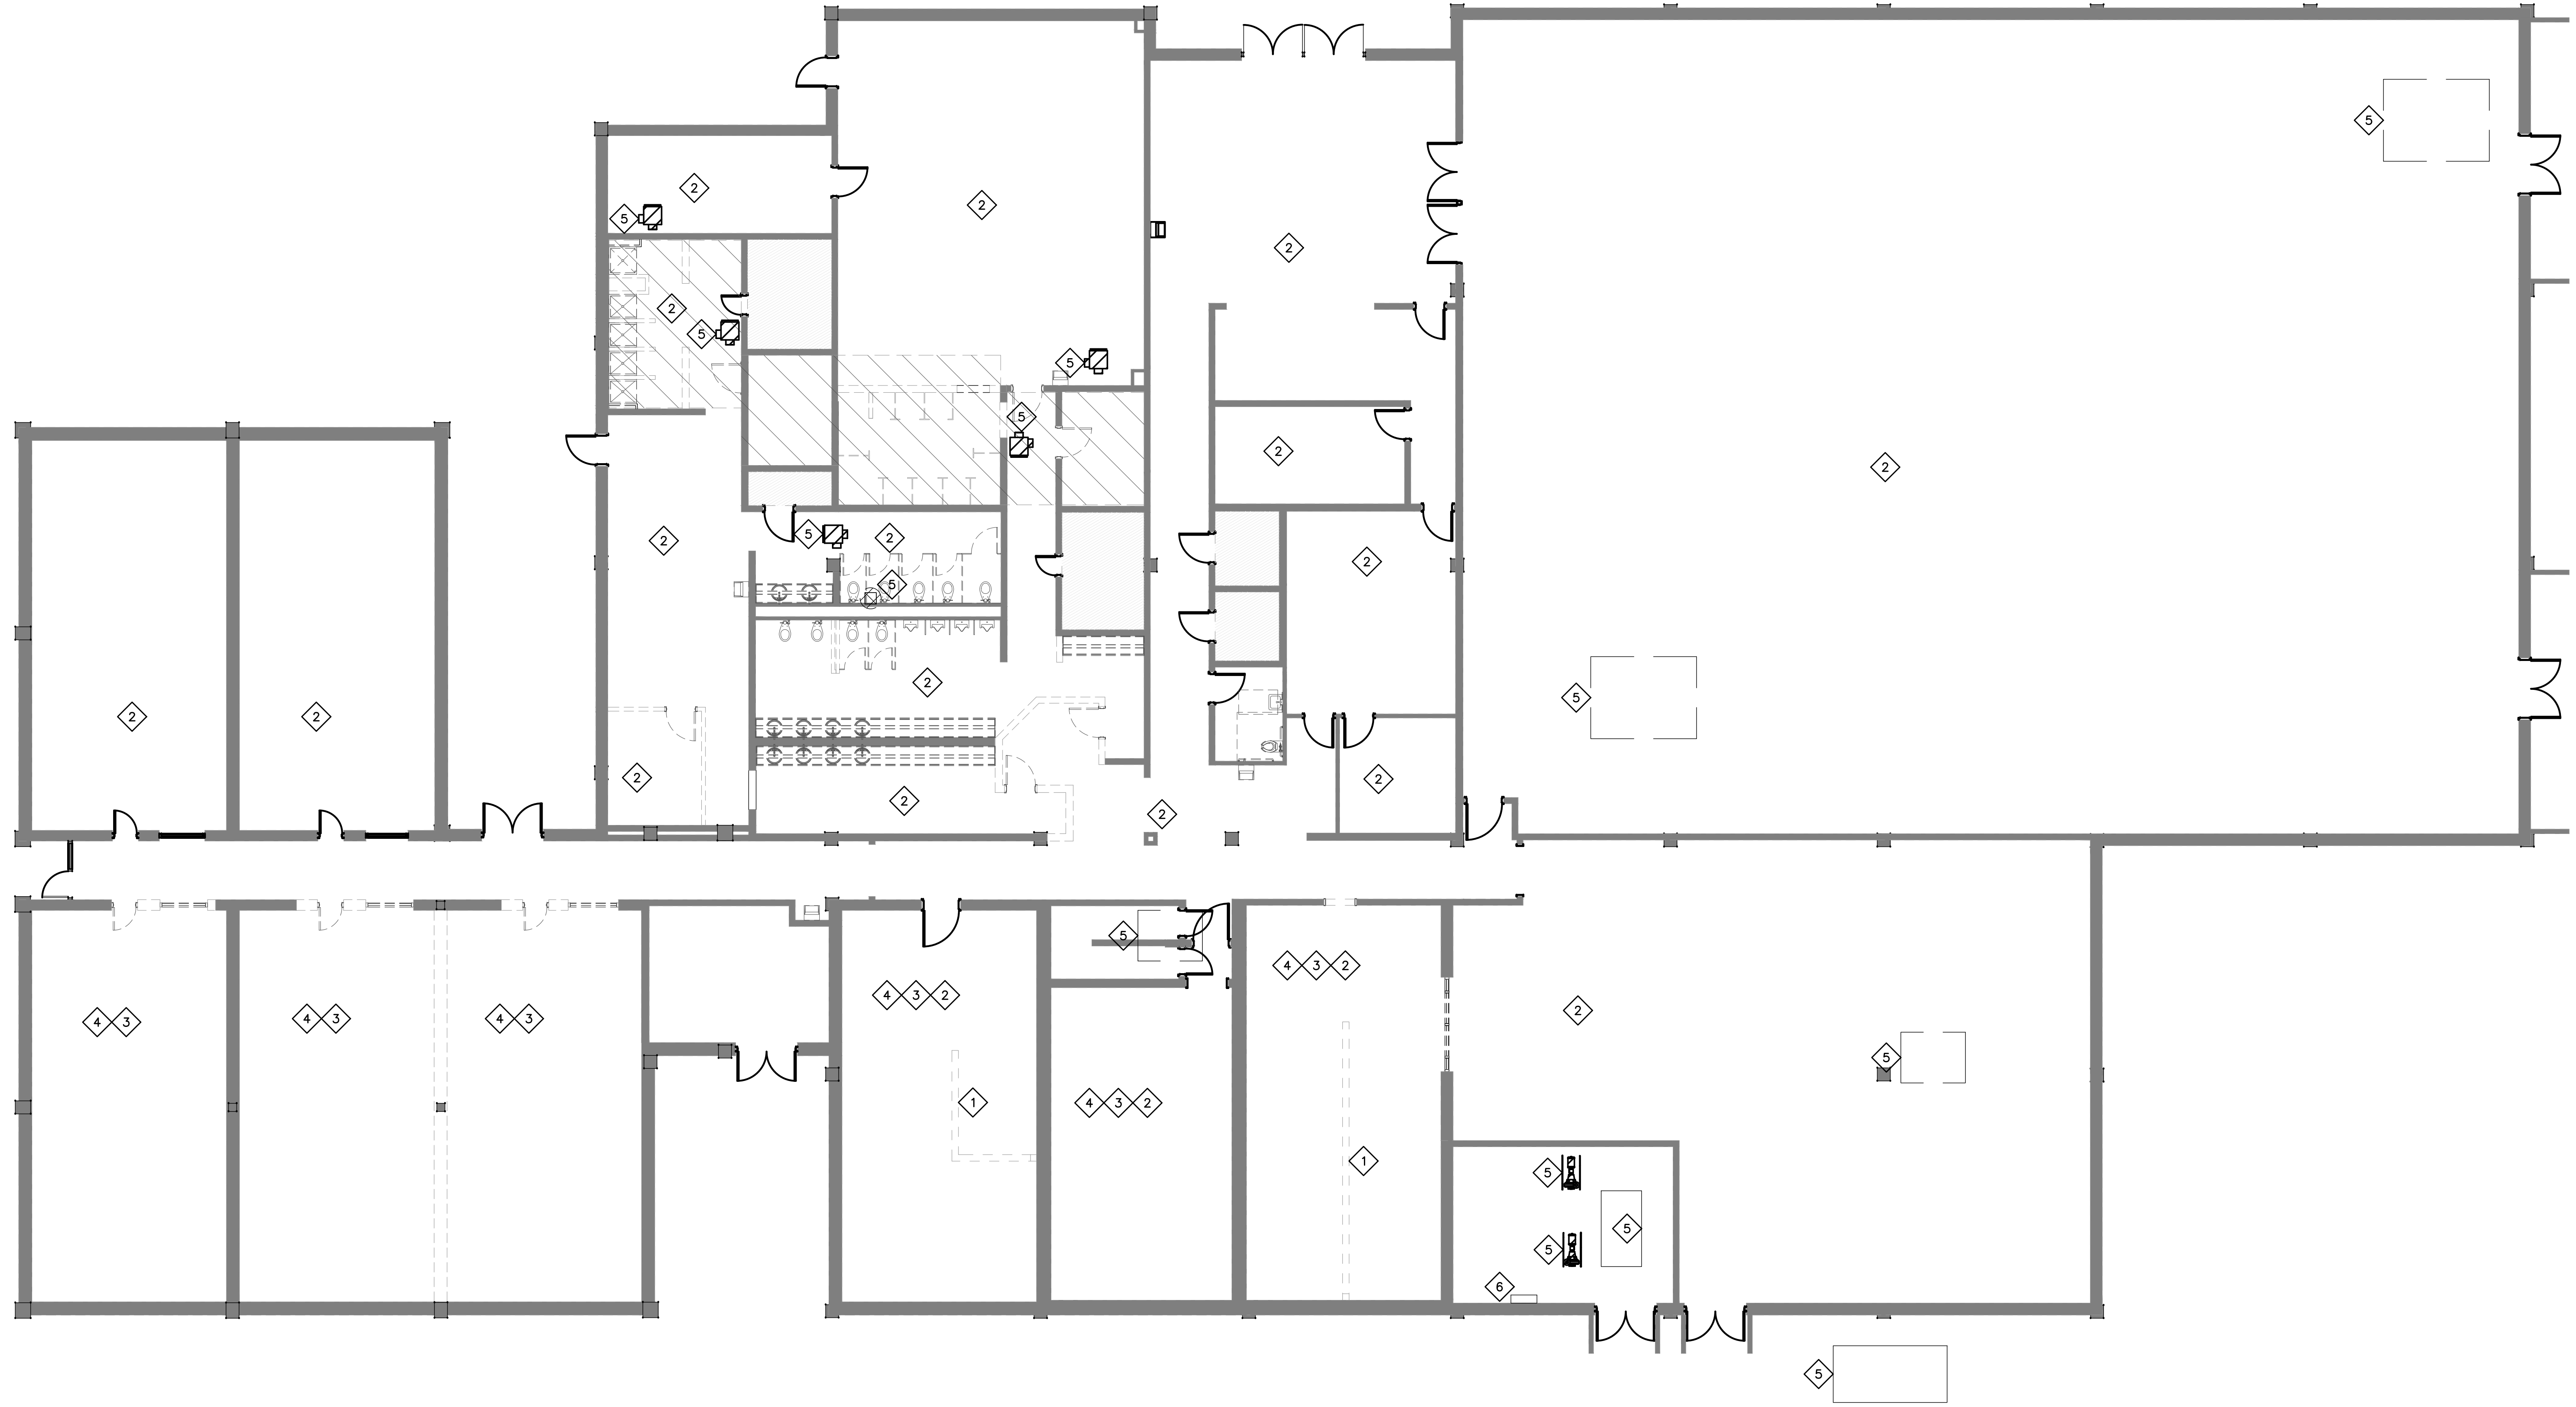







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- DRAWING E011 SPECIFIC NOTES**
- 1 CONTRACTOR SHALL DEMOLISH EXISTING WOODEN CABLE CHASE SYSTEM AND REMOVE CABLE AND CONDUIT BACK TO SOURCE.
  - 2 CONTRACTOR SHALL REPLACE POWER AND DATA RECEPTACLES AND FACEPLATES. CONTRACTOR SHALL VERIFY COUNT PRIOR TO BIDDING.
  - 3 CONTRACTOR SHALL REMOVE EXISTING WALL MOUNT DEVICES AND STORE WITH CARE FOR FUTURE INSTALLATION.
  - 4 CONTRACTOR SHALL DEMOLISH ALL EXISTING SURFACE MOUNT RECEPTACLES, CABLE, AND CONDUIT BACK TO SOURCE. UPDATE PANEL SCHEDULE WITH "SPARE" WHERE CIRCUITS ARE DEMOLISHED. CONTRACTOR SHALL VERIFY COUNT PRIOR TO BIDDING.
  - 5 CONTRACTOR SHALL DEMOLISH EQUIPMENT CONNECTION, REMOVE BRANCH CIRCUIT BACK TO SOURCE. LABEL BREAKER AS SPARE.
  - 6 DEMOLISH EXISTING LDP PANEL, DEMOLISH EXISTING SERVICE ENTRANCE FEEDER AND CONDUIT BACK TO SECONDARY SIDE OF TRANSFORMER. PRESERVE ALL BRANCH CIRCUIT CABLE AND CONDUIT FOR CONNECTION TO NEW PANEL.



**1 ELECTRICAL DEMOLITION FLOOR PLAN**  
 SCALE: 1/8" = 1'

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**M | P DESIGN | GROUP**  
 ARCHITECTURE  
 Bradford A. Jones, Architect

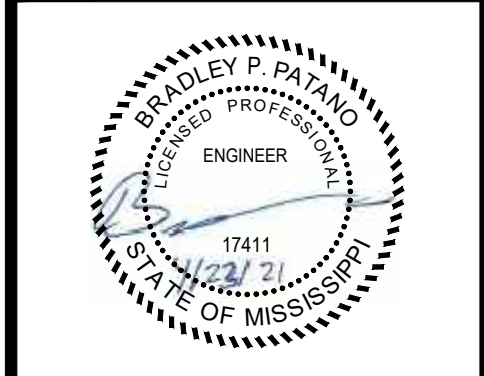

**MAHG 191089 REPAIR BLAKE GYM**  
**KEESLER AIR FORCE BASE**  
 1201 H STREET, BLDG 1201  
 KAFB - BILOXI, MS 39534

SCALE: AS INDICATED  
 PROJECT NO: 0110.20.002  
 DRAWN BY: TJA  
 CHECKED BY: KBB

**ELECTRICAL DEMOLITION FLOOR PLAN**

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**E011**

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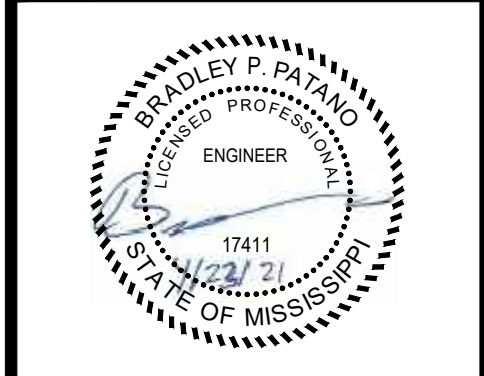
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- DRAWING E012 SPECIFIC NOTES**
- 1 CONTRACTOR SHALL DEMOLISH LIGHT FIXTURES, REMOVE BRANCH CIRCUIT TO NEAREST JUNCTION BOX.
  - 2 CONTRACTOR SHALL REMOVE LIGHT FIXTURE AND STORE FOR FUTURE INSTALLATION. PRESERVE BRANCH CIRCUIT FOR FUTURE USE.
  - 3 CONTRACTOR SHALL REMOVE ALL FIRE ALARM DEVICES AND STORE FOR FUTURE. PRESERVE CABLE AND CONDUIT FOR FUTURE USE. CONTRACTOR SHALL VERIFY COUNTS PRIOR TO BIDDING.
  - 4 CONTRACTOR SHALL REMOVE ALL INTERCOM/SECURITY DEVICES AND STORE FOR FUTURE. PRESERVE CABLE AND CONDUIT FOR FUTURE USE.
  - 5 CONTRACTOR SHALL DEMOLISH EXISTING CAN LIGHTS, REMOVE BRANCH CIRCUIT BACK TO NEAREST JUNCTION BOX.



1 ELECTRICAL DEMOLITION CEILING PLAN  
 SCALE: 1/8" = 1'

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**MIP DESIGN | GROUP**  
 ARCHITECTURE  
 Bradford A. Jones, Architect



**MAHG 191089 REPAIR BLAKE GYM**  
**KEESLER AIR FORCE BASE**  
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 KAFB - BILOXI, MS 39534

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 DRAWN BY: TJA  
 CHECKED BY: KBB

**ELECTRICAL DEMOLITION CEILING PLAN**


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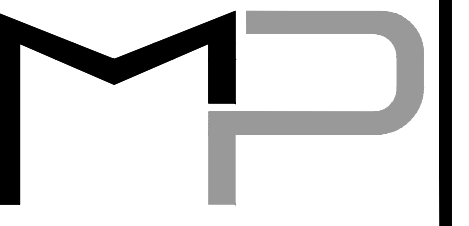


**DRAWING E101 NOTES**

1. ALL UNDERGROUND CONDUIT FITTINGS SHALL BE 36" LONG RADIUS.
2. ALL EXTERIOR CONDUIT ABOVE GRADE SHALL BE RIGID GALVANIZED STEEL.
3. SAW CUT THROUGH EXISTING ASPHALT AND CONCRETE AND RETURN SURFACE GRADE MATERIALS AND GROUND TO ORIGINAL CONDITION.
4. ALL CONDUIT SHALL BE AT LEAST 36" BELOW GRADE.

**DRAWING E101 SPECIFIC NOTES**

1. EXISTING PAD MOUNT TRANSFORMER WILL NEED TO BE REMOVED IN ORDER TO INSTALL NEW CONDUIT. CONTRACTOR SHALL COORDINATE WITH CONTRACTING OFFICER FOR REMOVAL AND RE-INSTALLATION OF EXISTING PAD MOUNT TRANSFORMER. CONTRACTOR SHALL COORDINATE OUTAGES. CONTRACTOR SHALL GIVE OWNER 2 WEEK NOTIFICATION PRIOR TO OUTAGE AND OUTAGE MUST BE PERFORMED ON A WEEKEND.
2. ELECTRICAL/ MECHANICAL ROOM.

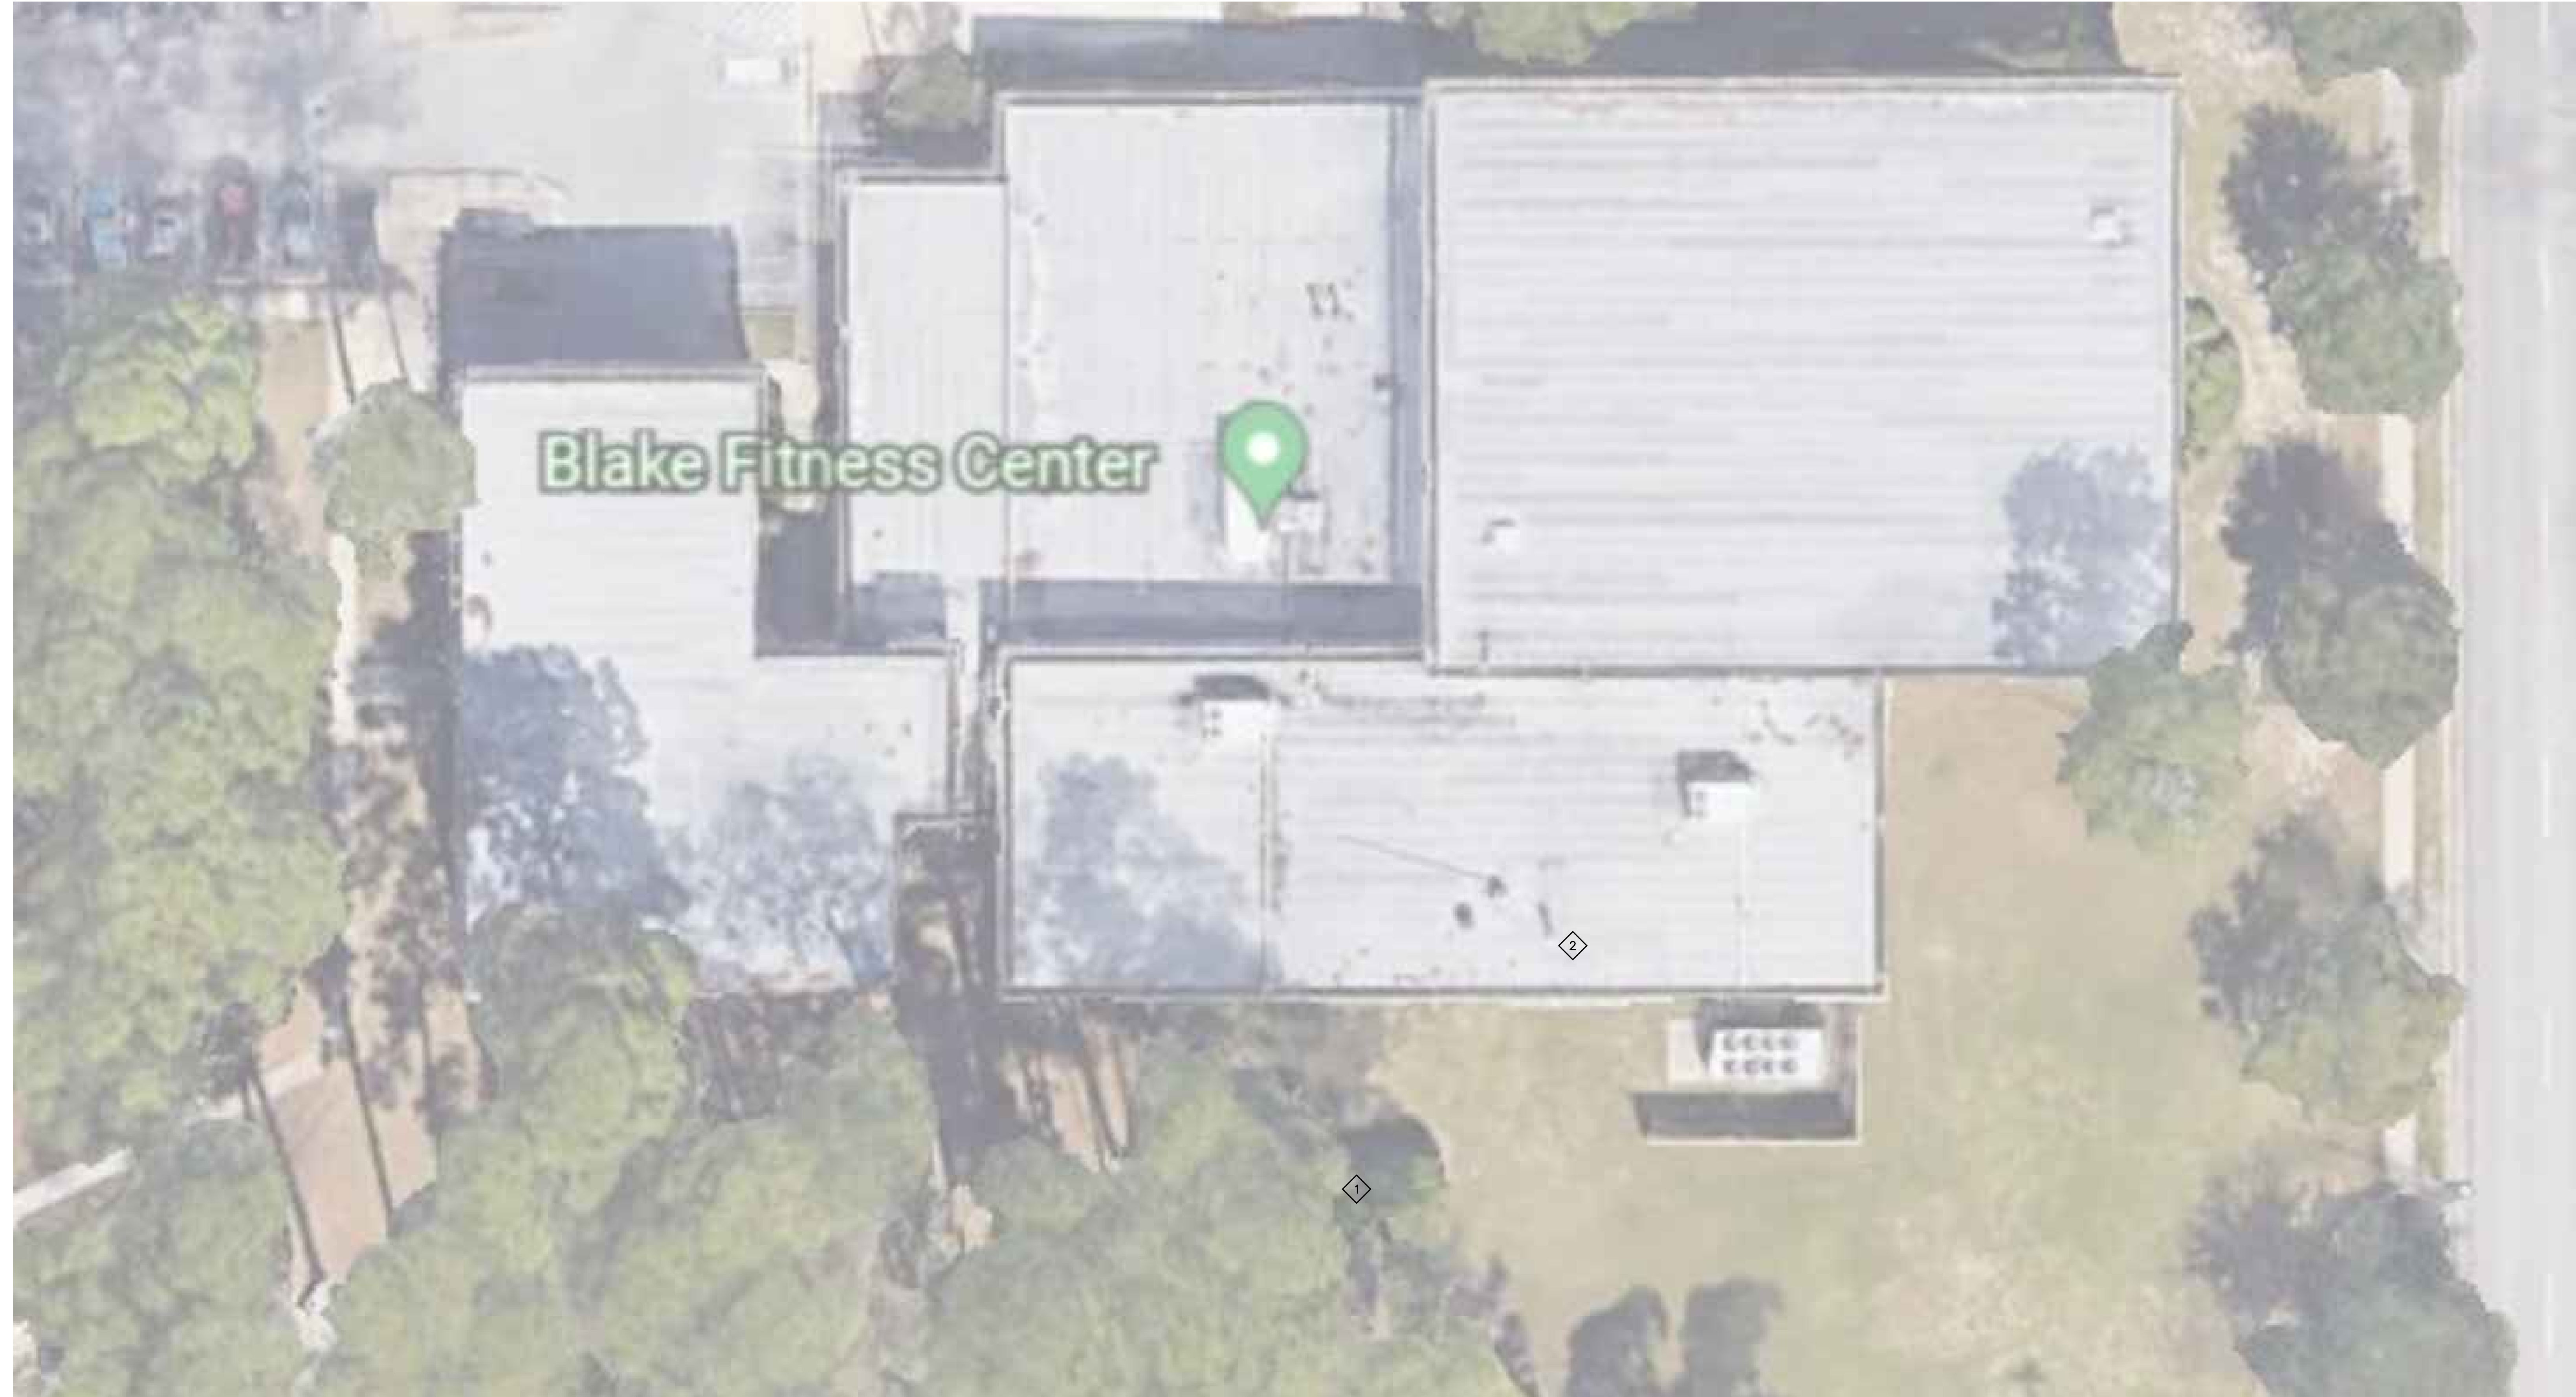


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**MIP DESIGN | GROUP**

ARCHITECTURE  
Bradford A. Jones, Architect



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1201 H STREET, BLDG 1201  
KAFB - BILOXI, MS 39534

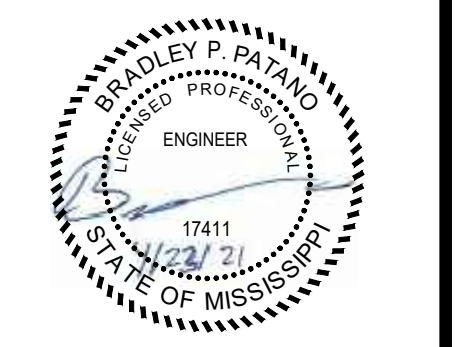SCALE: AS INDICATED  
PROJECT NO: 0110.20.002  
DRAWN BY: TJA  
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**ELECTRICAL SITE PLAN**

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**1 ELECTRICAL SITE PLAN**  
SCALE: 3/32" = 1'



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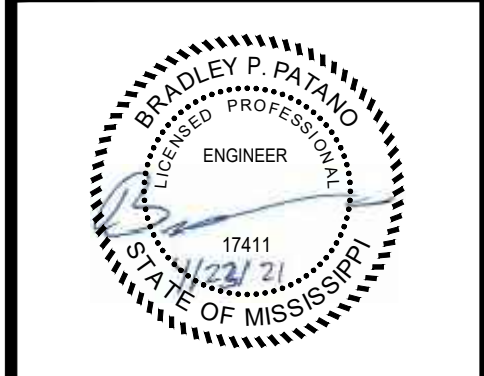


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**M/P DESIGN GROUP**  
ARCHITECTURE

Bradford A. Jones, Architect



**MAHG 191089 REPAIR BLAKE GYM**  
**KEESLER AIR FORCE BASE**  
1201 H STREET, BLDG 1201  
KAFB - BILOXI, MS 39534

SCALE: AS INDICATED  
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DRAWN BY: TJA  
CHECKED BY: KBB

**ELECTRICAL POWER PLAN**

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**DRAWING E111 NOTES**

1. ALL RECEPTACLE CIRCUITS SHALL BE #12 AWG UNLESS OTHERWISE NOTED. IF MORE THAN 100'-0" TO THE FIRST CURRENT-CONSUMING DEVICE, THEN CONDUCTOR SHALL BE #10 AWG.
2. ALL RECEPTACLES SHALL BE MOUNTED 18" AFF UNLESS OTHERWISE NOTED.
3. ALL EXISTING RECEPTACLES SHALL BE REPLACED AND NEW FACEPLATES SHALL BE INSTALLED.

**DRAWING E111 SPECIFIC NOTES**

1. CONTRACTOR SHALL PROVIDE DS4000 SERIES RACEWAY, COORDINATE SIZE BASED FILL REQUIREMENTS FROM MANUFACTURER'S RECOMMENDATIONS.



**1 ELECTRICAL POWER PLAN**  
SCALE: 1/8" = 1'

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17111  
4/23/21  
TJA




**DRAWING E121 NOTES**

1. ALL LIGHTING CIRCUITS SHALL BE #12 AWG UNLESS OTHERWISE NOTED. IF MORE THAN 100'-0" TO THE FIRST CURRENT-CONSUMING DEVICE, THEN CONDUCTOR SHALL BE #10 AWG.
2. REFERENCE ARCHITECTURAL REFLECTED CEILING PLANS FOR EXACT MOUNTING LOCATIONS IN ARCHITECTURAL FINISHES.
3. REFERENCE ARCHITECTURAL PLANS FOR EXACT MOUNTING HEIGHTS OF LIGHT FIXTURES.
4. ALL LIGHT FIXTURES DESIGNATED EX REMOVED DURING DEMOLITION SHALL BE REINSTALLED MODIFY BRANCH CIRCUITS AS REQUIRED FOR REINSTALLATION.
5. CONTRACTOR SHALL CLEAN ALL LIGHT FIXTURES AND CHECK FOR PROPER OPERATION PRIOR TO REINSTALLATION.

**DRAWING E121 SPECIFIC NOTES**

1. CONTRACTOR SHALL REINSTALL EXISTING LIGHTS (EX) UTILIZING EXISTING BRANCH CIRCUITS. MODIFY BRANCH CIRCUITS AS REQUIRED.

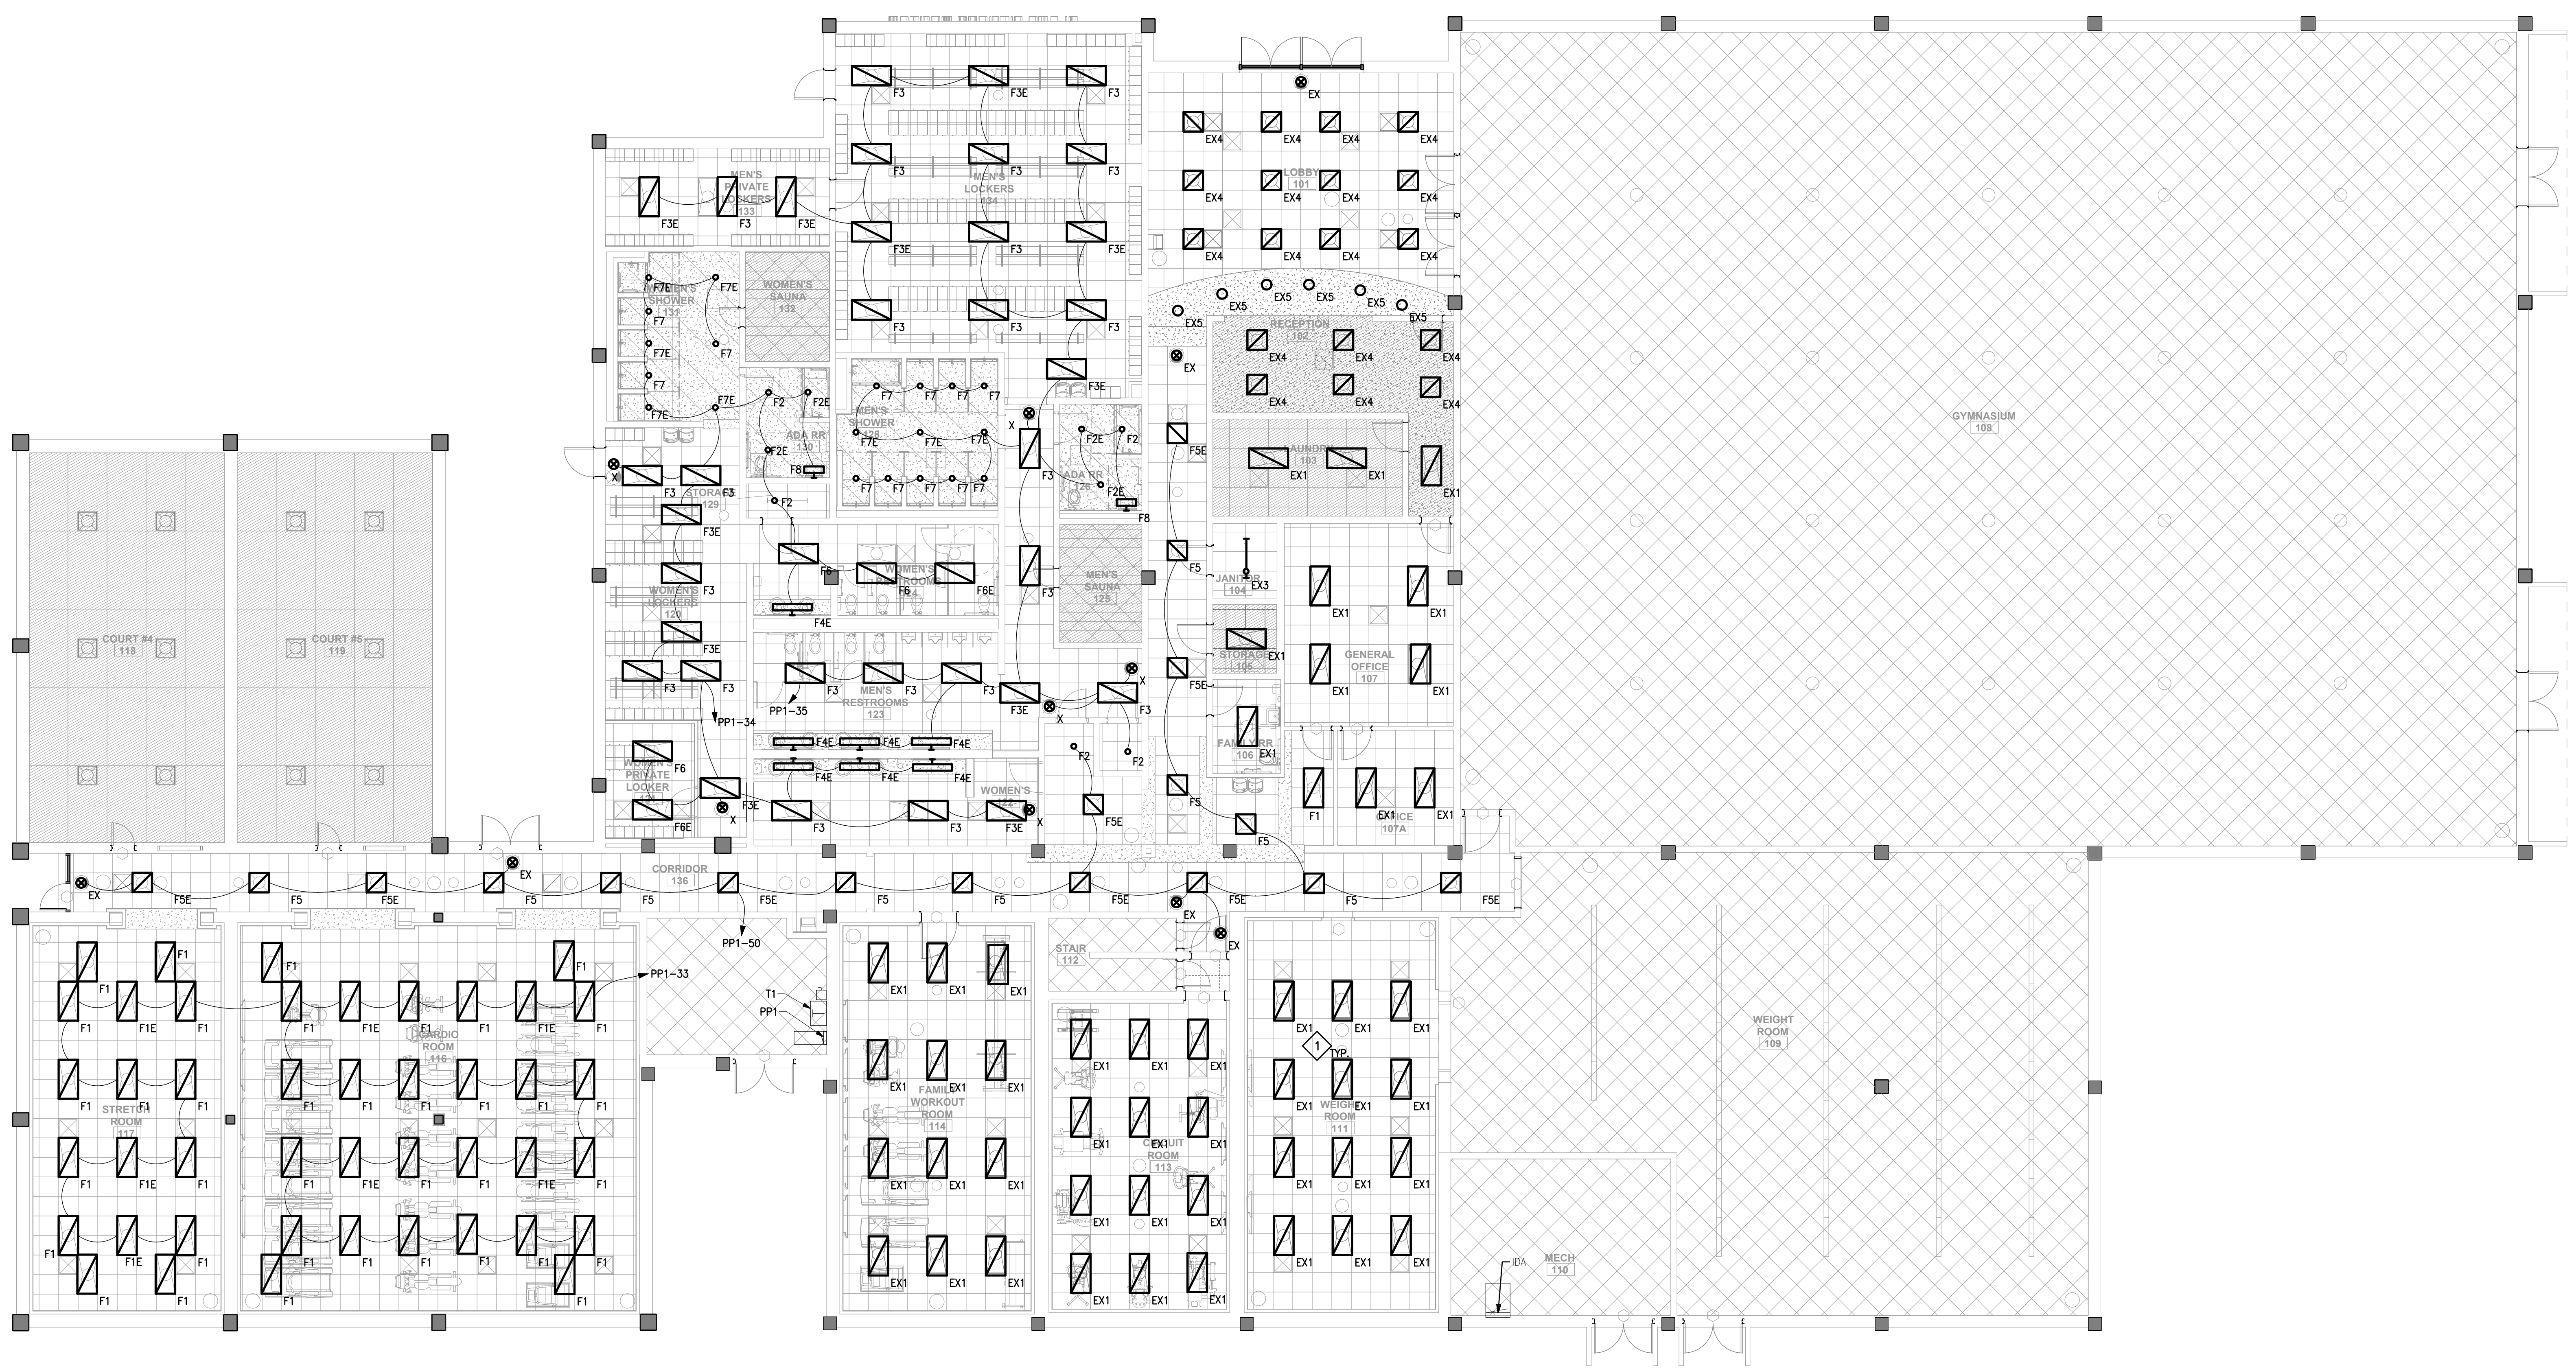

**1 ELECTRICAL LIGHTING PLAN**  
SCALE: 1/8" = 1'

**MAHG 191089 REPAIR BLAKE GYM**  
**KEESLER AIR FORCE BASE**  
1201 H STREET, BLDG 1201  
KAFB - BILOXI, MS 39534

SCALE: AS INDICATED  
PROJECT NO: 0110.20.002  
DRAWN BY: TJA  
CHECKED BY: KBB

**ELECTRICAL LIGHTING PLAN**

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**E121**  
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DRAWING E122 NOTES


1. CONTRACTOR SHALL INCLUDE ALL EQUIPMENT AND CABLING NECESSARY FOR A COMPLETE AND OPERABLE SYSTEM. CONTRACTOR SHALL INCLUDE ALL CAT 6 CABLING TO INTERLINK EACH PIECE OF LIGHTING CONTROL EQUIPMENT. CONTRACTOR SHALL REFERENCE LIGHTING CONTROL RISER DIAGRAMS ON SHEET EES1 AND EES2. CAT 6 CABLE MAY BE ROUTED ON J-HOOKS ABOVE ACCESSIBLE CEILING. ABOVE NON-ACCESSIBLE CEILING, CAT 6 CABLE SHALL BE ROUTED IN CONDUIT.

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**MIP DESIGN GROUP**  
ARCHITECTURE

Bradford A. Jones, Architect



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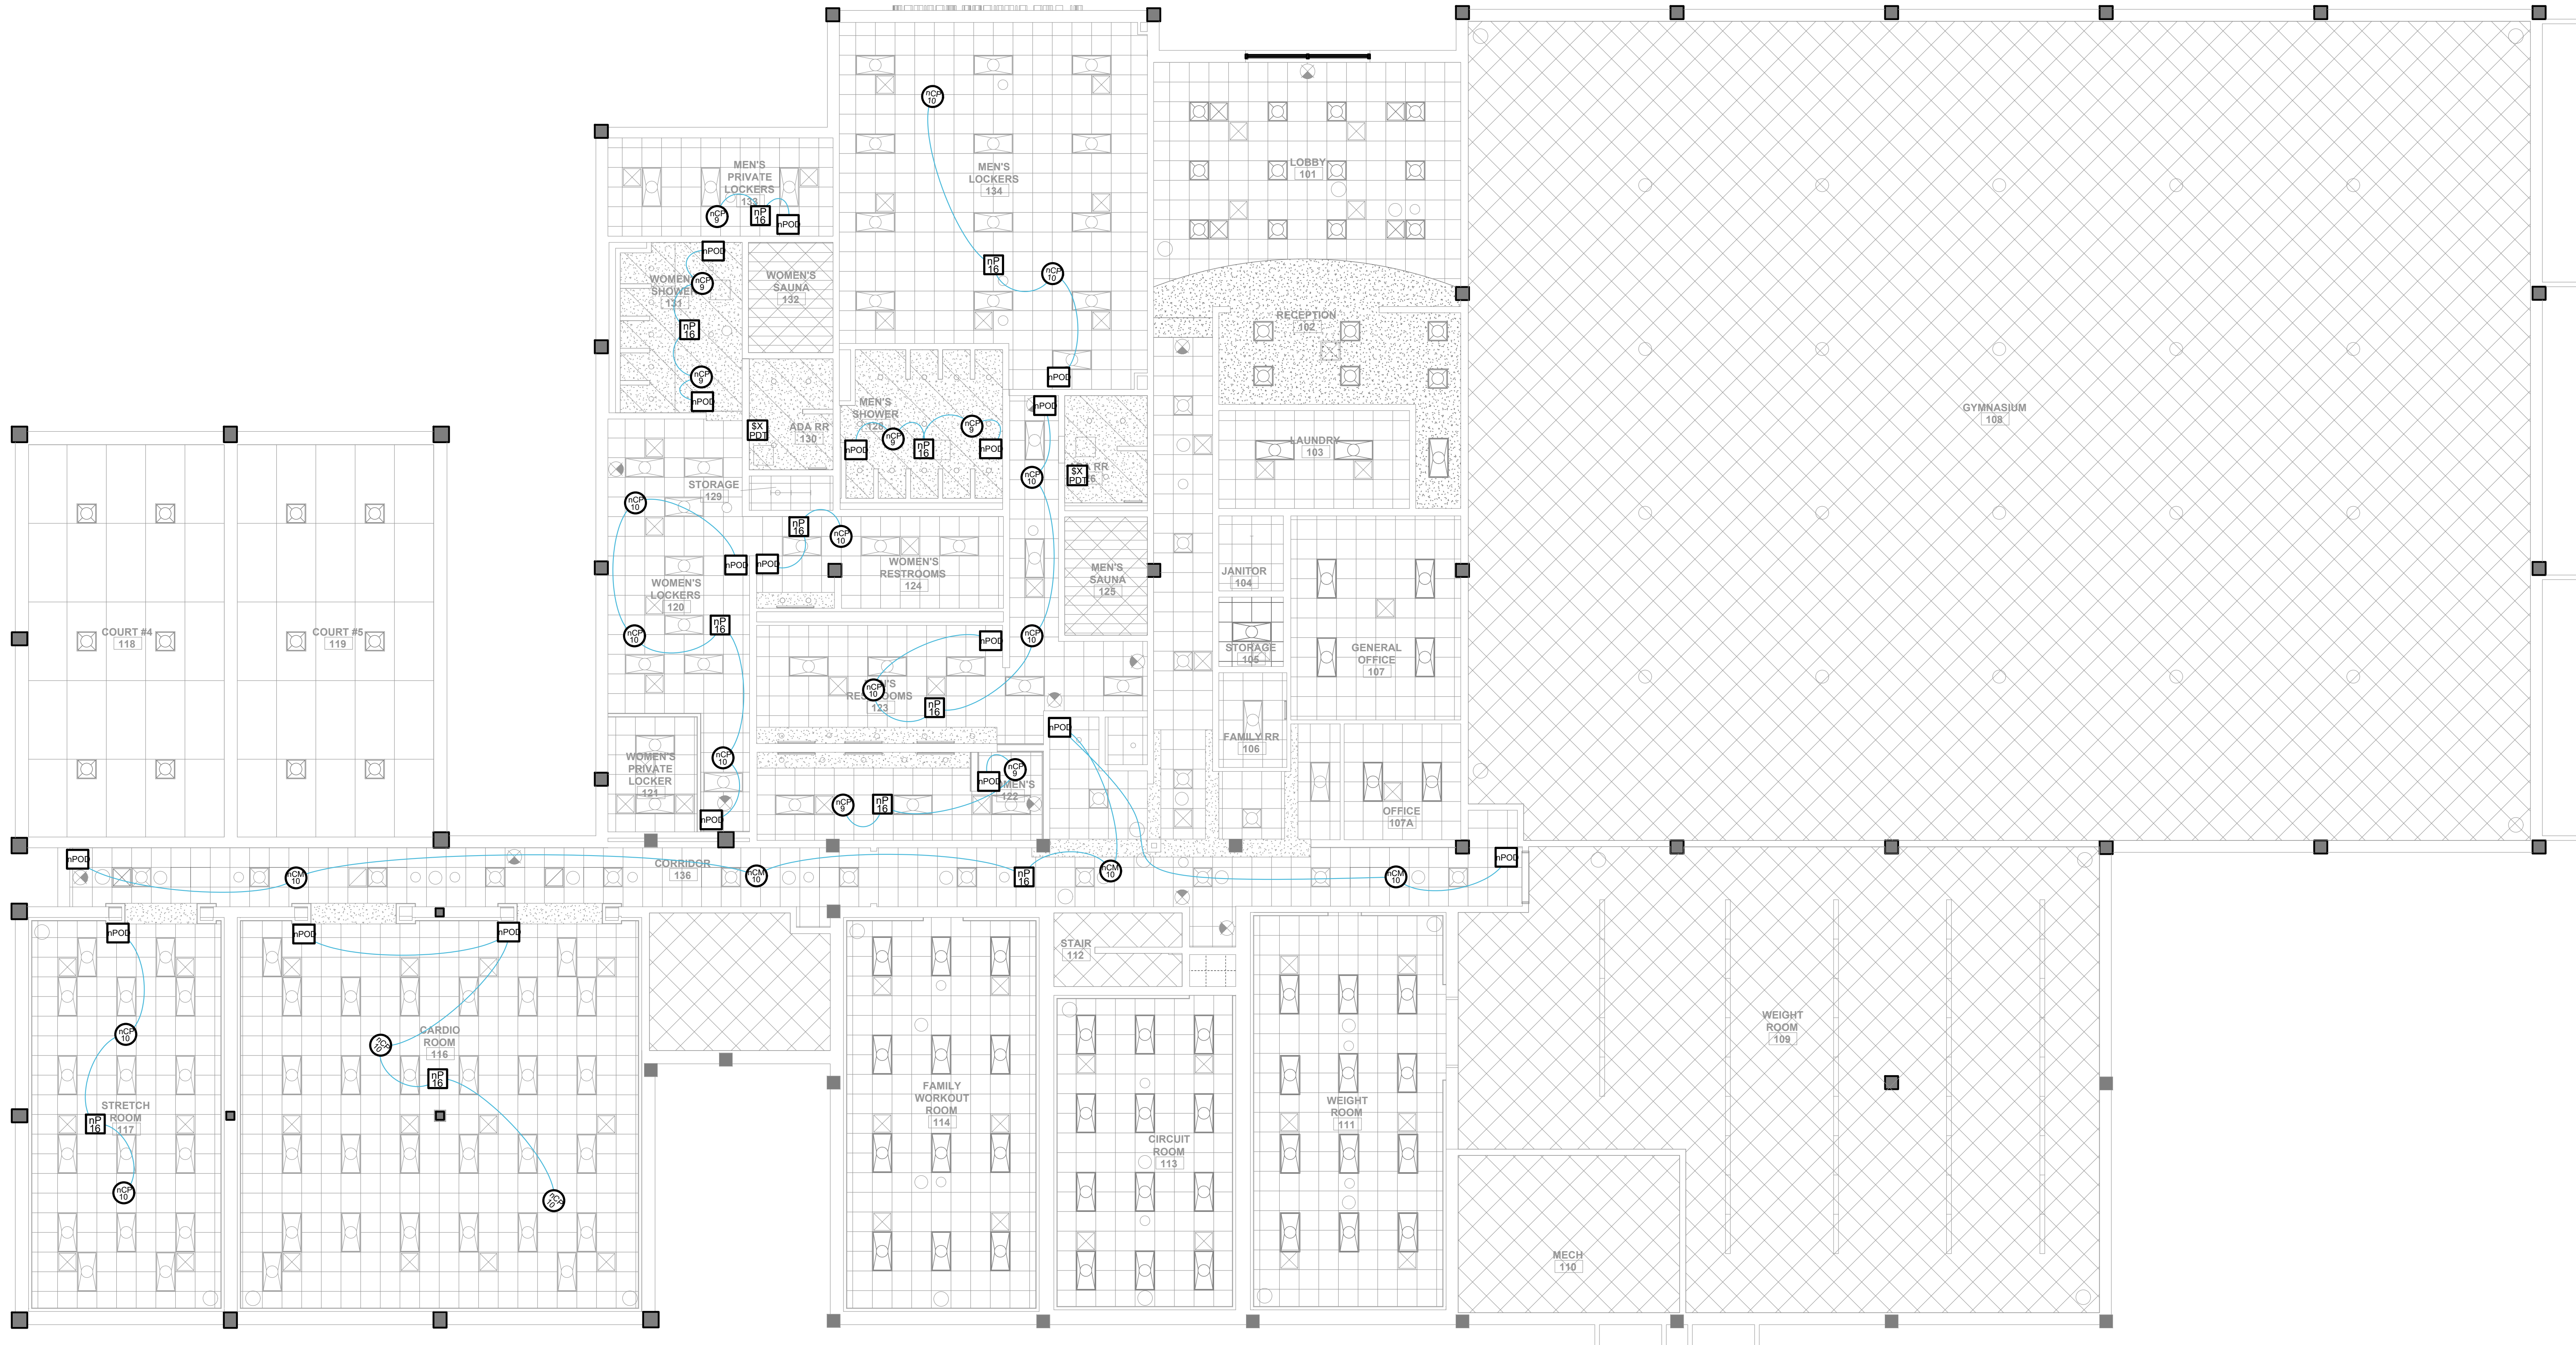
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ELECTRICAL LIGHTING CONTROLS PLAN
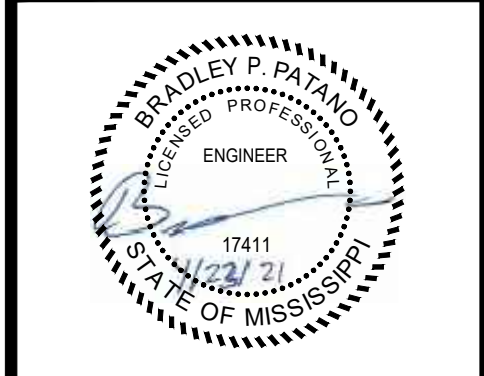
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**E122**

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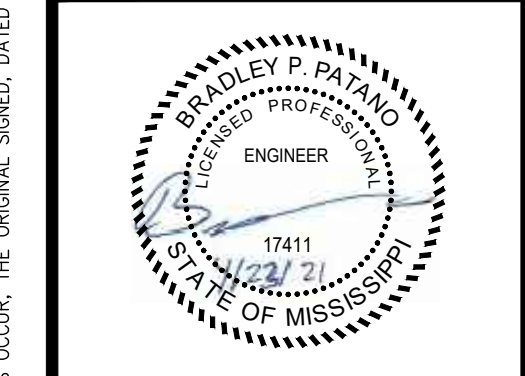


**1 ELECTRICAL LIGHTING CONTROLS PLAN**  
SCALE: 1/8" = 1'

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**ELECTRICAL SPECIAL SYSTEMS PLAN**

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**E141**  
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- DRAWING E141 SPECIFIC NOTES**
- CONTRACTOR SHALL ROUTE CAT 6 CABLES AND COAX IN FLOOR WIRE MOLD IN FRONT OF MACHINES. EACH PIECE OF EQUIPMENT REQUIRES A HOMERUNNED COAX AND CAT 6 CABLE.
  - CONTRACTOR SHALL PROVIDE DSA4000 SERIES RACEWAY. COORDINATE SIZE BASED FILL REQUIREMENTS FROM MANUFACTURER'S RECOMMENDATIONS.
  - COMMUNICATION RACK LOCATION.

- DRAWING E141 NOTES**
- CONTRACTOR SHALL INSTALL 3/4" CONDUIT WITH 2 CAT 6 CABLES FROM DATA OUTLET BACK TO THE COMMUNICATION RACK. COORDINATE WITH OWNER FOR EXACT LOCATION AND TERMINATION.
  - SEE DRAWING E002 FOR GENERAL FIRE ALARM NOTES.
  - INSTALL PULL STRINGS IN ALL EMPTY CONDUITS.
  - ALL EXISTING DATA OUTLETS SHALL BE REPLACED AND NEW FACEPLATES SHALL BE INSTALLED.
  - ALL EXISTING FIRE ALARM DEVICES REMOVED DURING DEMOLITION SHALL BE REINSTALLED IN NEW CEILING.
  - ALL EXISTING INTERCOM/SECURITY DEVICES REMOVED DURING DEMOLITION SHALL BE REINSTALLED IN NEW CEILING.
  - ALL CABLING SHALL BE TIA/EIA CATEGORY 6 RATED.
  - CABLE COLOR CODING SHALL BE AS FOLLOWS:  
 8.1. ALARMS/CAMERAS – YELLOW  
 8.2. PUBLIC ADDRESS (PA) SYSTEMS – GRAY  
 8.3. SECURE COMM (ENCRYPTED) – RED  
 8.4. DATA/VOICE – BLUE
  - CONTRACTOR SHALL BE RESPONSIBLE FOR INSTALLING 2 POST DATA RACK IN STORAGE ROOM 105, ROUTING ALL CAT 6 CABLING BACK TO STORAGE ROOM 105, AND TERMINATIONS AT OUTLETS. OWNER IS RESPONSIBLE FOR FINAL TERMINATIONS AT SWITCH, NETWORK SWITCH (CISCO 9300-241-A) AND BACKUP POWER SUPPLY (EATON 3000 SERIES UPS) IS PROVIDED AND INSTALLED BY OWNER.
  - ALL WIRING, TERMINATIONS, RACKS AND LABELING SHALL BE IN ACCORDANCE WITH 81ST COMMUNICATIONS SQUADRON PREMISE WIRING GUIDANCE.
  - ALL DATA AND COAX RUNS SHALL BE HOMERUNS BACK TO STORAGE ROOM 105 FROM RECEPTACLES.
  - CONTRACTOR SHALL PROVIDE DEDICATED COAX CABLE FROM EACH TV BACK TO STORAGE ROOM 105.
  - CONTRACTOR SHALL REINSTALL ALL EXISTING WALL MOUNTED DEVICES (FIRE ALARM, SECURITY, ETC.) REMOVED DURING DEMOLITION.



**1 ELECTRICAL SPECIAL SYSTEMS PLAN**  
 SCALE: 1/8" = 1'

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DRAWING E151 NOTES


1. ALL SAFETY SWITCHES SHALL BE PROVIDED AND MOUNTED BY THE E.C. COORDINATE EXACT REQUIREMENTS WITH THE EQUIPMENT MANUFACTURER.
2. COORDINATE EXACT WIRING REQUIREMENTS WITH THE MECHANICAL CONTRACTOR PRIOR TO ROUGHING IN.

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**MECHANICAL POWER PLAN**

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**E151**


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**MECHANICAL POWER PLAN**  
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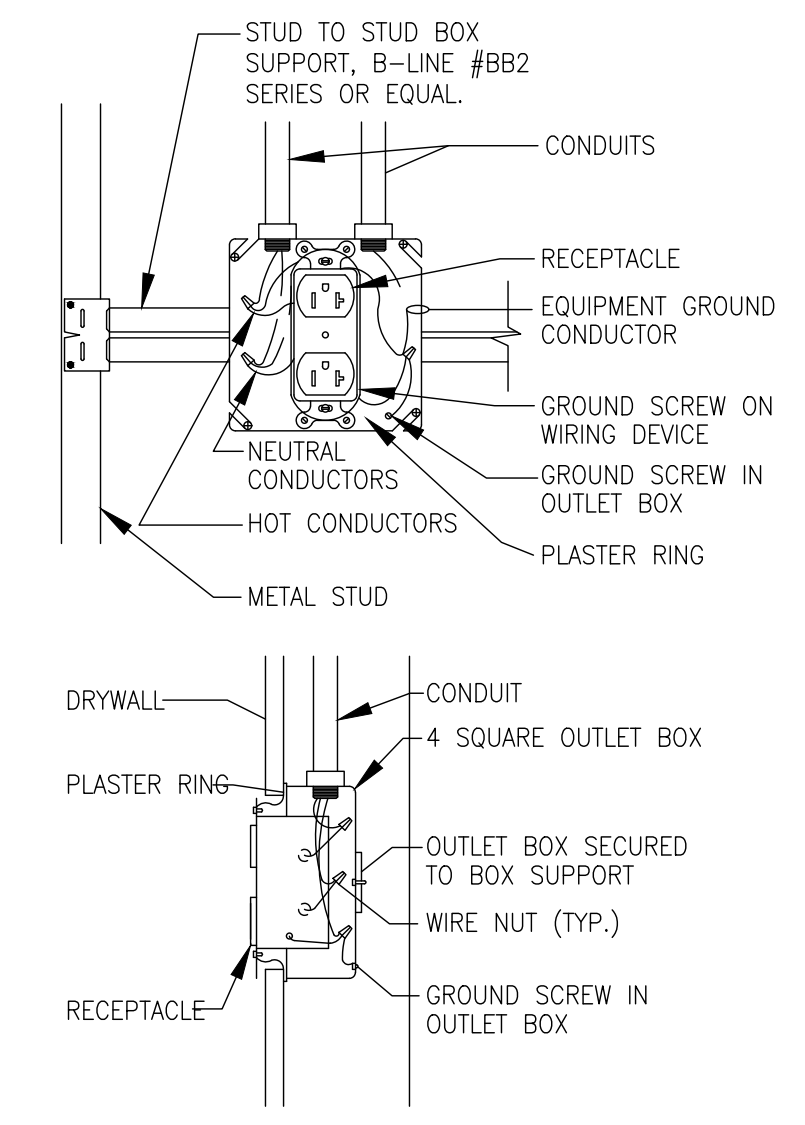
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**ELECTRICAL GENERAL DETAILS**


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**E501**

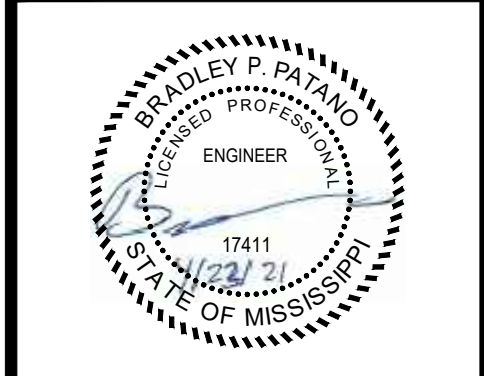
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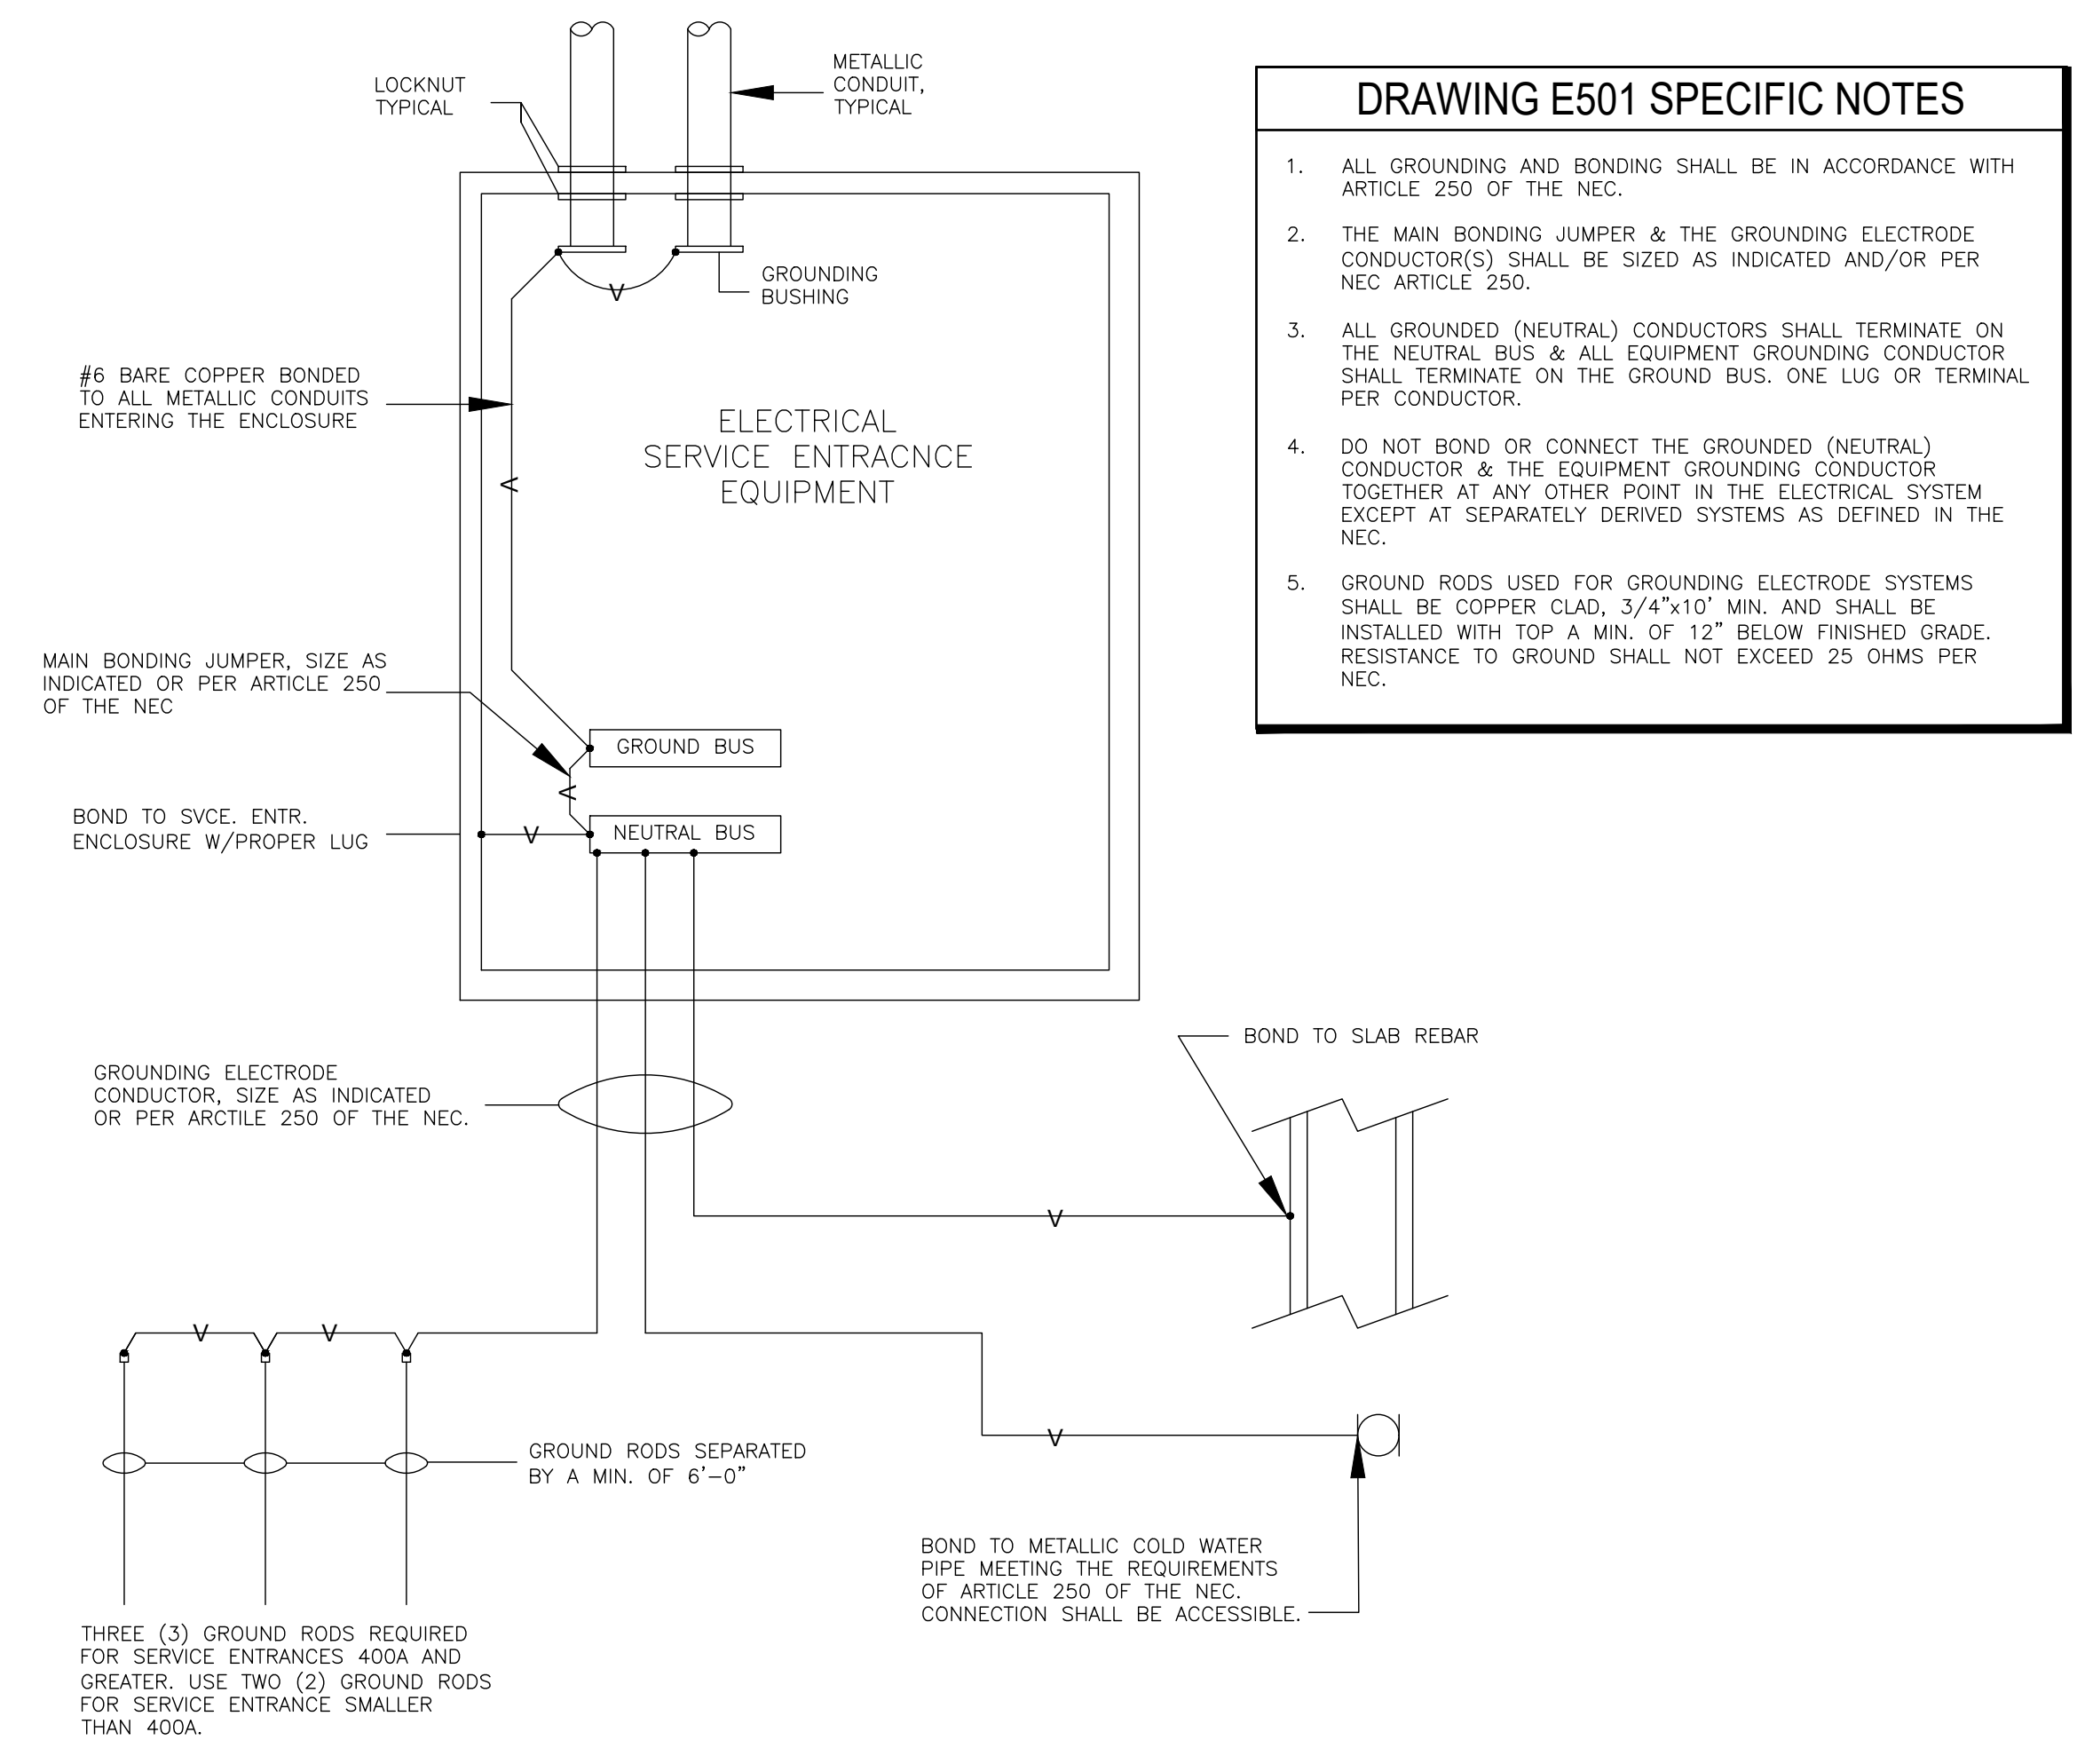
**1 RECEPTACLE MOUNTING**  
SCALE: 1/4" = 1"



**2 LAY IN FIXTURE MOUNTING**  
SCALE: 1/4" = 1"

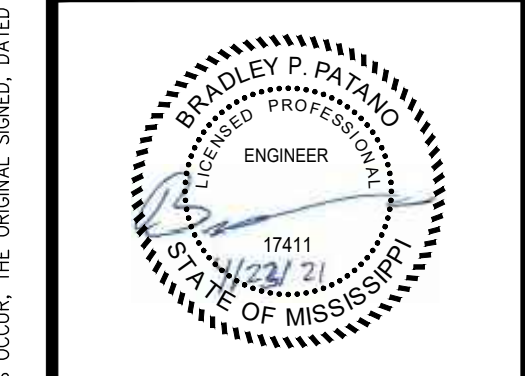


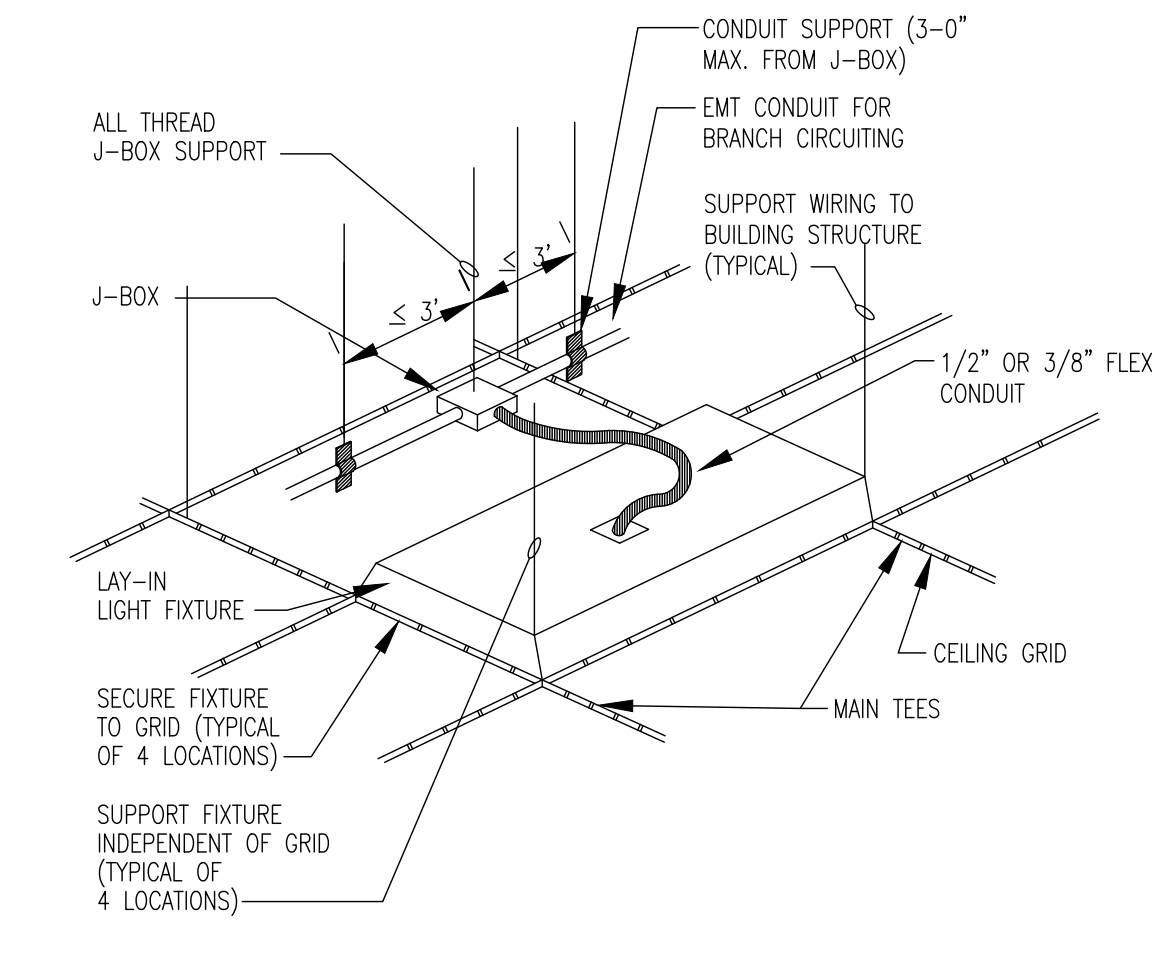
**3 FIRE ALARM DEVICE MOUNTING**  
SCALE: 1/4" = 1"

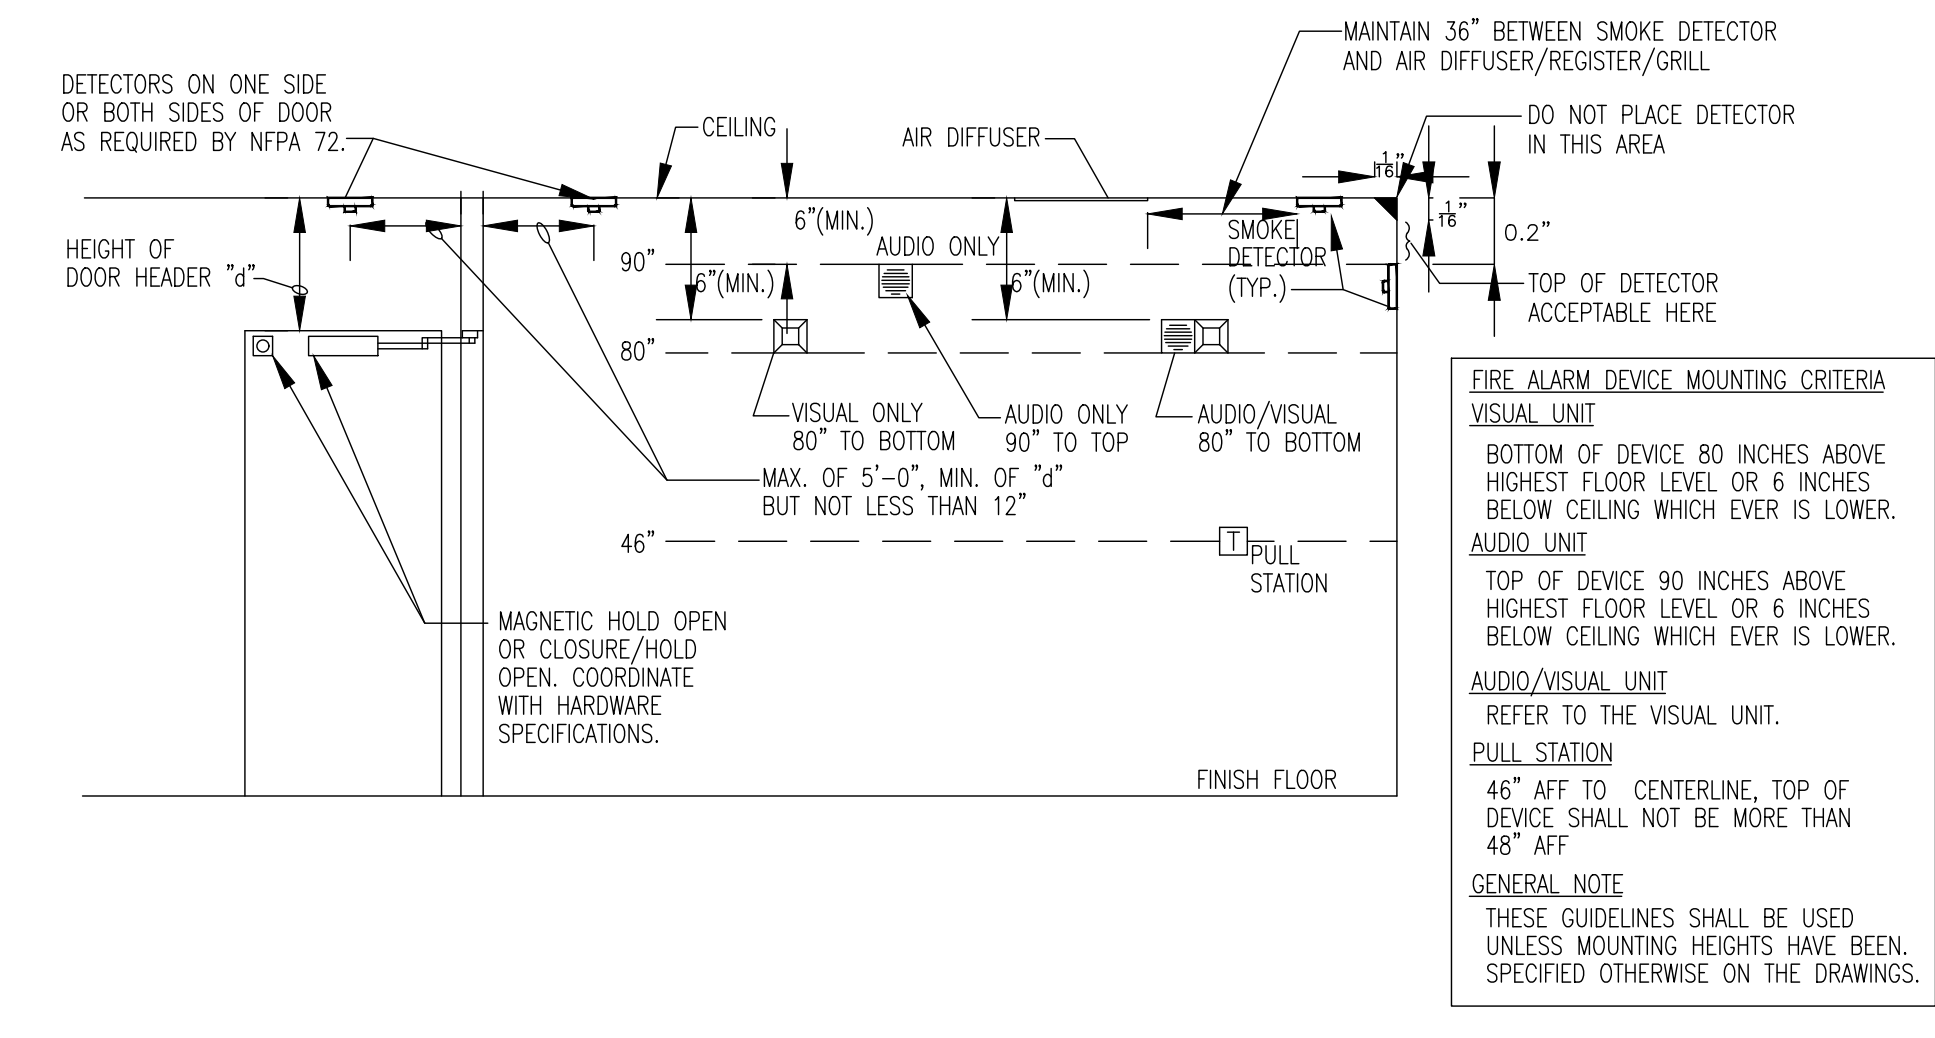

**4 GROUNDING AND BONDING DETAIL**  
SCALE: 1/4" = 1"

**DRAWING E501 SPECIFIC NOTES**

- ALL GROUNDING AND BONDING SHALL BE IN ACCORDANCE WITH ARTICLE 250 OF THE NEC.
- THE MAIN BONDING JUMPER & THE GROUNDING ELECTRODE CONDUCTOR(S) SHALL BE SIZED AS INDICATED AND/OR PER NEC ARTICLE 250.
- ALL GROUND (NEUTRAL) CONDUCTORS SHALL TERMINATE ON THE NEUTRAL BUS & ALL EQUIPMENT GROUNDING CONDUCTOR SHALL TERMINATE ON THE GROUND BUS. ONE LUG OR TERMINAL PER CONDUCTOR.
- DO NOT BOND OR CONNECT THE GROUND (NEUTRAL) CONDUCTOR & THE EQUIPMENT GROUNDING CONDUCTOR TOGETHER AT ANY OTHER POINT IN THE ELECTRICAL SYSTEM EXCEPT AT SEPARATELY DERIVED SYSTEMS AS DEFINED IN THE NEC.
- GROUND RODS USED FOR GROUNDING ELECTRODE SYSTEMS SHALL BE COPPER CLAD, 3/4"x10" MIN. AND SHALL BE INSTALLED WITH TOP A MIN. OF 12" BELOW FINISHED GRADE. RESISTANCE TO GROUND SHALL NOT EXCEED 25 OHMS PER NEC.

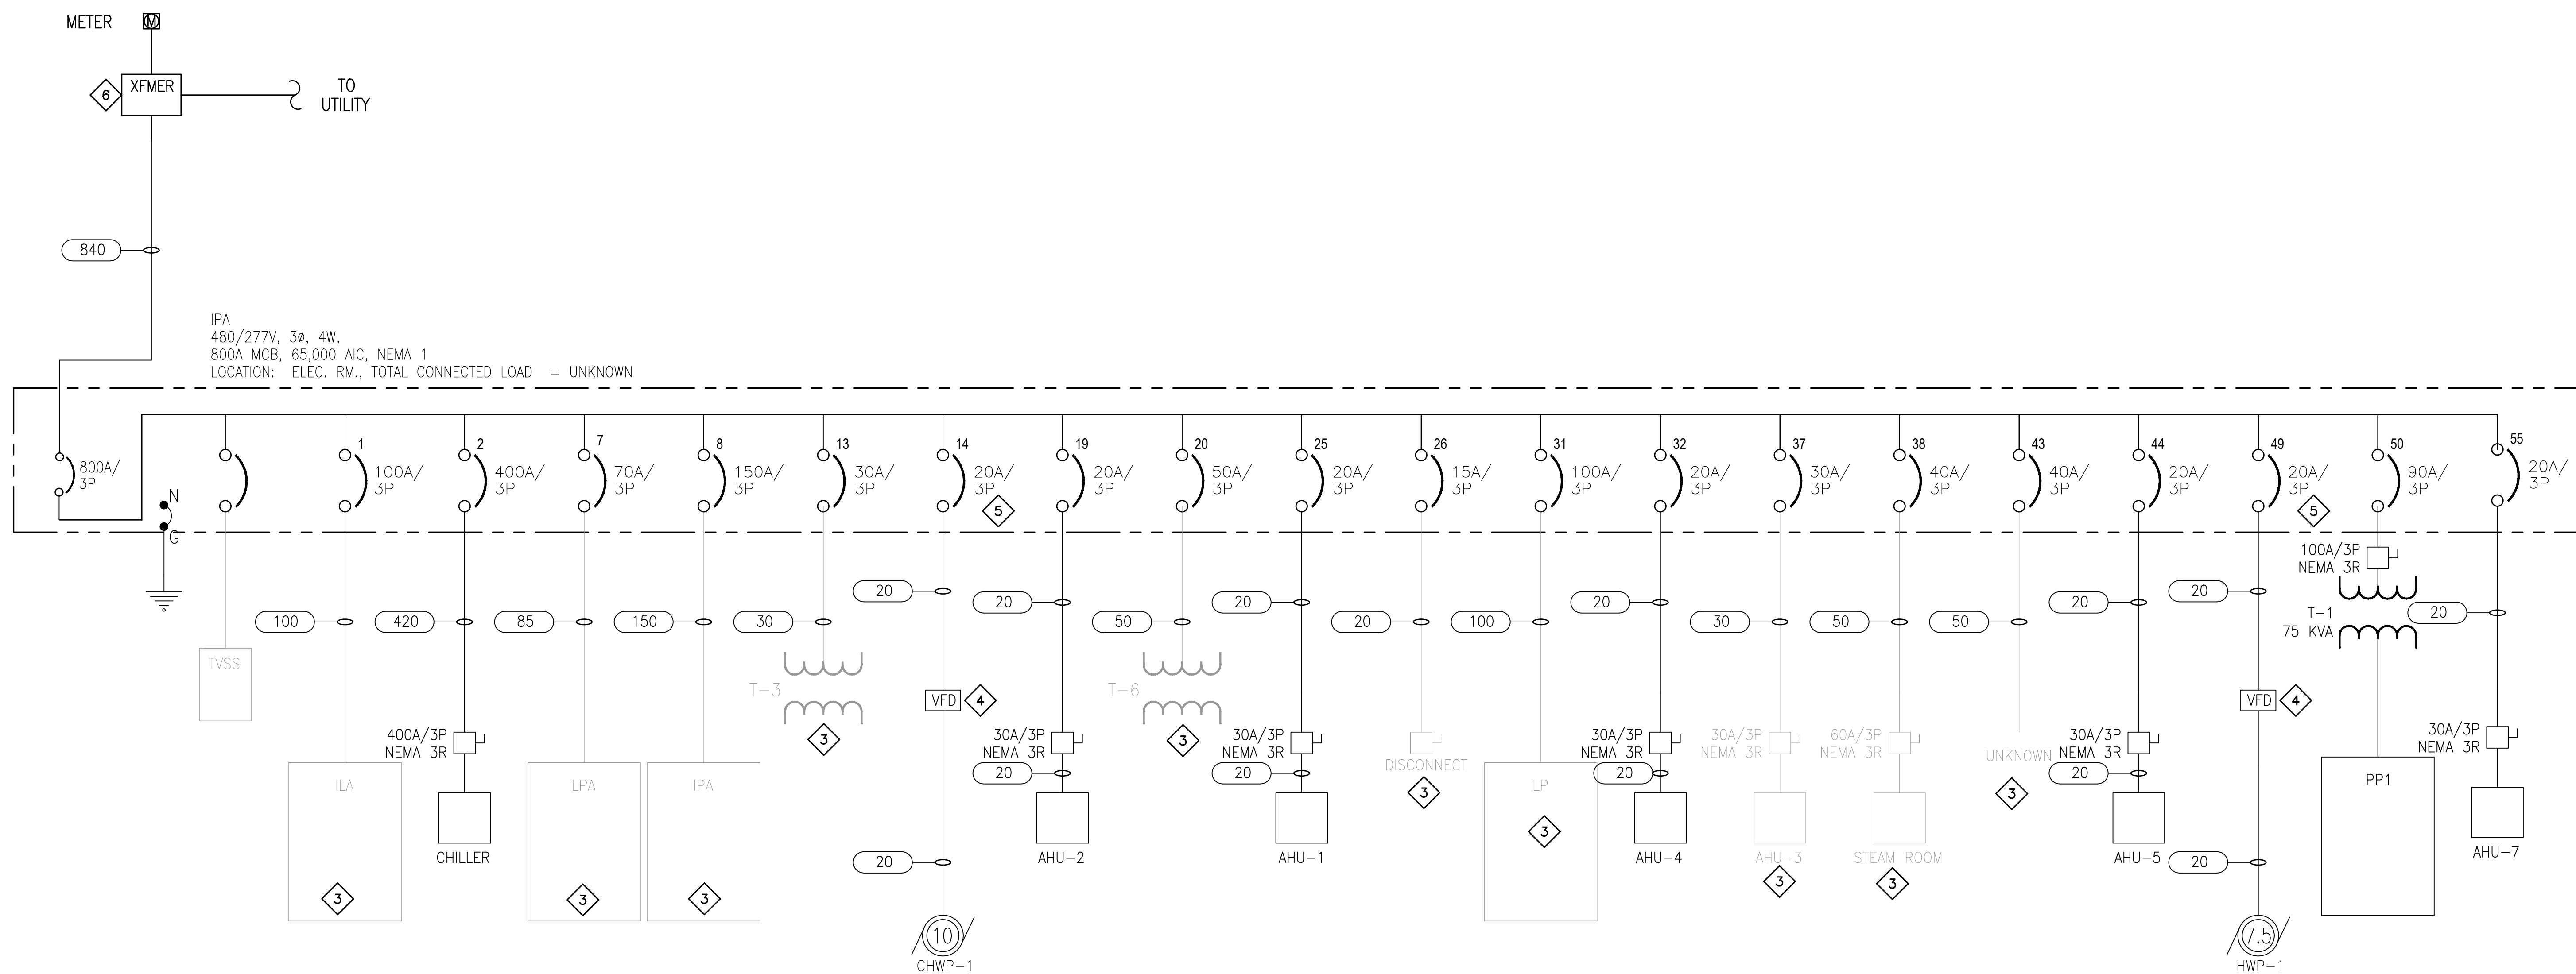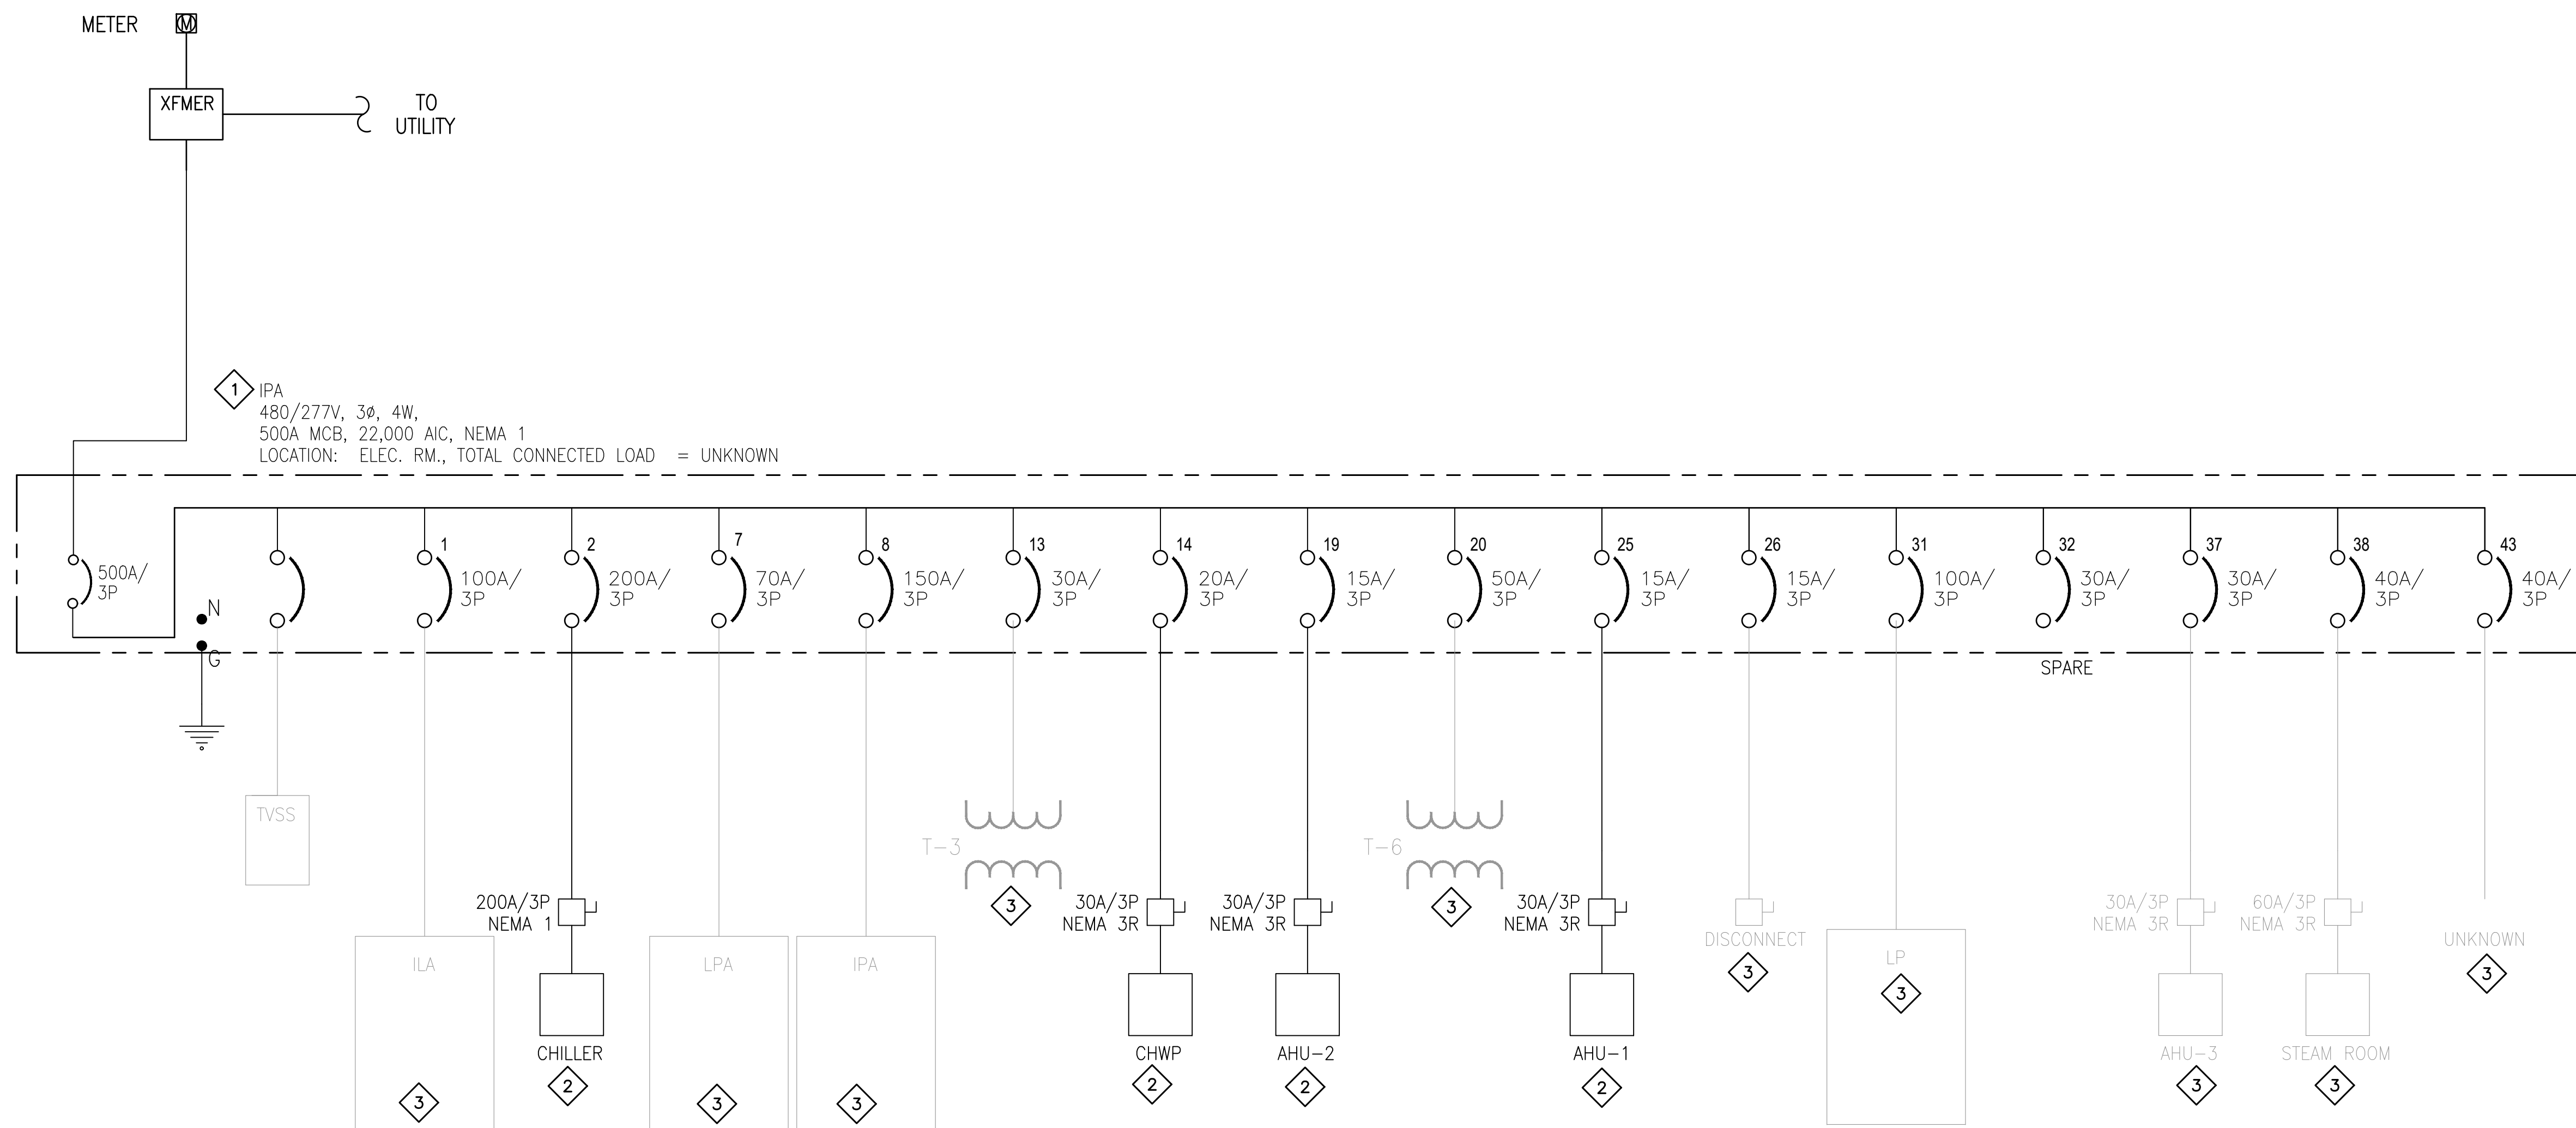

- DRAWING E601 SPECIFIC NOTES**
- 1 CONTRACTOR SHALL DEMOLISH EXISTING SWITCHBOARD. PRESERVE ALL BRANCH CIRCUITS FOR ANY DEVICES, EQUIPMENT, PANELBOARDS, ETC.
  - 2 CONTRACTOR SHALL DEMOLISH FEEDER AND CONTROLS TO MECHANICAL EQUIPMENT. COORDINATE DEMOLITION WITH THE MECHANICAL CONTRACTOR.
  - 3 EXISTING FEEDER TO REMAIN. CONTRACTOR SHALL RECONNECT TO NEW PANEL (PA). SPLICES ARE NOT ACCEPTABLE. PULL NEW WHERE REQUIRED.
  - 4 VFD WITH DISCONNECTING MEANS PROVIDED BY MECHANICAL CONTRACTOR, INSTALLED BY ELECTRICAL CONTRACTOR.
  - 5 CONTRACTOR SHALL COORDINATE BREAKER SIZE WITH MOTOR SUBMITTAL. BREAKER SHALL BE SIZED TO START THE MOTOR ACROSS THE LINE.
  - 6 EXISTING PAD MOUNT TRANSFORMER WILL NEED TO BE REMOVED IN ORDER TO INSTALL NEW CONDUIT. CONTRACTOR SHALL COORDINATE WITH KAFB CONTRACTING OFFICER FOR REMOVAL AND RE-INSTALLATION OF EXISTING PAD MOUNT TRANSFORMER. CONTRACTOR SHALL COORDINATE OUTAGES. CONTRACTOR SHALL GIVE OWNER 2 WEEK NOTIFICATION PRIOR TO OUTAGE AND OUTAGE MUST BE PERFORMED ON A WEEKEND.

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**ELECTRICAL ONE-LINE DIAGRAM**


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**E601**

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**ELECTRICAL PANEL SCHEDULES**

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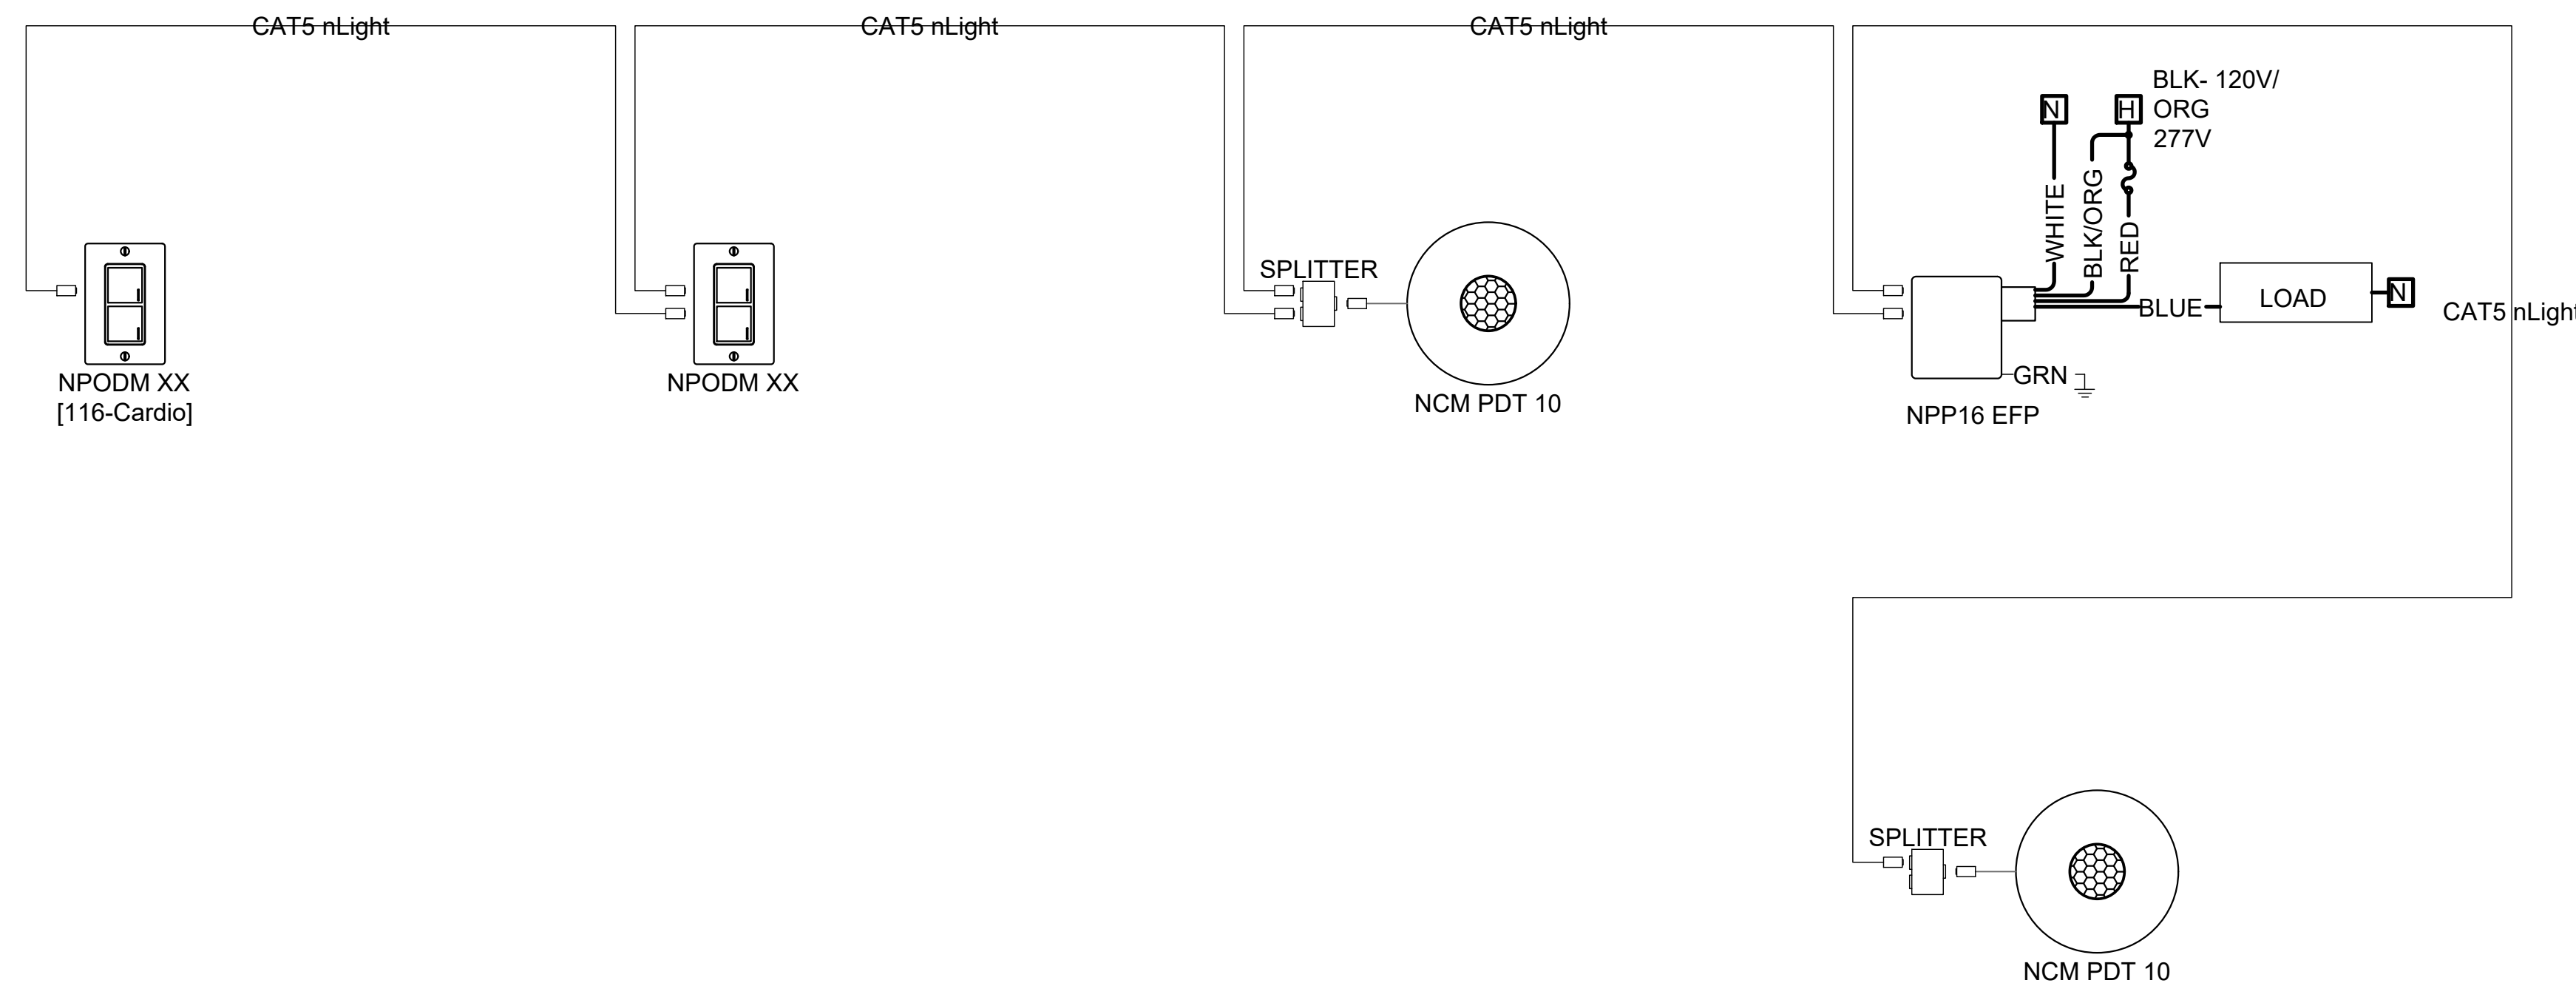
**E621**

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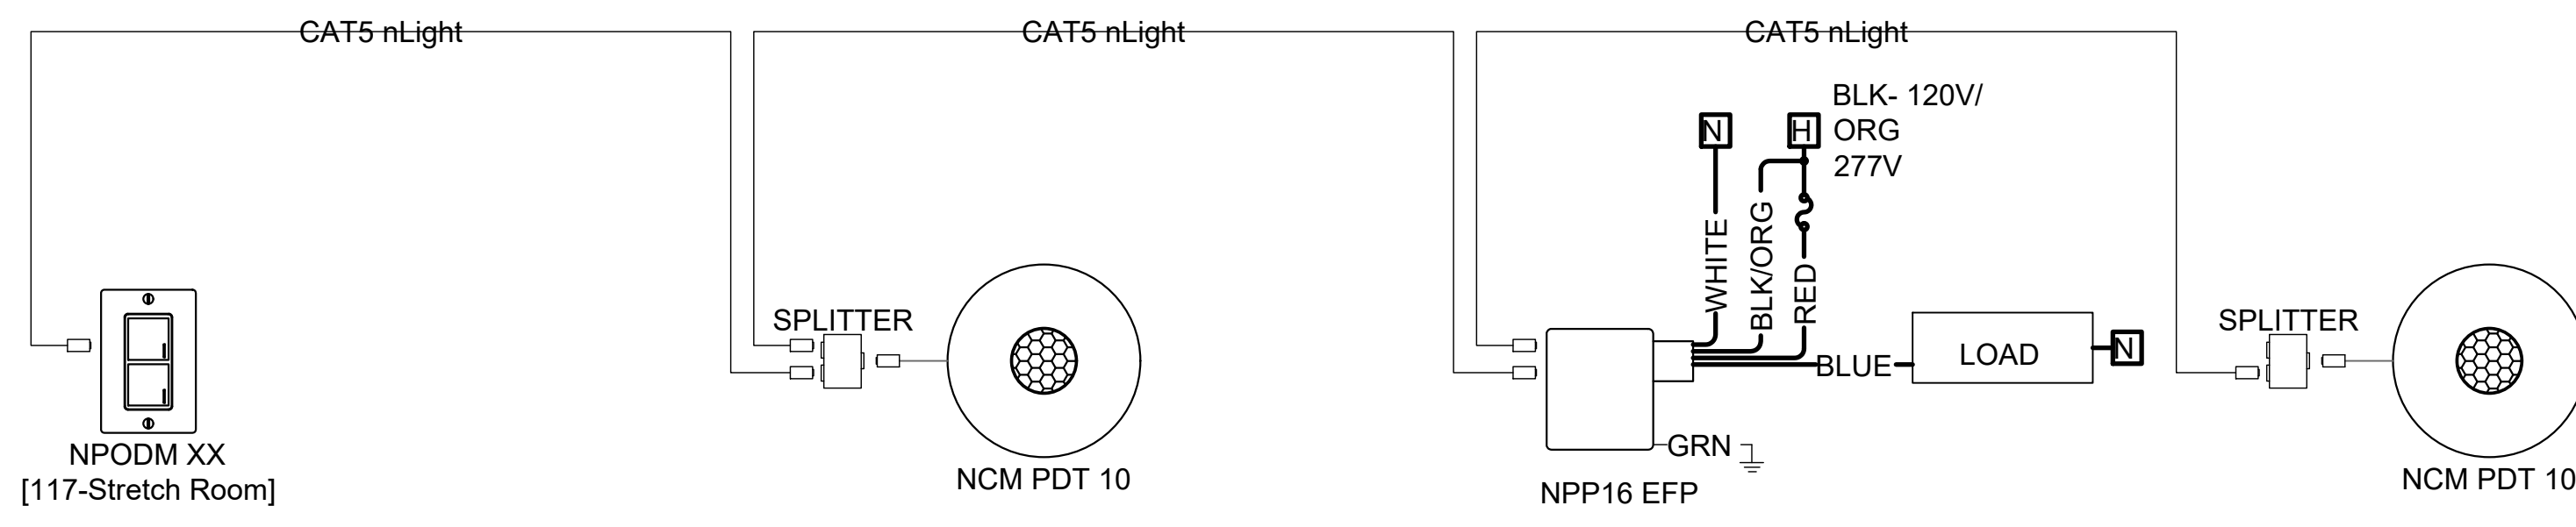
PP1											
ROOM MECH 115		VOLTS 208Y/120V 3P 4W			AIC 22,000						
MOUNTING SURFACE		BUS AMPS 225			MAIN BKR 225						
FED FROM T1		NEUTRAL 100%			LUGS STANDARD						
NOTE											
CKT #	CKT BKR	CIRCUIT DESCRIPTION	LOAD KVA			CKT #	CKT BKR	CIRCUIT DESCRIPTION	LOAD KVA		
			A	B	C				A	B	C
1	20/1	TV	0.36			2	20/1	RECEPTACLE	0.36		
3	20/1	TV		0.36		4	20/1	RECEPTACLE		0.72	
5	20/1	TV			0.18	6	20/1	WIREMOLD			0.18
7	20/1	WIREMOLD	0.18			8	20/1	WIREMOLD	0.18		0.18
9	20/1	WIREMOLD		0.18		10	20/1	WIREMOLD		0.18	
11	20/1	WIREMOLD			0.18	12	20/1	WIREMOLD			0.18
13	20/1	WIREMOLD	0.18			14	20/1	WIREMOLD	0.18		
15	20/1	WIREMOLD		0.18		16	20/1	TV		0.36	
17	20/1	WIREMOLD			0.18	18	20/1	TV			0.36
19	20/1	WIREMOLD	0.18			20	20/1	TV	0.18		
21	20/1	WIREMOLD		0.18		22	20/1	WIREMOLD		0.18	0.18
23	20/1	WIREMOLD			0.18	24	20/1	WIREMOLD			0.18
25	20/1	WIREMOLD	0.18			26	20/1	WIREMOLD	0.18		
27	20/1	TV		0.18		28	20/1	WIREMOLD		0.18	
29	20/1	RECEPTACLE			0.36	30	20/1	RECEPTACLE			0.36
31	20/1	RECEPTACLE	0.36			32	20/1	RECEPTACLE	0.36		
33	20/1	LIGHTING		1.67		34	20/1	LIGHTING		0.637	
35	20/1	LIGHTING			0.926	36	20/1	VAV-1			0.6
37	20/1	B-1	1.2			38	20/1	VAV-2	0.6		
39	20/1	B-2		1.2		40	20/1	VAV-3		0.6	
41	20/1	VAV-4			0.6	42	20/1	VAV-5			0.6
43	20/1	VAV-6	0.6			44	20/1	VAV-7	0.6		
45	20/1	EF-2		1.66		46	20/1	RECEPTACLE		0.36	
47	20/1	TV			0.36	48	20/1	RECEPTACLE			0.36
49	20/1	RECEPTACLE	0.36			50	20/1	LIGHTING	0.306		
51	20/1	RECEPTACLE		0.36		52	20/1	RECEPTACLE		0.36	
53	20/1	RECEPTACLE			0.18	54	25/2	CU-1			0.728
55	20/1	RECEPTACLE	0.36			56			0.728		
57	20/1	SPARE		0		58	20/1	SPARE		0	0
59	20/1	SPARE			0	60	20/1	SPARE			0
61	20/1	SPARE	0			62	20/1	SPARE	0		0
63	20/1	SPARE		0		64	20/1	SPARE		0	0
65	20/1	SPARE			0	66	20/1	SPARE			0
67	20/1	SPARE	0			68	20/1	SPARE	0		
69	20/1	SPARE		0		70	20/1	SPARE		0	0
71	20/1	SPARE			0	72	20/1	SPARE			0
73	20/1	SPARE	0			74	20/1	SPARE	0		
75	20/1	SPARE		0		76	20/1	SPARE		0	0
77	20/1	SPARE			0	78	20/1	SPARE			0
79	20/1	SPARE	0			80	20/1	SPARE	0		
81	20/1	SPARE		0		82	20/1	SPARE		0	0
83	20/1	SPARE			0	84	20/1	SPARE			0
<b>TOTAL CONNECTED KVA BY PHASE</b>									7.63	9.54	6.69
		<b>CONN KVA</b>	<b>CALC KVA</b>		<b>CONN KVA</b>	<b>CALC KVA</b>					
<b>LIGHTING</b>		3.54	4.42	(125%)	<b>MOTORS</b>	9.71	9.71	(100%)			
<b>LARGEST MOTOR</b>		1.66	0.414	(25%)	<b>RECEPTACLES</b>	10.6	10.3	(50%*10)			
					<b>TOTAL LOAD</b>		24.9				
					<b>BALANCED 3-PHASE LOAD</b>		69 A				

PRINTED: 4/23/2021 3:18 PM BY: Tyler Abell LAST SAVED: 4/23/2021 3:17 PM BY: Tabell  
 nc:\010\_sans\010.02002-Blake gym\06-electrical\02--production\01--production drawings\Blake gym\_dec.dwg

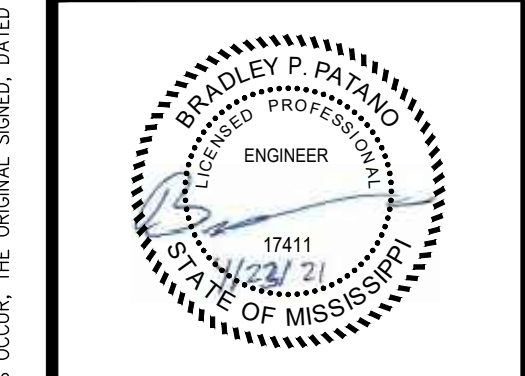
THE ORIGINAL SCALES, BAR IS ONE INCH ON ORIGINAL DRAWING. VERIFY SCALES. # NOT ONE INCH ON THIS SHEET, ADJUST SCALES ACCORDINGLY.




1 116 CARDIO  
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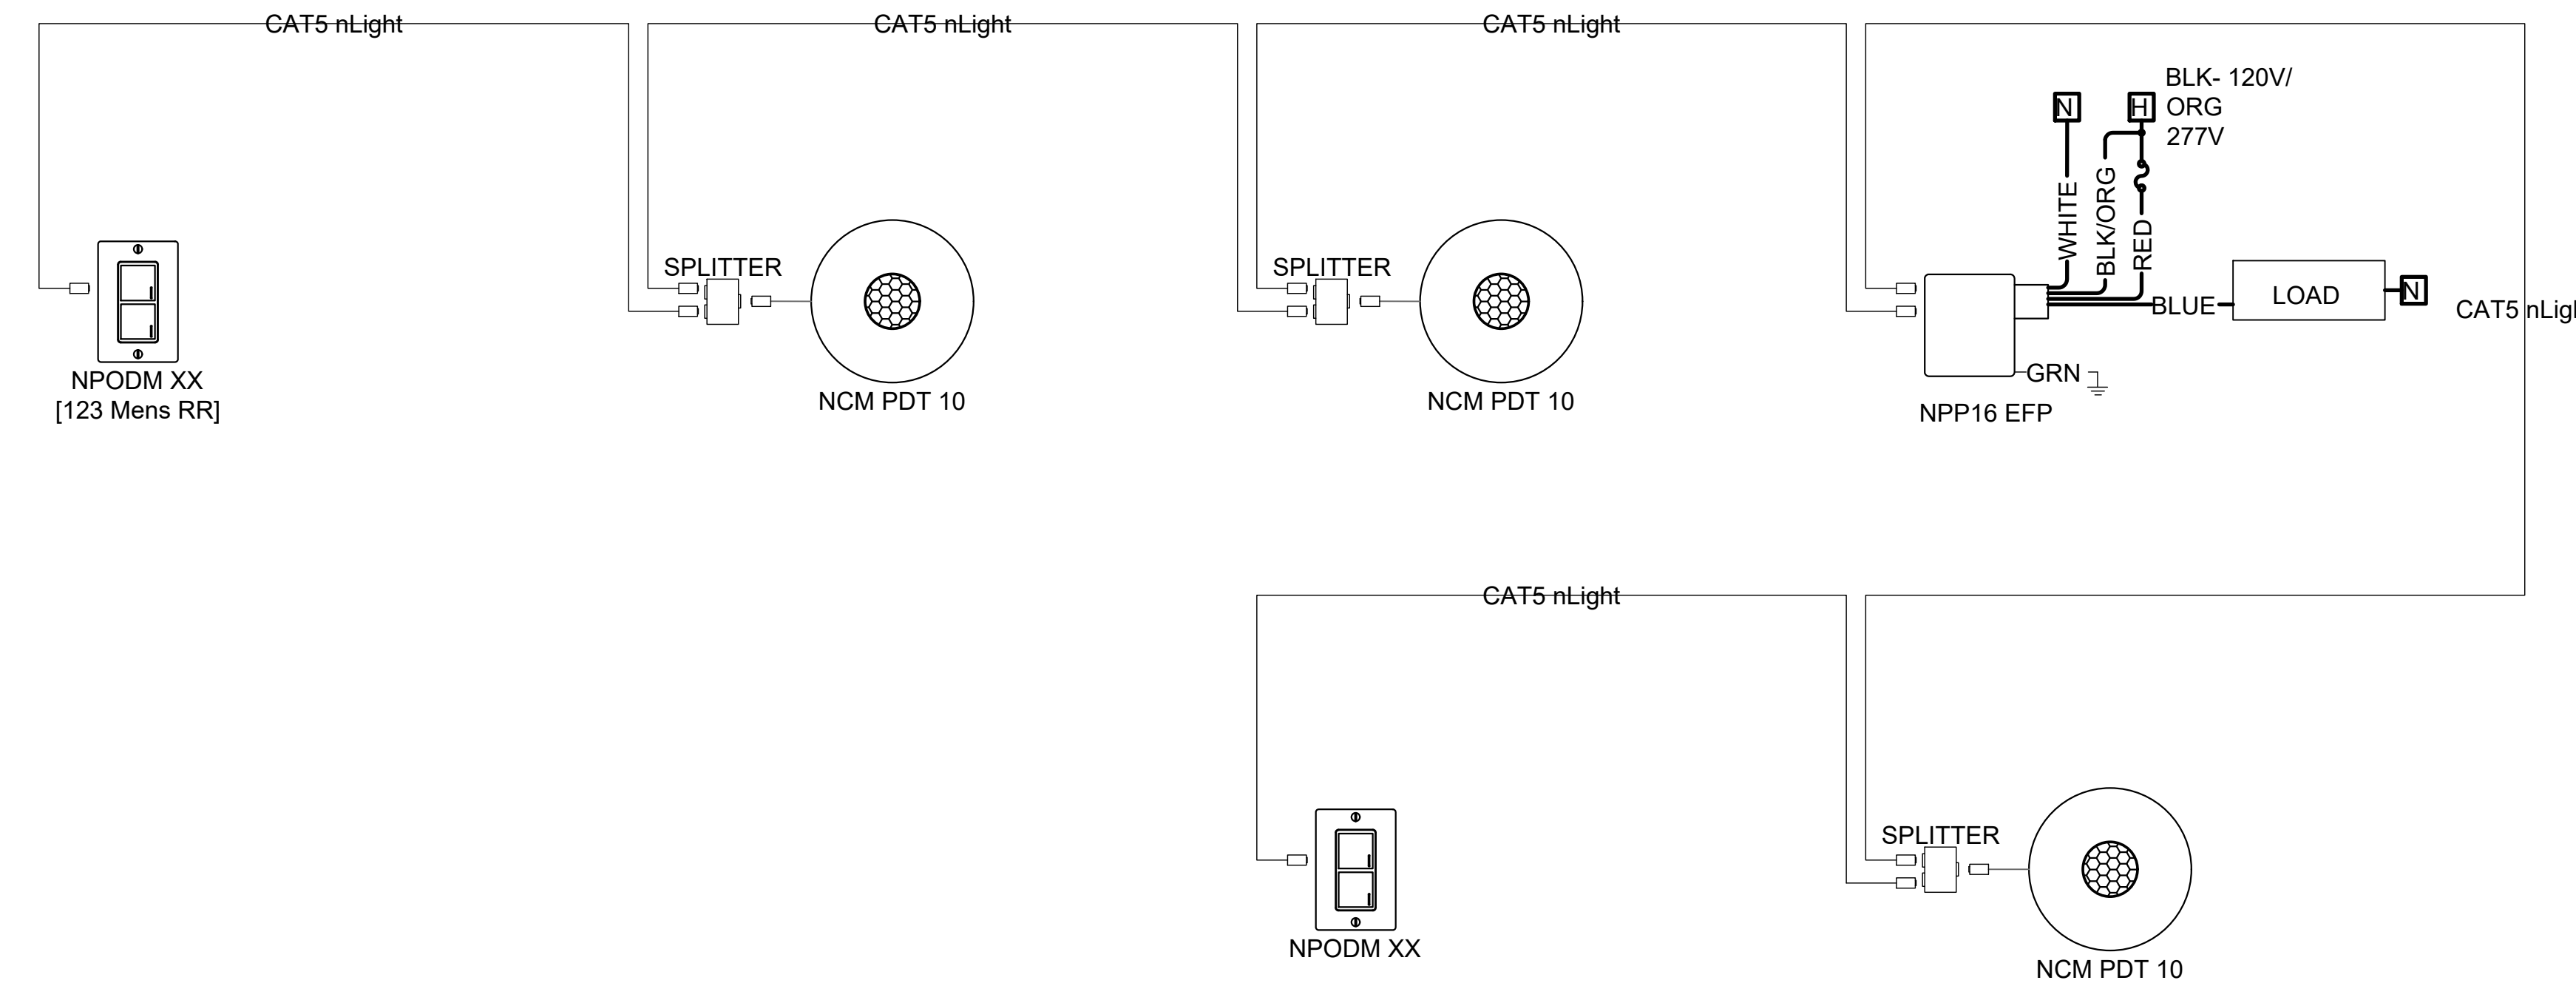
2 117 STRECH ROOM  
SCALE: NTS




3 120 WOMENS LOCKER  
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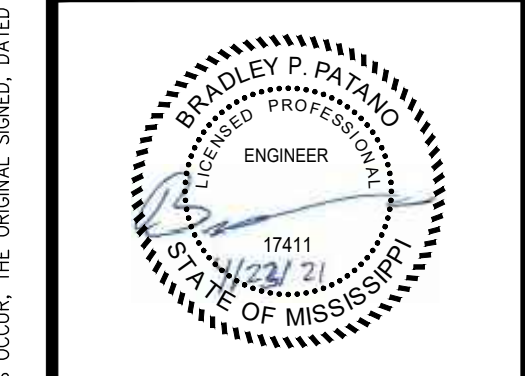
4 122 WOMENS  
SCALE: NTS

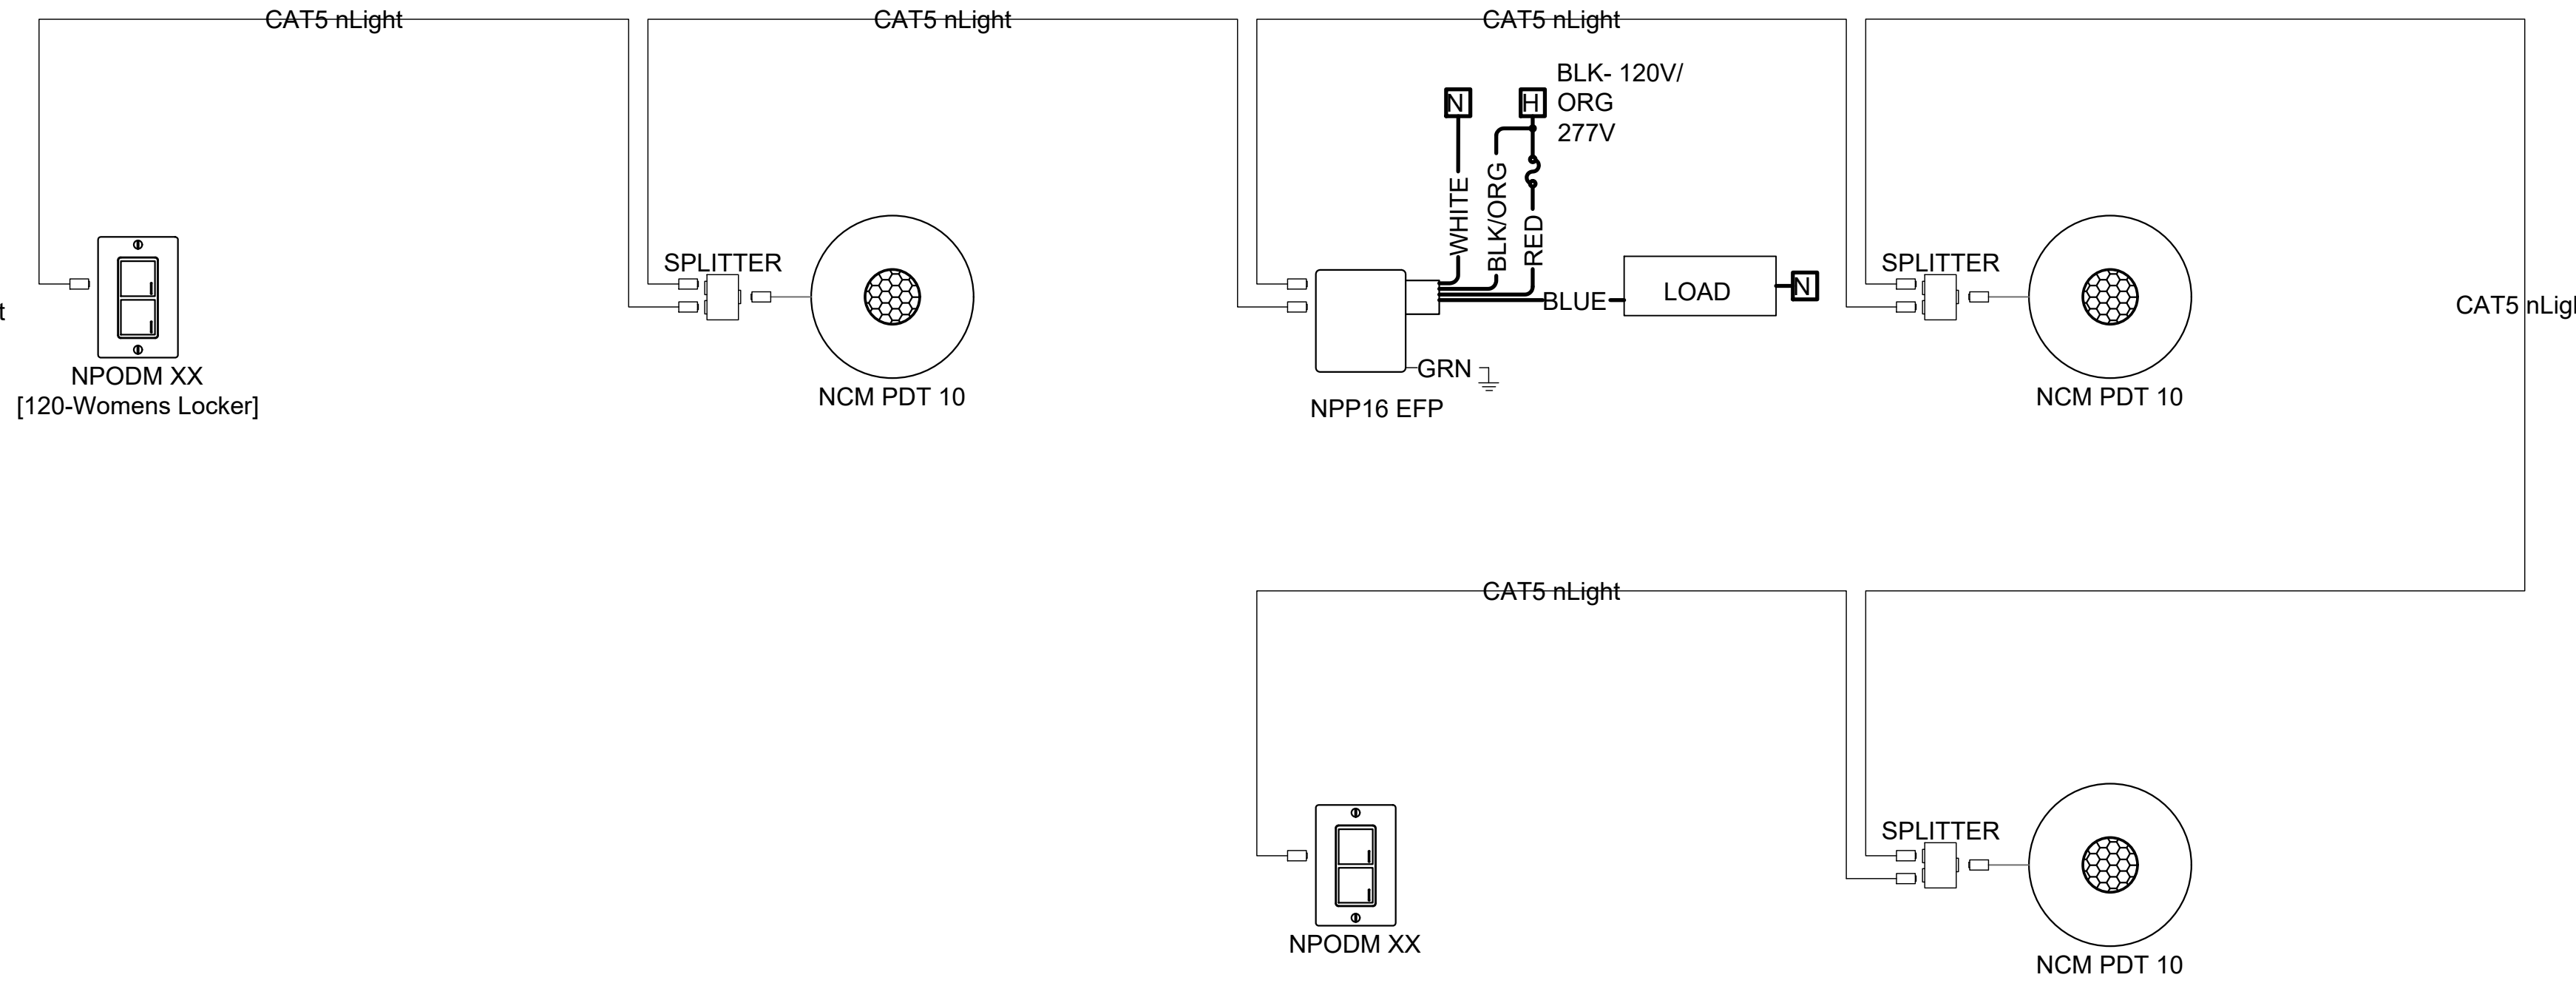

5 123 MENS RR  
SCALE: NTS

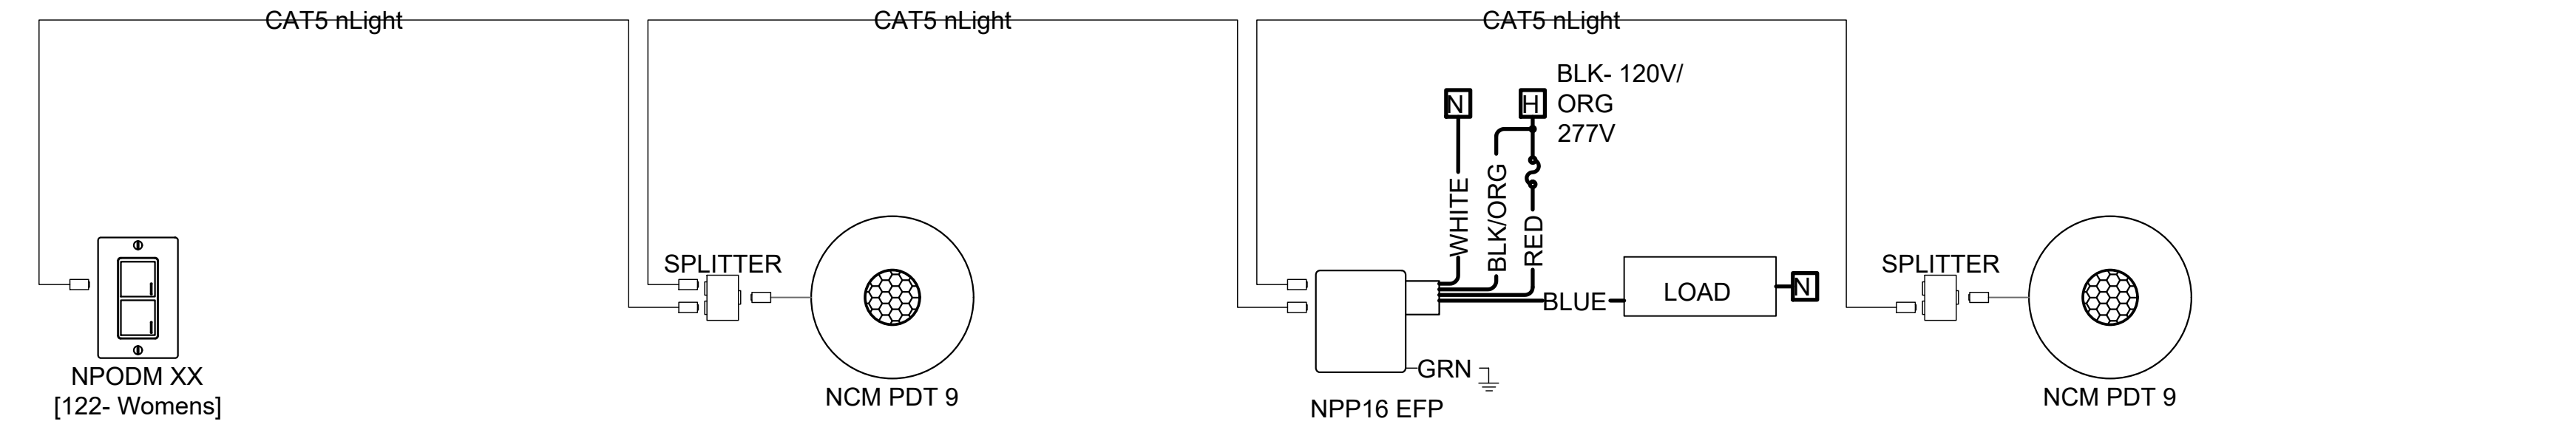

6 124 WOMENS RR  
SCALE: NTS

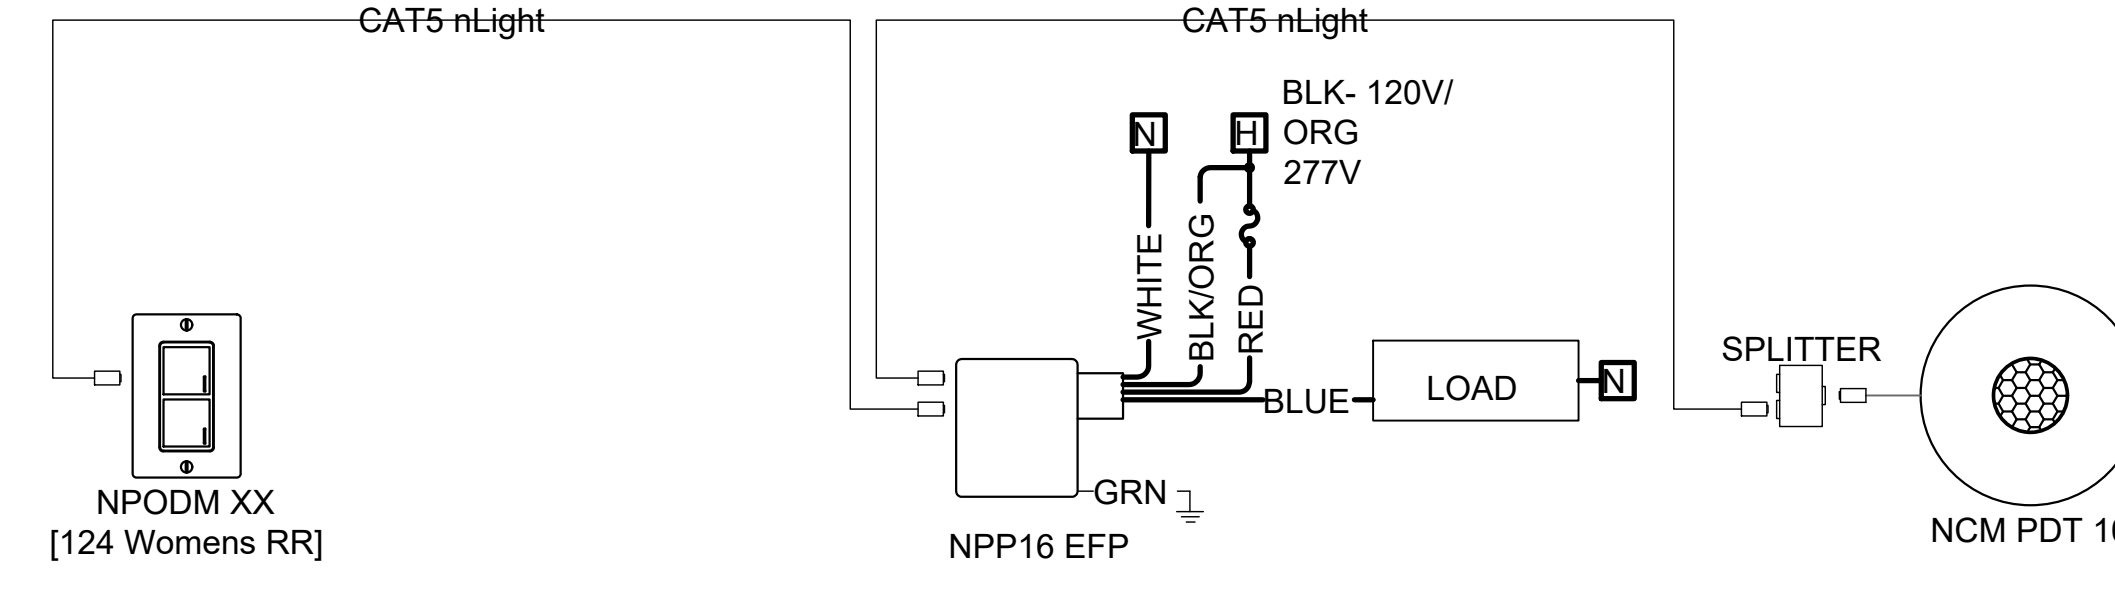

**MAHG 191089 REPAIR BLAKE GYM**  
**KEESLER AIR FORCE BASE**  
1201 H STREET, BLDG 1201  
KAFB - BILOXI, MS 39534

SCALE: AS INDICATED  
PROJECT NO: 0110.20.002  
DRAWN BY: TJA  
CHECKED BY: KBB


**ELECTRICAL LIGHTING CONTROL DIAGRAMS**

NO.	DATE	REVISION / SUBMITTAL
REV 0	4.23.2021	ISSUED FOR CONSTRUCTION

**E631**

VERIFY SCALES  
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**MAHG 191089 REPAIR BLAKE GYM**  
**KEESLER AIR FORCE BASE**  
1201 H STREET, BLDG 1201  
KAFB - BILOXI, MS 39534


SCALE: AS INDICATED  
PROJECT NO: 0110.20.002  
DRAWN BY: TJA  
CHECKED BY: KBB

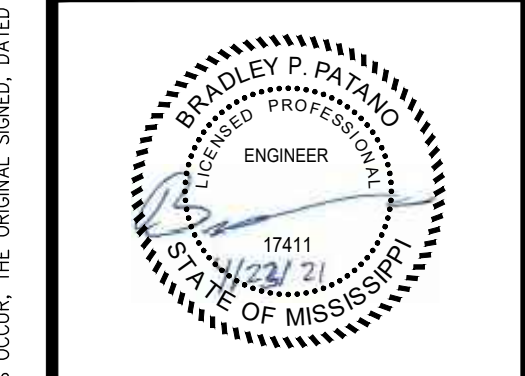**ELECTRICAL LIGHTING CONTROL DIAGRAMS**

NO.	DATE	REVISION / SUBMITTAL
REV 0	4/23/2021	ISSUED FOR CONSTRUCTION


**E632**

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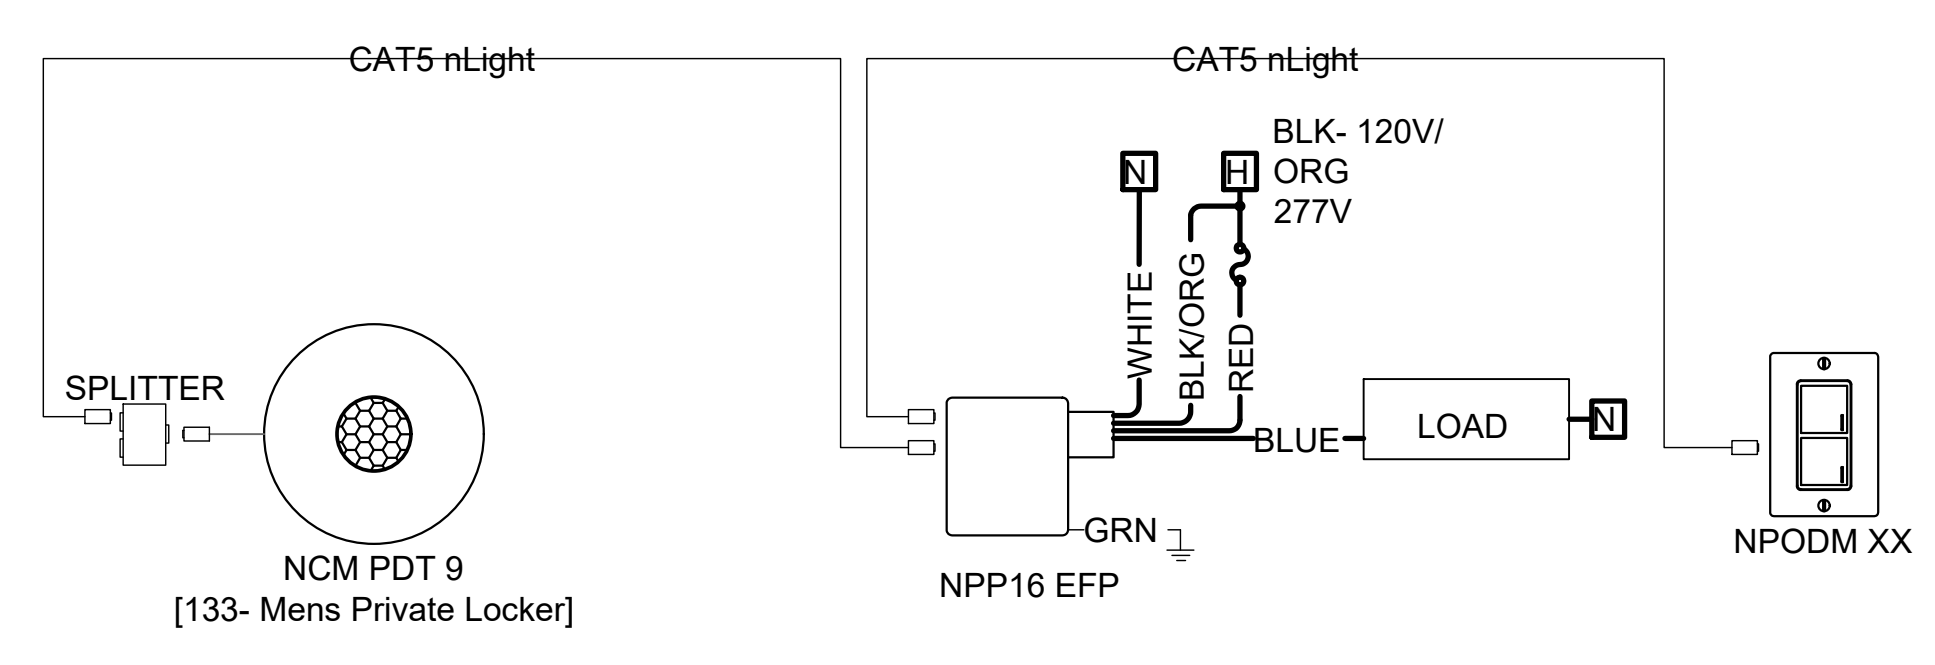
**1 128 MENS SHOWER**  
SCALE: NTS

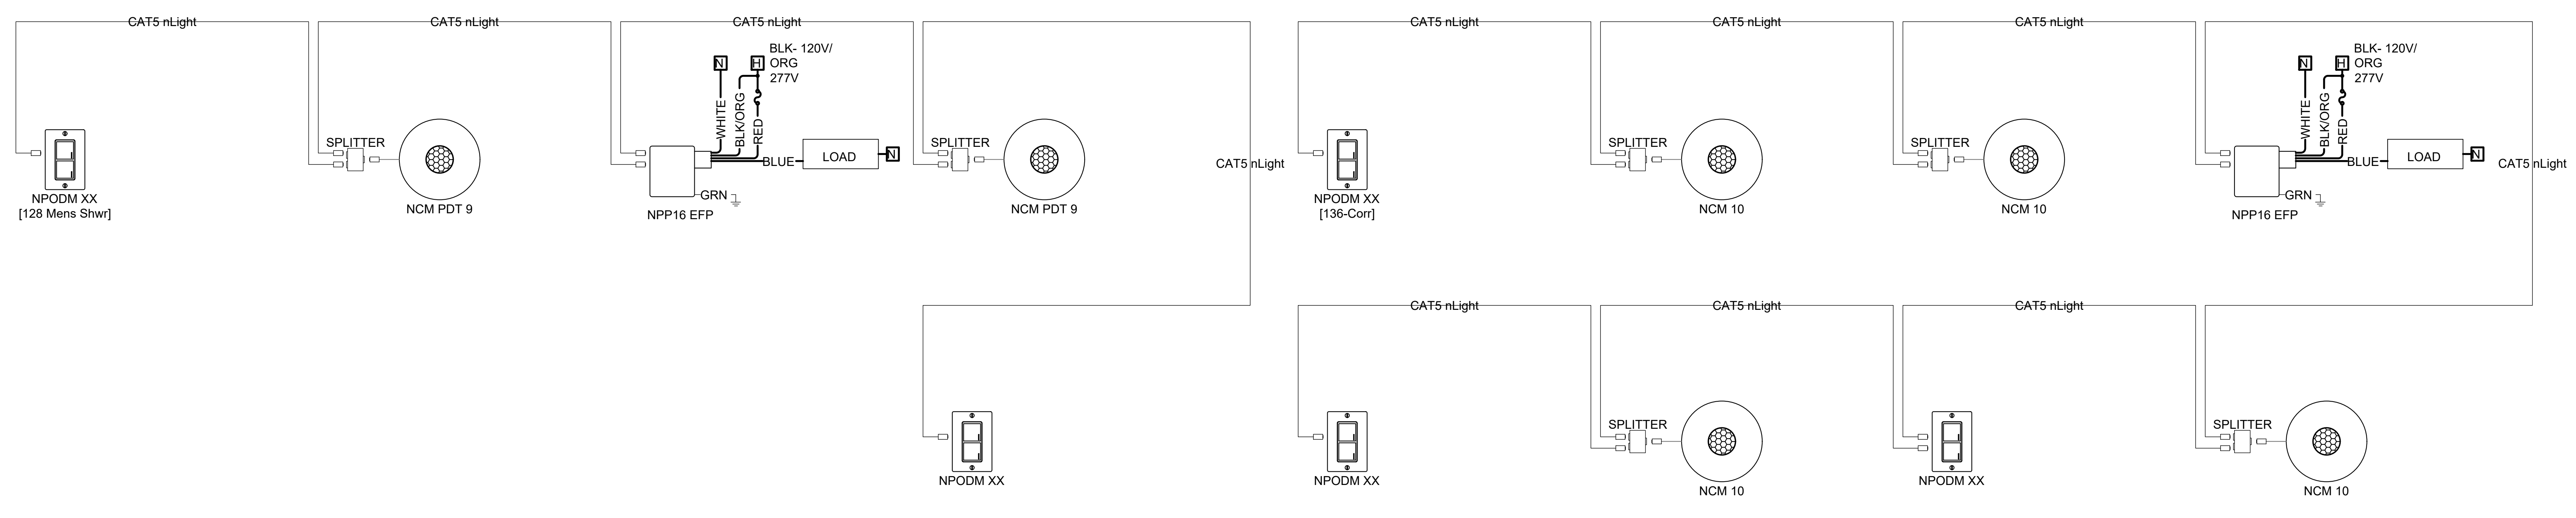**4 136 CORRIDOR**  
SCALE: NTS



**2 131 WOMENS SHOWER**  
SCALE: NTS

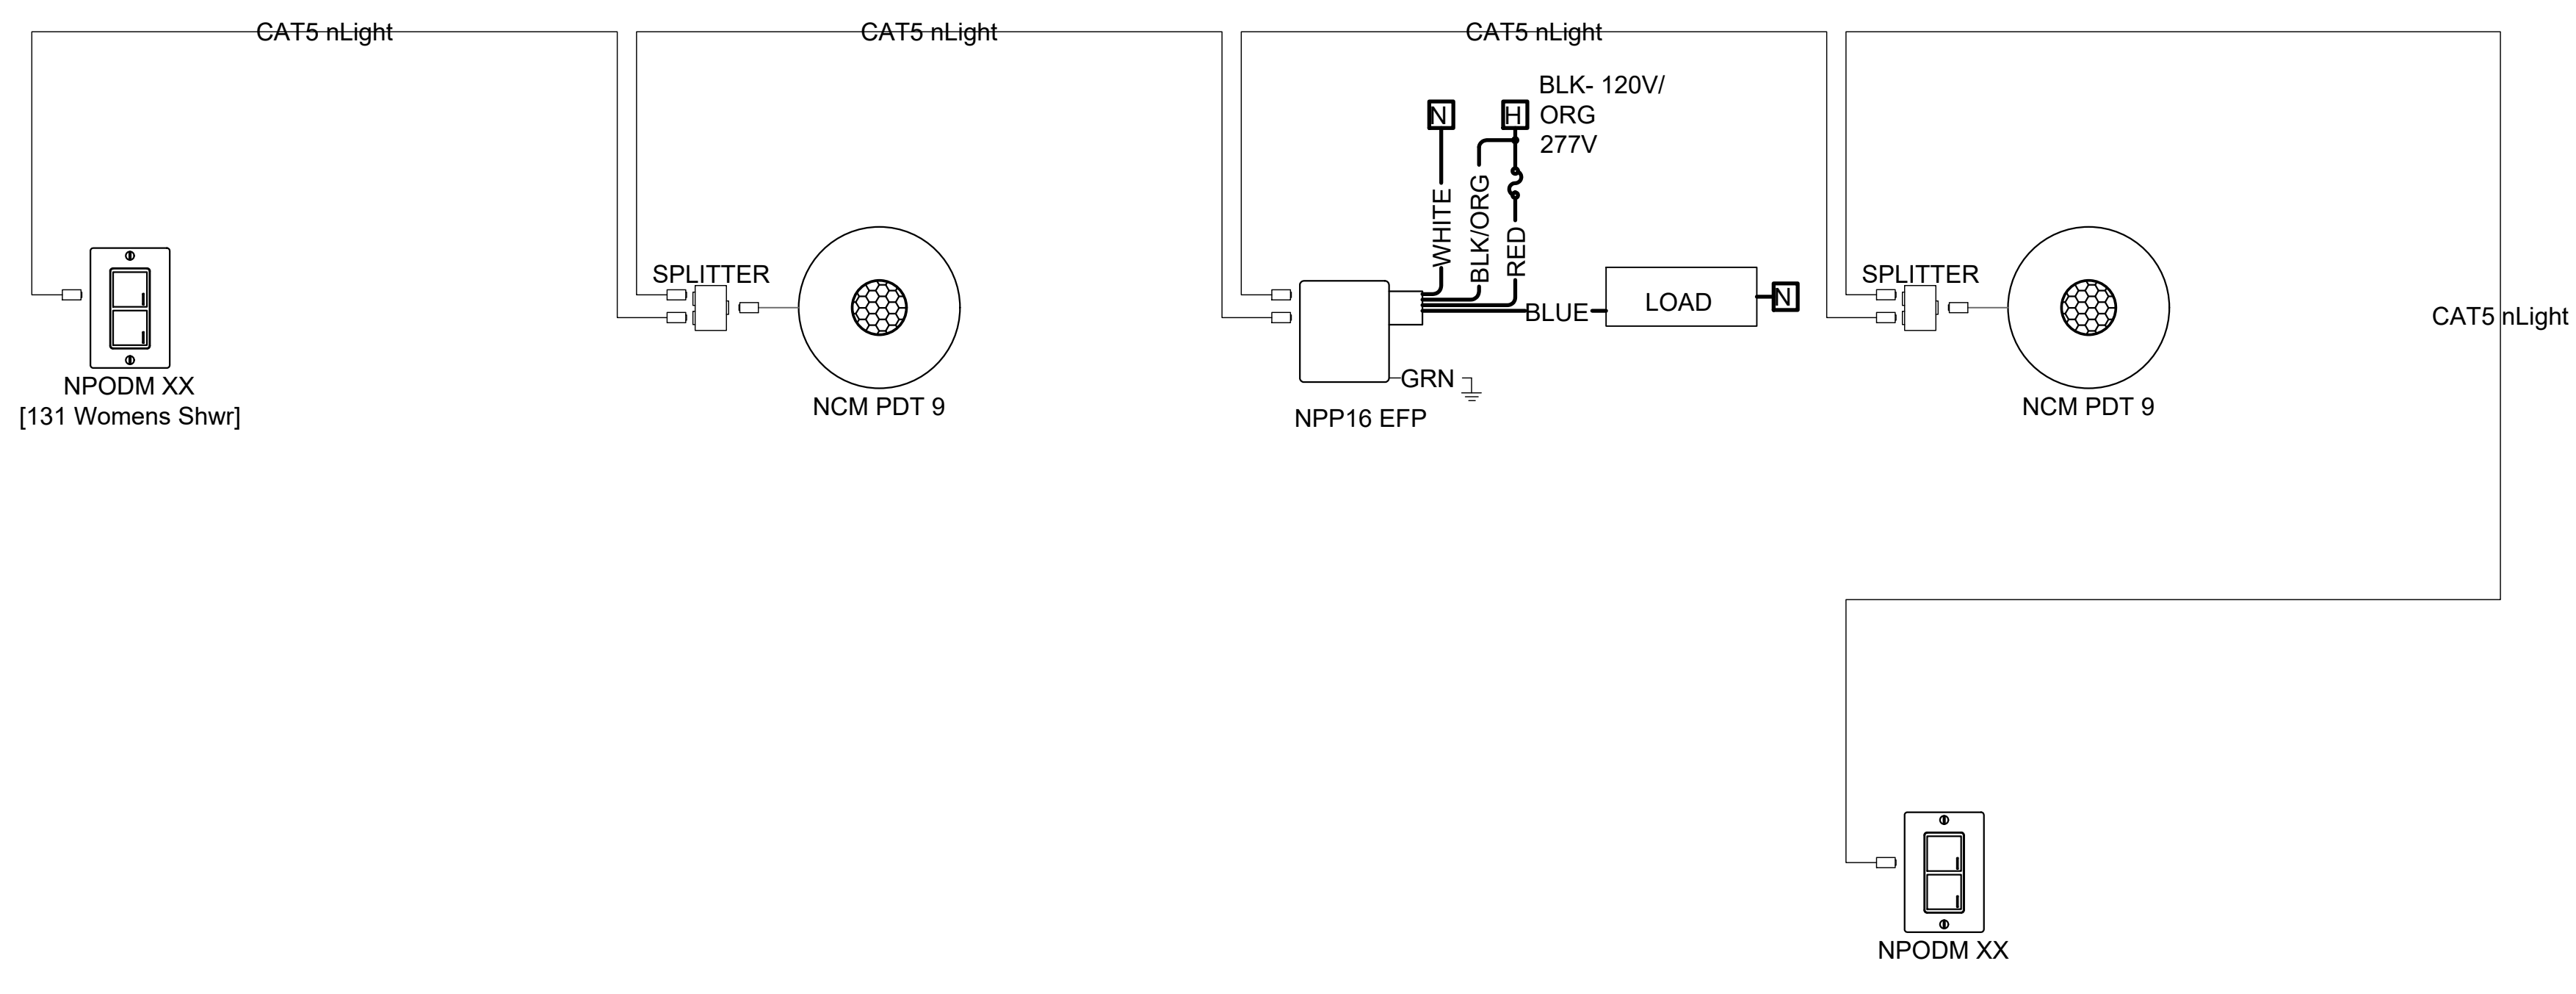**5 134 MENS LOCKER**  
SCALE: NTS



**3 133 MENS PRIVATE LOCKER**  
SCALE: NTS